


TREE PROTECTION NOTE

- ALL EXISTING TREES WHICH ARE TO REMAIN SHALL BE FULLY PROTECTED WITH HOARDING, ERECTED BEYOND THEIR DRIP LINE PRIOR TO THE ISSUANCE OF THE BUILDING PERMIT. GROUPS OF TREES AND OTHER EXISTING PLANTINGS TO BE PROTECTED SHALL BE TREATED IN A LIKE MANNER, WITH THE HOARDING AROUND THE ENTIRE CLUMP(S). AREAS WITHIN THE PROTECTIVE FENCING SHALL REMAIN UNDISTURBED AND SHALL NOT BE USED FOR THE STORAGE OF THE BUILDING MATERIAL AND EQUIPMENT.
- NO RIGGING CHAINS SHALL BE WRAPPED AROUND OR INSTALLED IN TREES AND SURPLUS SOIL, EQUIPMENT, DEBRIS OR MATERIALS SHALL NOT BE PLACED OVER ROOT SYSTEMS OF THE TREES WITHIN THE PROTECTIVE FENCING. NO CONTAMINANTS WILL BE DUMPED OR FLUSHED WHERE FEEDER ROOTS OF TREES EXIST.
- THE DEVELOPER OR HIS/HER/ITS AGENTS SHALL TAKE EVERY PRECAUTION NECESSARY TO PREVENT DAMAGE TO TREES OR SHRUBS TO BE RETAINED.
- WHERE LIMBS OR PORTIONS OF TREES ARE REMOVED TO ACCOMMODATE CONSTRUCTION WORK, THEY WILL BE REMOVED CAREFULLY IN ACCORDANCE WITH ACCEPTED ARBORICULTURAL PRACTICE.
- WHERE ROOT SYSTEMS OF PROTECTED TREES ARE EXPOSED DIRECTLY TO OR DAMAGED BY CONSTRUCTION WORK, THEY SHALL BE TRIMMED NEATLY AND THE AREA BACKFILLED WITH APPROPRIATE MATERIAL TO PREVENT DESICCATION.
- WHERE NECESSARY, THE TREES WILL BE GIVEN AN OVERALL PRUNING TO RESTORE THE BALANCE BETWEEN ROOTS AND TOP GROWTH OR TO RESTORE THE APPEARANCE OF THE TREES.
- IF GRADES AROUND TREES TO BE PROTECTED ARE LIKELY TO CHANGE, THE OWNER SHALL BE REQUIRED TO TAKE SUCH PRECAUTIONS AS DRY WELLS, RETAINING WALLS AND ROOT FEEDING TO THE SATISFACTION OF THE PLANNING AND BUILDING DEPARTMENT OF THE TOWN OF OAKVILLE.
- GRADE CHANGES WILL NOT OCCUR WITHIN THE TREE PROTECTION ZONE (TPZ).
- UTILITY ACCESS CORRIDOR MUST BE OUTSIDE THE TPZ.
- NO OPEN TRENCH METHOD OF CONSTRUCTION BELOW-GROUND AS WELL AS NO ABOVE-GROUND LINES WITHIN THE TPZ.

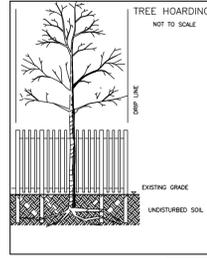




NOTE: TREE PROTECTION ZONES FOR THE PURPOSES OF THIS BY-LAW, THE TREE PROTECTION ZONE (TPZ) FOR ANY TREE SHALL BE DETERMINED AS FOLLOWS:

TRUNK DIAMETER (DBH)*	MINIMUM PROTECTION DISTANCES REQUIRED†
<10 CM	1.8 M
11-30 CM	2.4 M
31-50 CM	3.0 M
51-60 CM	3.6 M
61-70 CM	4.2 M
71-80 CM	4.8 M
81-90 CM	5.4 M
91-100+ CM	6.0 M

- DIAMETER AT BREAST HEIGHT (DBH) MEASUREMENT OF TREE TRUNK TAKEN 1.4 METERS ABOVE GROUND
- TREE PROTECTION ZONE DISTANCES ARE TO BE MEASURED FROM THE OUTSIDE EDGE OF THE TREE BASE TOWARDS THE DRIP LINE AND MAY BE LIMITED BY AN EXISTING PAVED SURFACE, PROVIDED THAT SURFACE REMAINS INTACT THROUGHOUT SITE ALTERATION

The existing sanitary lateral must be inspected at the property line by the Regional Inspector, and televised by Regional forces PRIOR to connection.
A lateral that does not meet current Regional standards must be disconnected at the main. A revision to the Service Permit, drawings and payment of applicable fees is required.

To re-use existing water service providing it meets Current Standards (otherwise, use proposed 25mm Copper Type-K water service)
The existing water service must be inspected at the property line by the Regional Inspector.

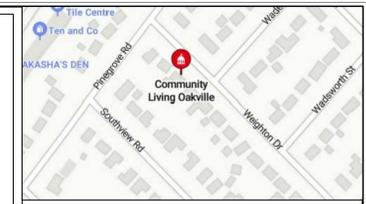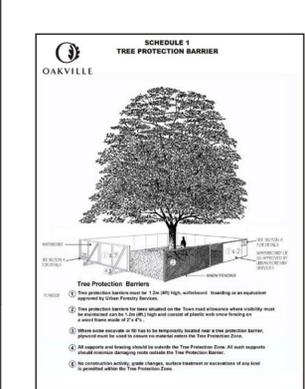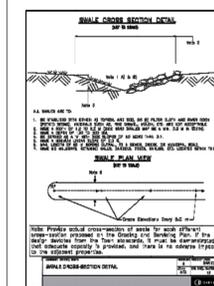

KEY PLAN (NOT TO SCALE)
SITE, GRADING & SERVICING PLAN
LOT 14
REGISTERED PLAN 835
TOWN OF OAKVILLE
REGIONAL MUNICIPALITY OF HALTON
SCALE 1 : 150
J.H. Gelbloom Surveying Limited
Ontario Land Surveyor
2025

METRIC Distances shown on this plan are in metres and can be converted to feet dividing by 0.3048.

ITEM DESCRIPTION	PERMITTED (METERS)	ACTUAL OR PROPOSED (METERS)
OAKVILLE BY-LAW	2014-014	
ZONING DESIGNATION	RL3-D	
LOT AREA (MINIMUM)	557.50 SQ.M.	715.72 SQ.M.
LOT FRONTAGE (MINIMUM)	18.00	18.29
LOT COVERAGE (MAXIMUM)	250.50 SQ.M.	243.86 SQ.M.
LOT COVERAGE % (MAXIMUM)	33%	33.07%
RFA (MAXIMUM)	293.44 SQ.M.	313.74 SQ.M.*
RFA/LOT RATIO (MAXIMUM)	41%	43.84%*
FRONT YARD SETBACK (MINIMUM)	8.25	8.28
SIDE YARD SETBACK (MINIMUM)	1.20 & 1.20	1.22 & 1.35
REAR YARD SETBACK (MINIMUM)	7.50	11.47
OVERALL HEIGHT	9.00	9.00

*SUBJECT TO COMMITTEE OF ADJUSTMENTS FILE NO. _____

LEGEND

CLF Chain Link Fence	INV. Invert Elevation
BF Board Fence	EG Established Grade
TFW Top of Foundation Wall	EG (92.58) Proposed Elevation
MH Maintenance Hole	
FF Finished Floor	T.B.R. To Be Removed
LF Utility Pole	TOS Top of Slope
DEC. Deciduous Tree	BOS Bottom of Slope
CON. Coniferous Tree	CSP Corrugated Steel Pipe
Ø Diameter	WV Water Valve
TOC Top of Curb	HW Hoarding
BOC Bottom of Curb	EW Existing Elevation
HP High Point	RW Rain Water Leader
TRW Top of Retaining Wall	EMB Embankment
BRW Bottom of Retaining Wall	TRW Retaining Wall
③ Arborist's Tree Number	X Tree to be Removed

SITE ADDRESS
388 WRIGHT DRIVE
OAKVILLE, ONTARIO

KABIR RAI (OWNER)
458 JEANETTE RIVE
OAKVILLE, ONTARIO

No.	Date	Description	By
1	DEC. 18, 2024	SITE PLAN	H.E.
2	MARCH 2, 2025	REVISED BUILDING PLANS	R.H.
3			

REVISIONS

INFORMATION TAKEN FROM A SURVEY PREPARED BY J.H. GELBLOOM SURVEYING LTD., O.L.S., DATED : NOVEMBER 20, 2024

BENCHMARK
Elevations are Refered to the Town of Oakville Benchmark No. 9 having an Elevation of 911.312 m.

SURVEYOR'S CERTIFICATE
I HAVE REVIEWED THE PLANS FOR THE CONSTRUCTION OF A TWO STOREY DWELLING LOCATED AT 388 WRIGHT DRIVE AND HAVE PREPARED THIS PLAN TO INDICATE THE COMPATIBILITY OF THE PROPOSAL WITH ALL ADJACENT PROPERTIES AND EXISTING MUNICIPAL SERVICES. IT IS MY BELIEF THAT ADHERENCE TO THE PROPOSED ELEVATIONS AND GRADIENTS SHOWN WILL PRODUCE ADEQUATE SURFACE DRAINAGE AND PROPER FACILITY OF THE MUNICIPAL SERVICES WITHOUT DETRIMENTAL EFFECT TO THE EXISTING DRAINAGE PATTERNS OF ADJACENT PROPERTIES.

I HEREBY CERTIFY THAT THE DIMENSIONS AND SET-BACKS ARE CORRECTLY SHOWN.

AS PER OBC 9.14.6.1(i) I CERTIFY THAT THE BUILDING WILL BE LOCATED AND THE SITE GRADING HAS BEEN DESIGNED SO THAT IT WILL NOT ADVERSELY AFFECT ADJACENT PROPERTIES.

March 4, 2025
DATE


Andrew Musy, O.L.S.
2025

Project: 24-196
Checked By: A.M.
Drawn By: H.E.
Party Chief: Y.S.


- (A) TRANSPORTATION AND WORKS DEPARTMENT**
- MUNICIPAL BOULEVARD TO BE RESTORED TO THE SATISFACTION OF ENGINEERING CONSTRUCTION STAFF.
 - RESTORE THE PUBLIC ROADWAY TO TOWN STANDARDS AND CLEARLY INDICATE ON THE ENGINEERING DRAWINGS ALL RESTORATION, TO THE SATISFACTION OF THE ENGINEERING & CONSTRUCTION DEPARTMENT.
 - DRIVEWAYS ON THE MUNICIPAL RIGHT-OF-WAY SHALL BE PAVED BY THE APPLICANT.
 - AT THE ENTRANCES TO THE SITE, THE MUNICIPAL CURB AND SIDEWALK WILL BE CONTINUOUS THROUGH THE DRIVEWAY AND A CURB DEPRESSION WILL BE PROVIDED FOR THE ENTRANCE.
 - THE TOPS OF ANY CURBS BORDERING THE DRIVEWAYS WITHIN THE MUNICIPAL BOULEVARD WILL BE FLUSH WITH THE MUNICIPAL SIDEWALK AND ROAD CURB.

- (B) GENERAL NOTES**
- THE EXISTING GRADES SHOWN ON THIS DRAWING ARE TO REMAIN UNCHANGED.
 - THERE ARE NO EASEMENTS REGISTERED ON TITLE AND AFFECTING THE SUBJECT LANDS.
 - THE STOCKPILING OF CONSTRUCTION MATERIAL TO BE DONE AT THE FRONT OF THE PROPOSED DWELLING ON THE EXISTING DRIVEWAY.
 - ALL ROOF DOWNSPOUTS FROM EAVESTROUGH TO DISCHARGE ONTO SURFACE AND THE RUNOFF DIRECTED TOWARDS THE REAR WHERE POSSIBLE AND TO THE ROAD.
 - ROOF DOWNSPOUT IS LOCATED IN SUCH MANNER AS TO DIRECT DRAINAGE AWAY FROM WALKWAYS, DRIVEWAYS OR PATIO AREAS.
 - MAINTAIN EXISTING GRADES IN AREA AROUND TREES TO BE PRESERVED.
 - PRIOR TO CONSTRUCTION, CONTRACTOR TO VERIFY IN FIELD THE EXACT SIZE AND INVERTS OF THE EXISTING WATER SERVICE CONNECTION AND SEWER CONNECTIONS AND REPORT IT TO THE ENGINEER.
 - ALL SURPLUS/EXCAVATED MATERIAL TO BE REMOVED FROM THE SITE.
 - CONTRACTOR TO MATCH EXISTING GRADES ALONG PROPERTY LINES.
 - ALL DISTURBED AREAS WITHIN EXISTING ROAD ALLOWANCE TO BE REINSTATED WITH TOPSOIL AND SOD TO THE SATISFACTION OF THE TOWN OF OAKVILLE.
 - THE CONTRACTOR IS TO CHECK AND VERIFY ALL DIMENSIONS, IF ANY DISCREPANCIES, THEY MUST BE REPORTED TO THE ENGINEER IMMEDIATELY PRIOR TO CONSTRUCTION.
 - THE CONTRACTOR IS RESPONSIBLE FOR LOCATING AND PROTECTING ALL UTILITIES DURING CONSTRUCTION. GAS, HYDRO, TELEPHONE OR ANY OTHER UTILITIES THAT MAY EXIST ON THE SITE OR WITHIN THE STREETLINE MUST BE LOCATED BY ITS OWN UTILITIES AND VERIFIED PRIOR TO CONSTRUCTION.
 - ALL CONNECTIONS SHALL BE INSTALLED AS PER REGION OF HALTON STANDARDS AND SPECIFICATIONS.
 - BUILDER IS TO VERIFY TO THE ENGINEER THAT THE FINAL FOOTING ELEVATION AND TOP OF FOUNDATION WALL ELEVATION ARE IN CONFORMITY WITH THE BUILDING CODE AND THE CERTIFIED GRADING PLAN PRIOR TO PROCEEDING.
 - OUTSIDE FINISHED GRADE TO BE A MINIMUM OF 150 mm BELOW BRICK/STONE VENEER ELEVATION.
 - PRIOR TO ANY SODDING, THE BUILDER IS TO ENSURE TO THE SOIL CONSULTANT AND/OR THE ENGINEER THAT THE LOT HAS BEEN GRADED AND TOPSOILED AND SODDED COMPLETELY WITH A MINIMUM DEPTH OF 200 mm OF TOPSOIL AND N° 1 NURSERY SOD AND A MINIMUM DEPTH OF 150 mm CRUSHED STONE TO BE PROVIDED ON THE ENTIRE LENGTH OF EACH DRIVEWAY ON A FIRM SUBGRADE AND THE DRIVEWAY TO BE PAVED WITH A MINIMUM COMPACTED DEPTH OF 75 mm OF ASPHALT BETWEEN THE CURB AND THE GARAGE.
 - NO SODDING ON ANY LOT IS PERMITTED UNTIL PRELIMINARY INSPECTION IS DONE BY THE ENGINEER AND THE BUILDER.
 - DRIVEWAY GRADES SHOULD BE NOT LESS THAN 1.0% AND NOT GREATER THAN 7.0%.
 - LAWN AND SWALES SHALL HAVE MINIMUM SLOPE OF 2.0% AND A MAXIMUM SLOPE OF 5.0% AND HAVE A MINIMUM DEPTH OF 150mm.
 - WHERE GRADES IN EXCESS OF 5.0% ARE REQUIRED, THE MAXIMUM SLOPE SHALL BE 3:1. GRADE CHANGES IN EXCESS OF 1.0 m ARE TO BE ACCOMPLISHED BY USE OF A RETAINING WALL. RETAINING WALLS HIGHER THAN 0.6 m SHALL HAVE A FENCE INSTALLED ON THE HIGH SIDE.
 - THE SERVICE CONNECTION TRENCH THROUGH THE TRAVELLED PORTION OF THE ROAD ALLOWANCE SHALL BE BACKFILLED WITH UNSHRINKABLE BACKFILL MATERIAL AS PER TOWN OF OAKVILLE STANDARDS UNLESS OTHERWISE SPECIFIED PRIOR APPROVAL FOR OTHER BACKFILL MATERIAL HAS BEEN OBTAIN.
 - ALL WATERMAINS AND WATER SERVICE MATERIALS AND CONSTRUCTION METHODS MUST CORRESPOND TO CURRENT REGION OF HALTON STANDARDS AND SPECIFICATIONS.
 - WATERMAINS AND/OR WATER SERVICES ARE TO HAVE A MINIMUM DEPTH OF 1.7 m WITH A MINIMUM HORIZONTAL SPACING OF 2.5 m FROM THEMSELVES AND OTHER SERVICES.
 - SEDIMENT CONTROL FENCE TO BE INSTALLED AS PER THE TOWN OF OAKVILLE STANDARDS.
 - ALL DAMAGED AND DISTURBED AREAS TO BE REINSTATED WITH TOPSOIL AND SOD.

- EROSION AND SILTATION NOTES**
- ALL EROSION AND SEDIMENT CONTROLS ARE TO BE INSTALLED ACCORDING TO APPROVED PLANS TO COMMENCEMENT OF ANY EARTH MOVING WORK ON THE SITE AND SHALL REMAIN IN PLACE UNTIL A DISTURBED AREAS ARE STABILIZED WITH THE INTENDED FINAL GROUND COVER.
 - EROSION AND SEDIMENT CONTROLS SHALL BE INSPECTED BY THE BUILDER/DEVELOPER.
 - WEEKLY
 - BEFORE AND AFTER ANY PREDICTED RAINFALL EVENT
 - FOLLOWING AN UNPREDICTED RAINFALL EVENT
 - DAILY, DURING EXTENDED DURATION RAINFALL EVENTS
 - AFTER SIGNIFICANT SNOW MELT EVENTS
 - EROSION AND SEDIMENT CONTROLS SHALL BE MAINTAINED IN PROPER WORKING ORDER AT ALL TIMES. DAMAGED OR CLOGGED DEVICES SHALL BE REPAIRED WITH 48 HOURS.
 - WHERE A SITE REQUIRES DEWATERING AND WHERE THE EXPELLED WATER CAN BE FREELY RELEASED TO A SUITABLE RECEIVER, THE EXPELLED WATER SHALL BE TREATED TO CAPTURE SUSPENDED PARTICLES GREATER THAN 40 MICRON IN SIZE. THE CAPTURED SEDIMENT SHALL BE DISPOSED OF PROPERLY PER MOECC GUIDELINES. THE CLEAN EXPELLED WATER SHALL BE FREELY RELEASED TO A SUITABLE RECEIVER IN MANNER THAT DOES NOT CREATE DOWNSTREAM ISSUES INCLUDING BUT NOT LIMITED TO EROSION, FLOODING, NUISANCE OR OTHERWISE.
 - EXISTING STORM SEWERS AND DRAINAGE DITCHES ADJACENT TO THE WORKS SHALL BE PROTECTED AT ALL TIMES FROM THE ENTRY OF SEDIMENT/SILT THAT MAY MIGRATE FROM THE SITE. FOR STORM SEWERS: ALL INLETS (REAR LOT CATCHBASINS, ROAD CATCHBASINS, PIPE INLETS, ETC.) MUST BE SECURED/FITTED WITH SILTATION CONTROL MEASURES. FOR DRAINAGE DITCHES: THE INSTALLATION OF ROCK CHECK DAMS, SILTATION FENCING, SEDIMENT CONTAINMENT DEVICES MUST BE INSTALLED TO TRAP AND CONTAIN SEDIMENT. THESE SILTATION CONTROL DEVICES SHALL BE INSPECTED AND MAINTAINED PER ITEMS 2 AND 3 ABOVE.
 - IN THE EVENT OF A SPILL (RELEASE OF DELETERIOUS MATERIAL) ON OR EMANATING FROM THE SITE, THE OWNER AGENT SHALL IMMEDIATELY NOTIFY THE MOECC AND FOLLOW AN PRESCRIBED CLEAN UP PROCEDURE. THE OWNER OR OWNERS AGENT WILL ADDITIONALLY IMMEDIATELY NOTIFY THE TOWN.

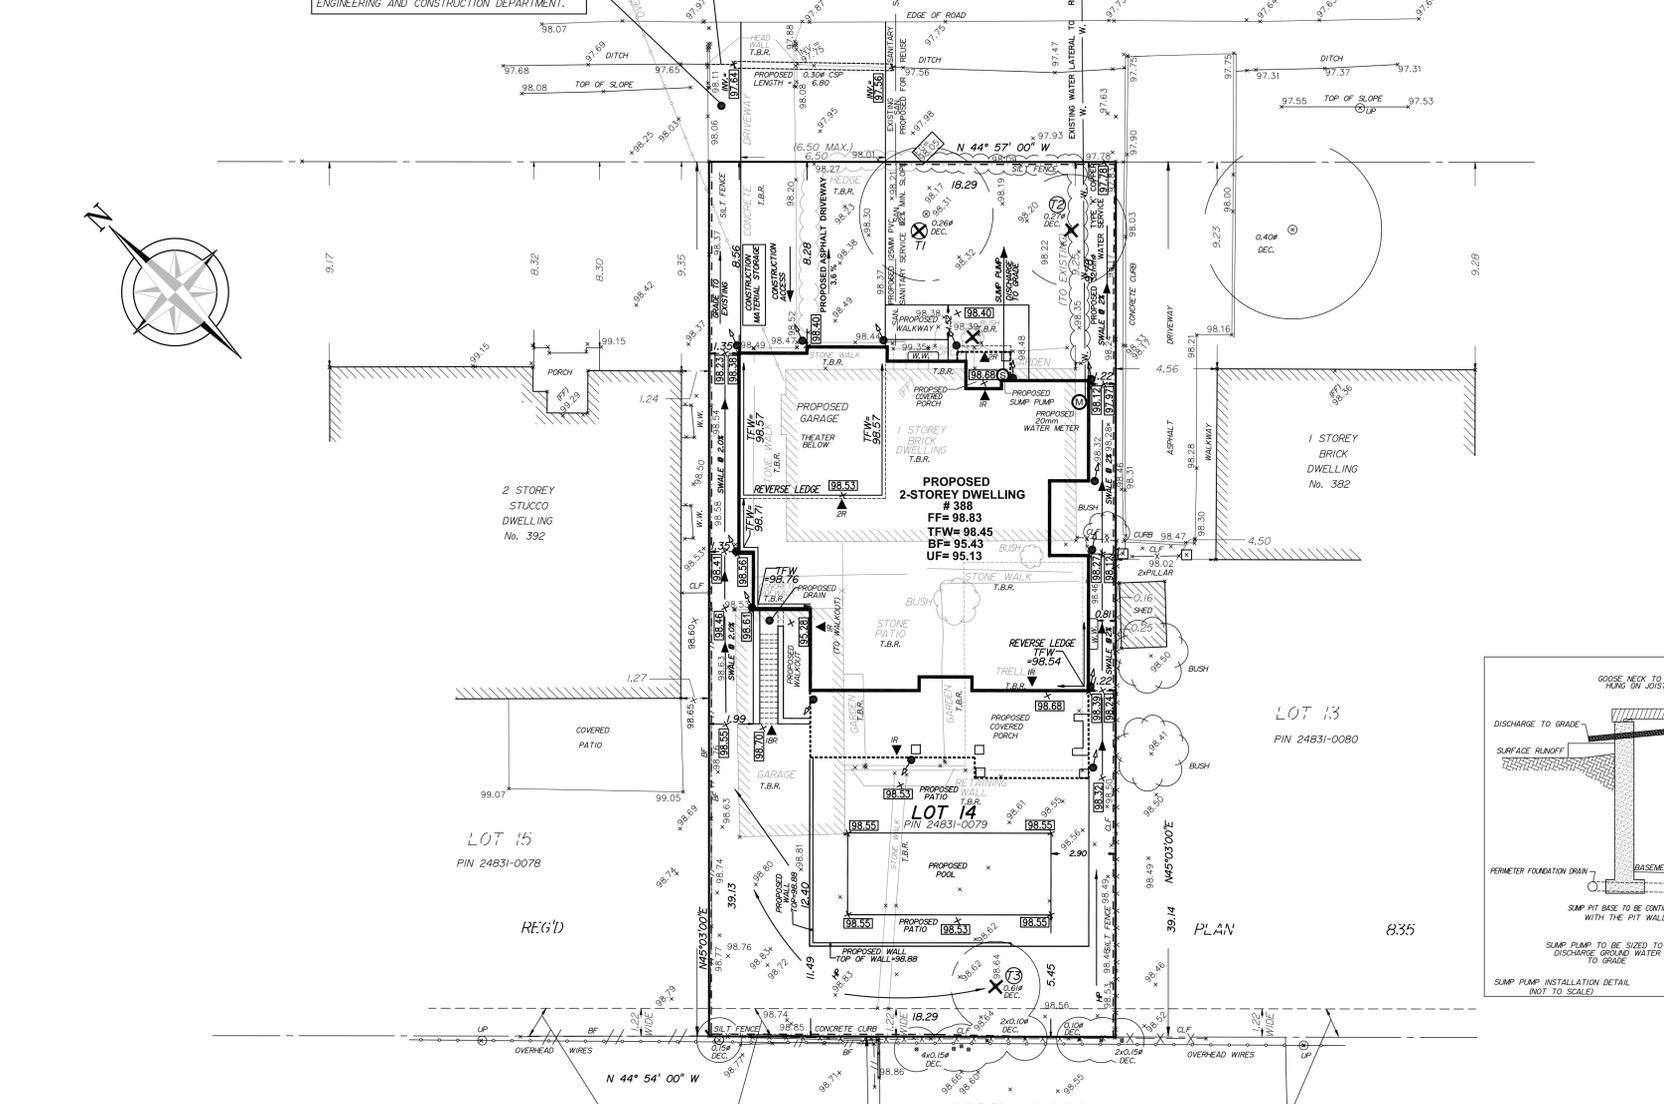

- (C) UTILITIES CONNECTION**
- SANITARY: (A) MUNICIPAL SANITARY SEWER AVAILABLE ON THE SITE.
 - WATER: (A) SERVICE CONNECTIONS TO BE 25mm DIA. TYPE 'K' SOFT COPPER TUBING UNLESS OTHERWISE NOTED AS PER REGION OF HALTON STANDARDS.
 - STORM: (A) A SUMP PUMP WILL BE REQUIRED TO DRAIN THE BASEMENT FACILITIES.

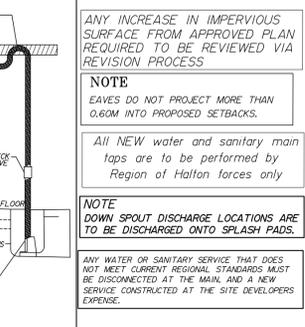

NOTE
Sever contractor to verify in the field and provide 2.5m (MIN.) separation between the Water and Sanitary Lines.
Contractor to use existing services.

NOTE
If the existing sanitary service lateral is used, it must be inspected at the property line by the Regional Inspector, and televised by Regional forces PRIOR to connection

NOTE
THIS LOT REQUIRES A SUMP PUMP FOR THE FOUNDATION DRAINS AND SHALL DISCHARGE TO THE GRADE. COMPLETE WITH BACKFLOW PREVENTER.

NOTE
Service sizes, inverts and types are derived from the Region of Halton Engineering Department Dwg. No. O-11651
The contractor must verify inverts.

J. H. Gelbloom Surveying Limited
Ontario Land Surveyor
476 Morden Road, Unit 102, Oakville, Ont, L6K 3W4
office@jhgssurveying.ca
Phone:(905) 338-6210



1/4" = 1'-0"
FRONT ELEVATION

CONSTRUCTION NOTES

CONTRACTOR TO SITE VERIFY IF DIMENSIONS FOR SPAN OF TRUSS MATCH WITH ON SITE CONDITIONS PRIOR TO ORDERING OF TRUSSES. DESIGNER MUST BE NOTIFIED IMMEDIATELY SHOULD THERE BE ANY DISCREPANCIES

POINT LOADS FROM GIRDER TRUSSES NOT SHOWN ON DRAWINGS. MANUFACTURER TO ACCOUNT FOR POINT LOADS FROM GIRDER TRUSSES IN LVL DESIGNS

ALL BEAMS SHALL HAVE A MINIMUM BEARING OF 4"

ALL STEEL COLUMNS TALLER THAN 12'-0" SHALL BE STRAPPED TO WOOD STUDS

ANY DISCREPANCIES DISCOVERED SHALL BE REPORTED TO THE DESIGNER IMMEDIATELY

QUALIFICATION

THE UNDERSIGNED HAS REVIEWED AND TAKES RESPONSIBILITY FOR THIS DESIGN, AS WELL AS HAVING THE QUALIFICATIONS AND REQUIREMENTS MANDATED BY THE ONTARIO BUILDING CODE (O.B.C.) TO BE A DESIGNER

QUALIFICATION INFORMATION

[Signature]
AAMOU RAFIQ 113576
 NAME B.C.I.N.

LUCID HOMES INC. 114457
 FIRM NAME B.C.I.N.



LUCID HOMES INC.
 CUSTOM HOME AND RENOVATION DESIGN
 1435 CORNWALL RD - UNIT D2
 OAKVILLE ON - L6J 7T5
 T. 416.566.6588 E. INFO@LUCIDHOMES.CA
 WWW.LUCIDHOMES.CA

GENERAL NOTES

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ISSUE LIST

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DRAWING TITLE: ARCHITECTURAL ELEVATIONS
 DRAWN BY: PR CHECKED BY:
 ADDRESS: 388 WEIGHTON DR, OAKVILLE
 PROJECT NO: 2024-65 SCALE: 1/4" = 1'-0"
 SHEET NO. **A201**

SPATIAL SEPARATION CALC. AS PER 9.10.15.4. OF OBC			
EXPOSING BUILDING FACE:	102.87 SQM		
UNPROTECTED OPENINGS:	6.94 SQM	6.74%	
PERMITTED:	7.20 SQM	7.00%	



1/4" = 1'-0"
LEFT ELEVATION

CONSTRUCTION NOTES

CONTRACTOR TO SITE VERIFY IF DIMENSIONS FOR SPAN OF TRUSS MATCH WITH ON SITE CONDITIONS PRIOR TO ORDERING OF TRUSSES. DESIGNER MUST BE NOTIFIED IMMEDIATELY SHOULD THERE BE ANY DISCREPANCIES

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QUALIFICATION

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QUALIFICATION INFORMATION

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NAME B.C.I.N.

LUCID HOMES INC. 114457
FIRM NAME B.C.I.N.



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T: 416-566-6588 E: INFO@LUCIDHOMES.CA
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5 -		MM.DD.YYYY



DRAWING TITLE: ARCHITECTURAL ELEVATIONS
DRAWN BY: PR CHECKED BY: -
ADDRESS: 388 WRIGHTON DR, OAKVILLE
PROJECT NO: 2024-65 SCALE: 1/4" = 1'-0"
SHEET NO. **A202**



1/4"=1'-0"
REAR ELEVATION

CONSTRUCTION NOTES

CONTRACTOR TO SITE VERIFY IF DIMENSIONS FOR SPAN OF TRUSS MATCH WITH ON SITE CONDITIONS PRIOR TO ORDERING OF TRUSSES. DESIGNER MUST BE NOTIFIED IMMEDIATELY SHOULD THERE BE ANY DISCREPANCIES

POINT LOADS FROM GIRDER TRUSSES NOT SHOWN ON DRAWINGS. MANUFACTURER TO ACCOUNT FOR POINT LOADS FROM GIRDER TRUSSES IN LVL DESIGNS

ALL BEAMS SHALL HAVE A MINIMUM BEARING OF 4"

ALL STEEL COLUMNS TALLER THAN 12'-0" SHALL BE STRAPPED TO WOOD STUDS

ANY DISCREPANCIES DISCOVERED SHALL BE REPORTED TO THE DESIGNER IMMEDIATELY

QUALIFICATION

THE UNDERSIGNED HAS REVIEWED AND TAKES RESPONSIBILITY FOR THIS DESIGN, AS WELL AS HAVING THE QUALIFICATIONS AND REQUIREMENTS MANDATED BY THE ONTARIO BUILDING CODE (O.B.C.) TO BE A DESIGNER

QUALIFICATION INFORMATION

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 NAME 113576 B.C.I.N.

LUCID HOMES INC. 114457 B.C.I.N.



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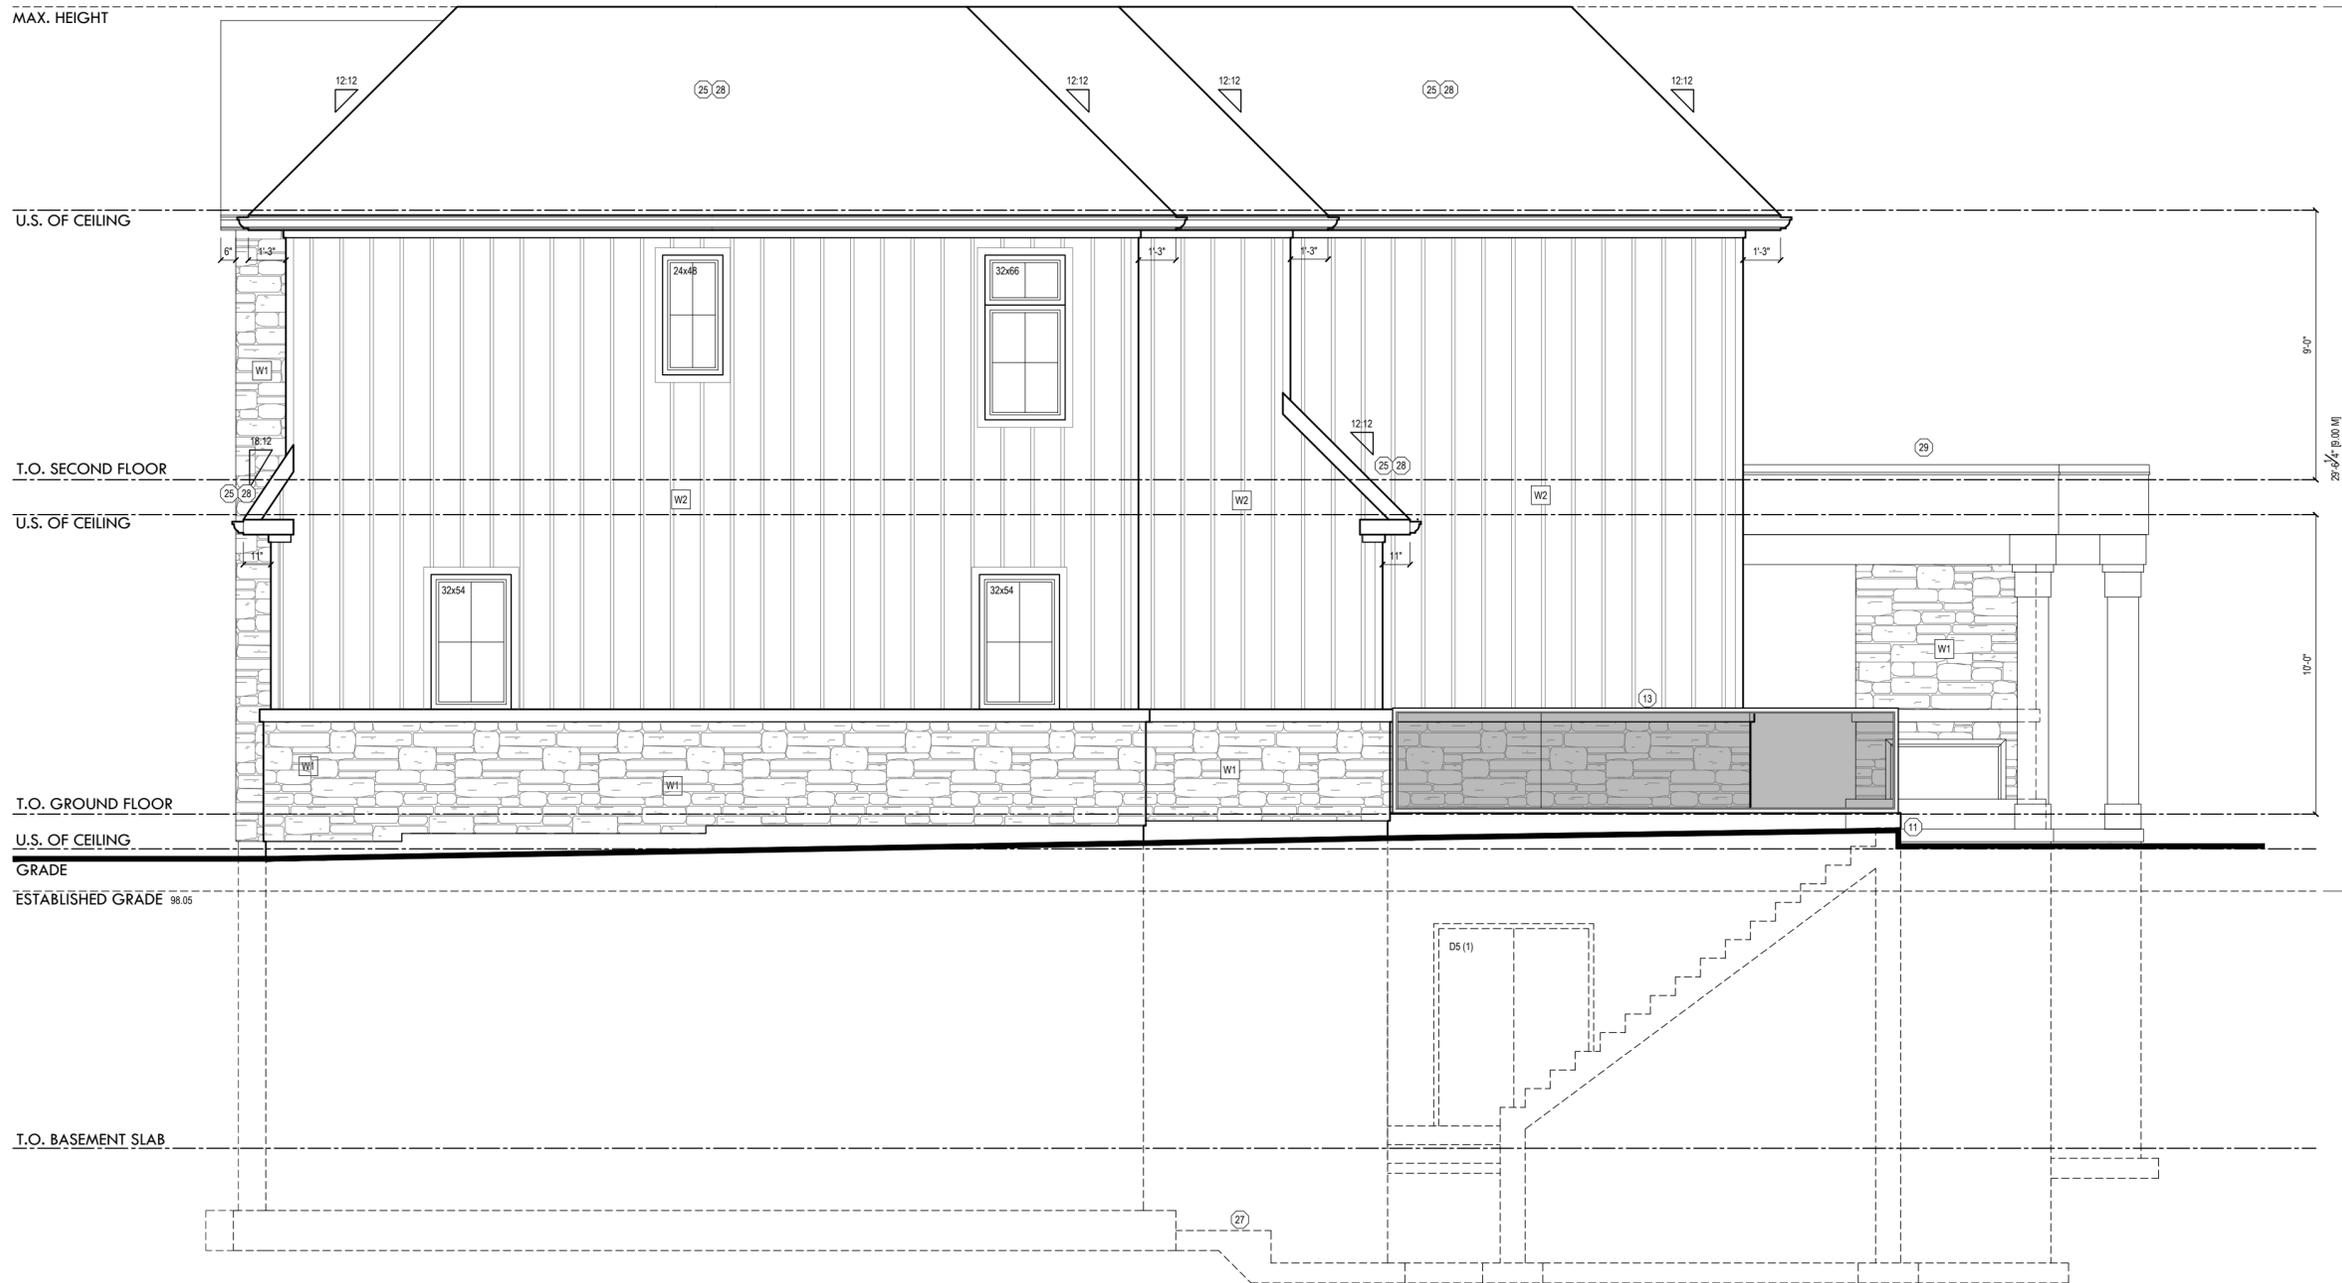
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4 -		MM.DD.YYYY
5 -		MM.DD.YYYY



DRAWING TITLE: ARCHITECTURAL ELEVATIONS
 DRAWN BY: PR CHECKED BY: -
 ADDRESS: 388 WRIGHTON DR, OAKVILLE
 PROJECT NO: 2024-65 SCALE: 1/4" = 1'-0"
 SHEET NO. **A203**

SPATIAL SEPARATION CALC. AS PER 9.10.15.4. OF OBC			
EXPOSING BUILDING FACE:	98.62 SQM		
UNPROTECTED OPENINGS:	4.34 SQM	4.40%	
PERMITTED:	6.90 SQM	7.00%	



1/4" = 1'-0"
RIGHT ELEVATION

CONSTRUCTION NOTES

CONTRACTOR TO SITE VERIFY IF DIMENSIONS FOR SPAN OF TRUSS MATCH WITH ON SITE CONDITIONS PRIOR TO ORDERING OF TRUSSES. DESIGNER MUST BE NOTIFIED IMMEDIATELY SHOULD THERE BE ANY DISCREPANCIES

POINT LOADS FROM GIRDER TRUSSES NOT SHOWN ON DRAWINGS. MANUFACTURER TO ACCOUNT FOR POINT LOADS FROM GIRDER TRUSSES IN LVL DESIGNS

ALL BEAMS SHALL HAVE A MINIMUM BEARING OF 4"

ALL STEEL COLUMNS TALLER THAN 12'-0" SHALL BE STRAPPED TO WOOD STUDS

ANY DISCREPANCIES DISCOVERED SHALL BE REPORTED TO THE DESIGNER IMMEDIATELY

QUALIFICATION

THE UNDERSIGNED HAS REVIEWED AND TAKES RESPONSIBILITY FOR THIS DESIGN, AS WELL AS HAVING THE QUALIFICATIONS AND REQUIREMENTS MANDATED BY THE ONTARIO BUILDING CODE (O.B.C.) TO BE A DESIGNER

QUALIFICATION INFORMATION

AAMOU RAFIQ
NAME 113576 B.C.I.N.

LUCID HOMES INC. 114457 B.C.I.N.



LUCID HOMES INC.
CUSTOM HOME AND RENOVATION DESIGN
1435 CORNWALL RD - UNIT D2
OAKVILLE ON - L6J 7T5
T: 416.566.6588 E: INFO@LUCIDHOMES.CA
WWW.LUCIDHOMES.CA

GENERAL NOTES

DRAWINGS ARE TO BE READ NOT SCALED. DESIGN AND CONSTRUCTION OF THIS BUILDING SHALL COMPLY WITH ONTARIO BUILDING CODE, AS AMENDED. DRAWINGS NOT INTENDED FOR PERMIT OR CONSTRUCTION UNLESS SIGNED BY DESIGNER OR ENGINEER. DO NOT BEGIN CONSTRUCTION UNTIL DESIGNER OR PROJECT MANAGER HAS BEEN NOTIFIED. CONTRACTOR TO SITE VERIFY DIMENSIONS AND ANY DISCREPANCIES DISCOVERED SHALL BE REPORTED TO THE DESIGNER IMMEDIATELY. THE DRAWINGS AND DOCUMENTS ARE THE EXCLUSIVE PROPERTY OF LUCID HOMES INC. REPRODUCTION OF THE DOCUMENTS PROVIDED IS PROHIBITED WITHOUT CONSENT OF THE DESIGNER.


REVISION LIST

NO.	DESCRIPTION	DATE
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2 -		MM.DD.YYYY
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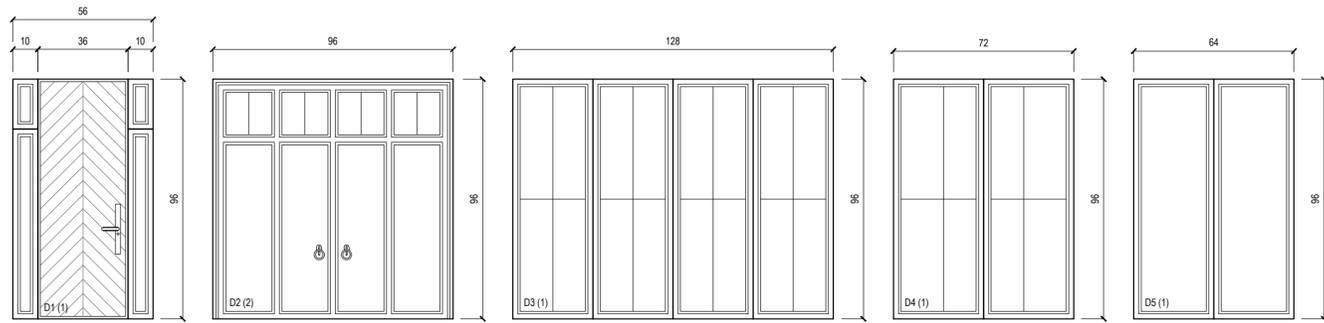
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2 -		MM.DD.YYYY
3 -		MM.DD.YYYY
4 -		MM.DD.YYYY
5 -		MM.DD.YYYY



DRAWING TITLE: ARCHITECTURAL ELEVATIONS
DRAWN BY: PR CHECKED BY: -
ADDRESS: 388 WRIGHTON DR, OAKVILLE
PROJECT NO: 2024-65 SCALE: 1/4" = 1'-0"
SHEET NO. **A204**

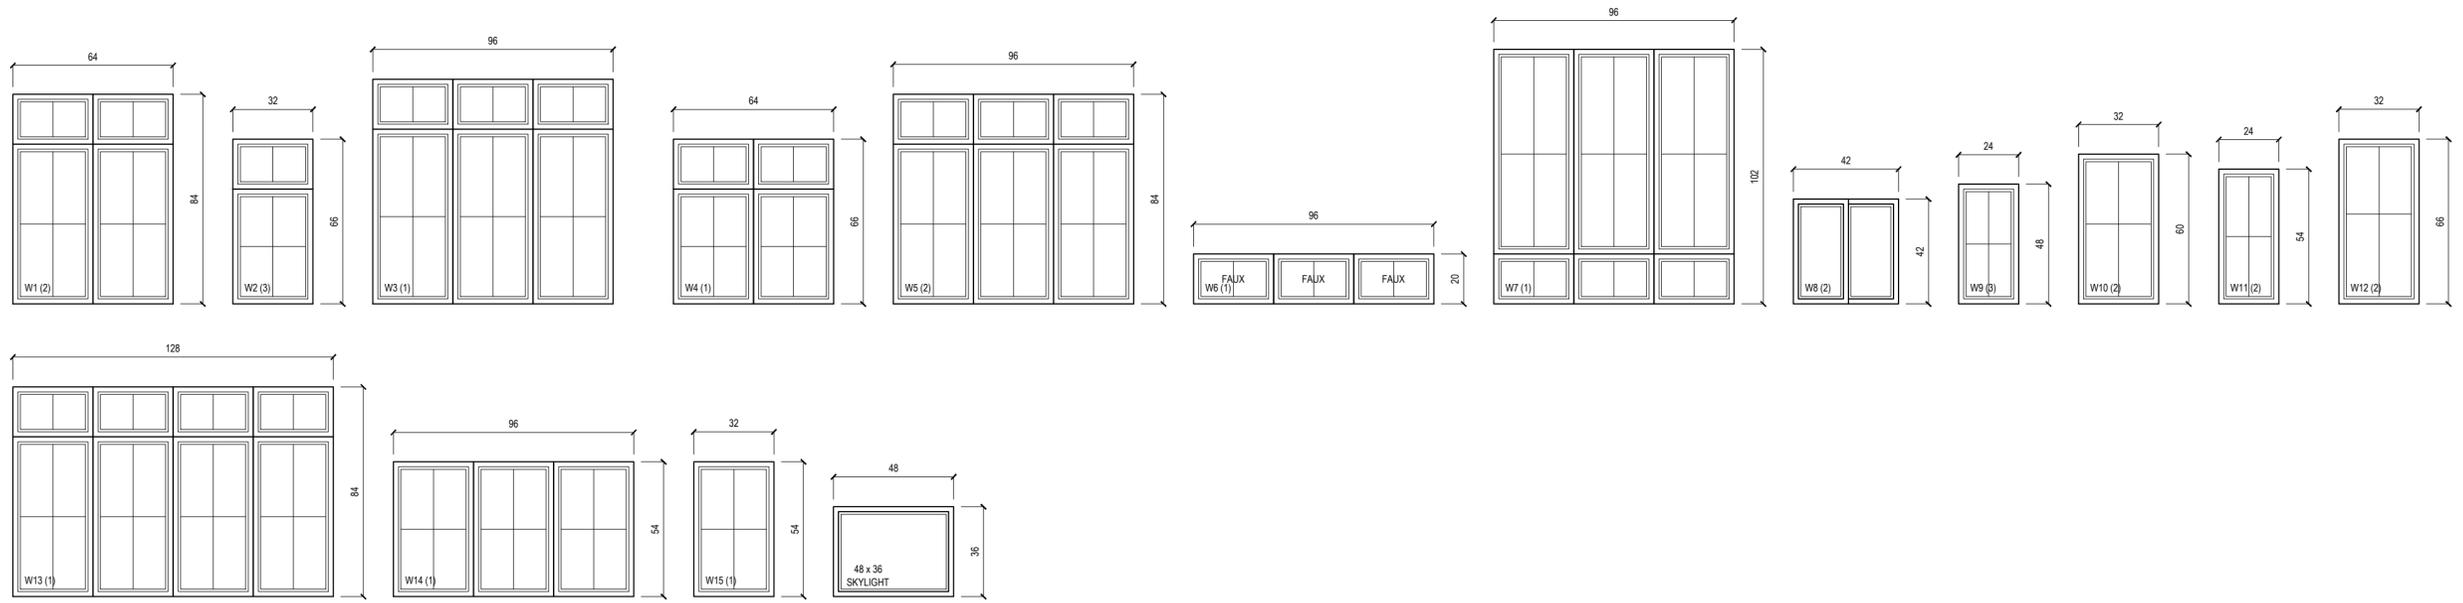

1/4"=1'-0"
WINDOW SCHEDULE



1/4"=1'-0"
DOOR SCHEDULE

CONSTRUCTION NOTES

CONTRACTOR TO SITE VERIFY IF DIMENSIONS FOR SPAN OF TRUSS MATCH WITH ON SITE CONDITIONS PRIOR TO ORDERING OF TRUSSES. DESIGNER MUST BE NOTIFIED IMMEDIATELY SHOULD THERE BE ANY DISCREPANCIES

POINT LOADS FROM GIRDER TRUSSES NOT SHOWN ON DRAWINGS. MANUFACTURER TO ACCOUNT FOR POINT LOADS FROM GIRDER TRUSSES IN LVL DESIGNS

ALL BEAMS SHALL HAVE A MINIMUM BEARING OF 4"

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QUALIFICATION INFORMATION

AAMOU RAFIQ
NAME 113576 B.C.I.N.

LUCID HOMES INC. 114457 B.C.I.N.



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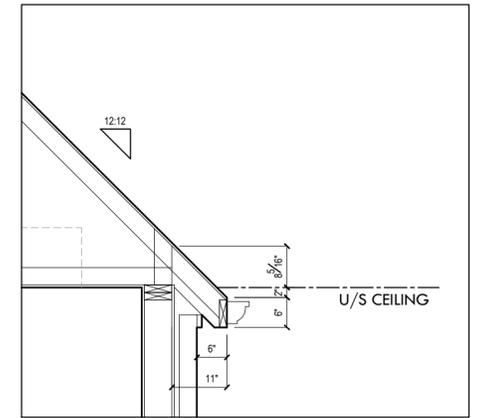
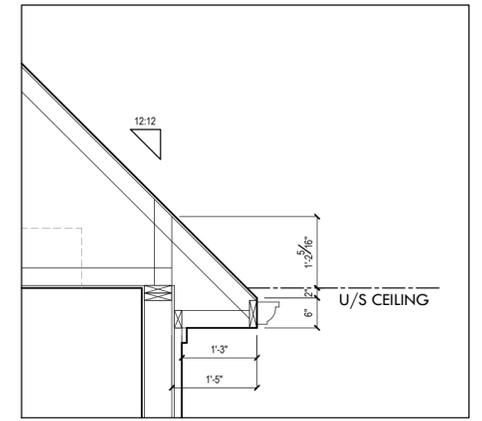
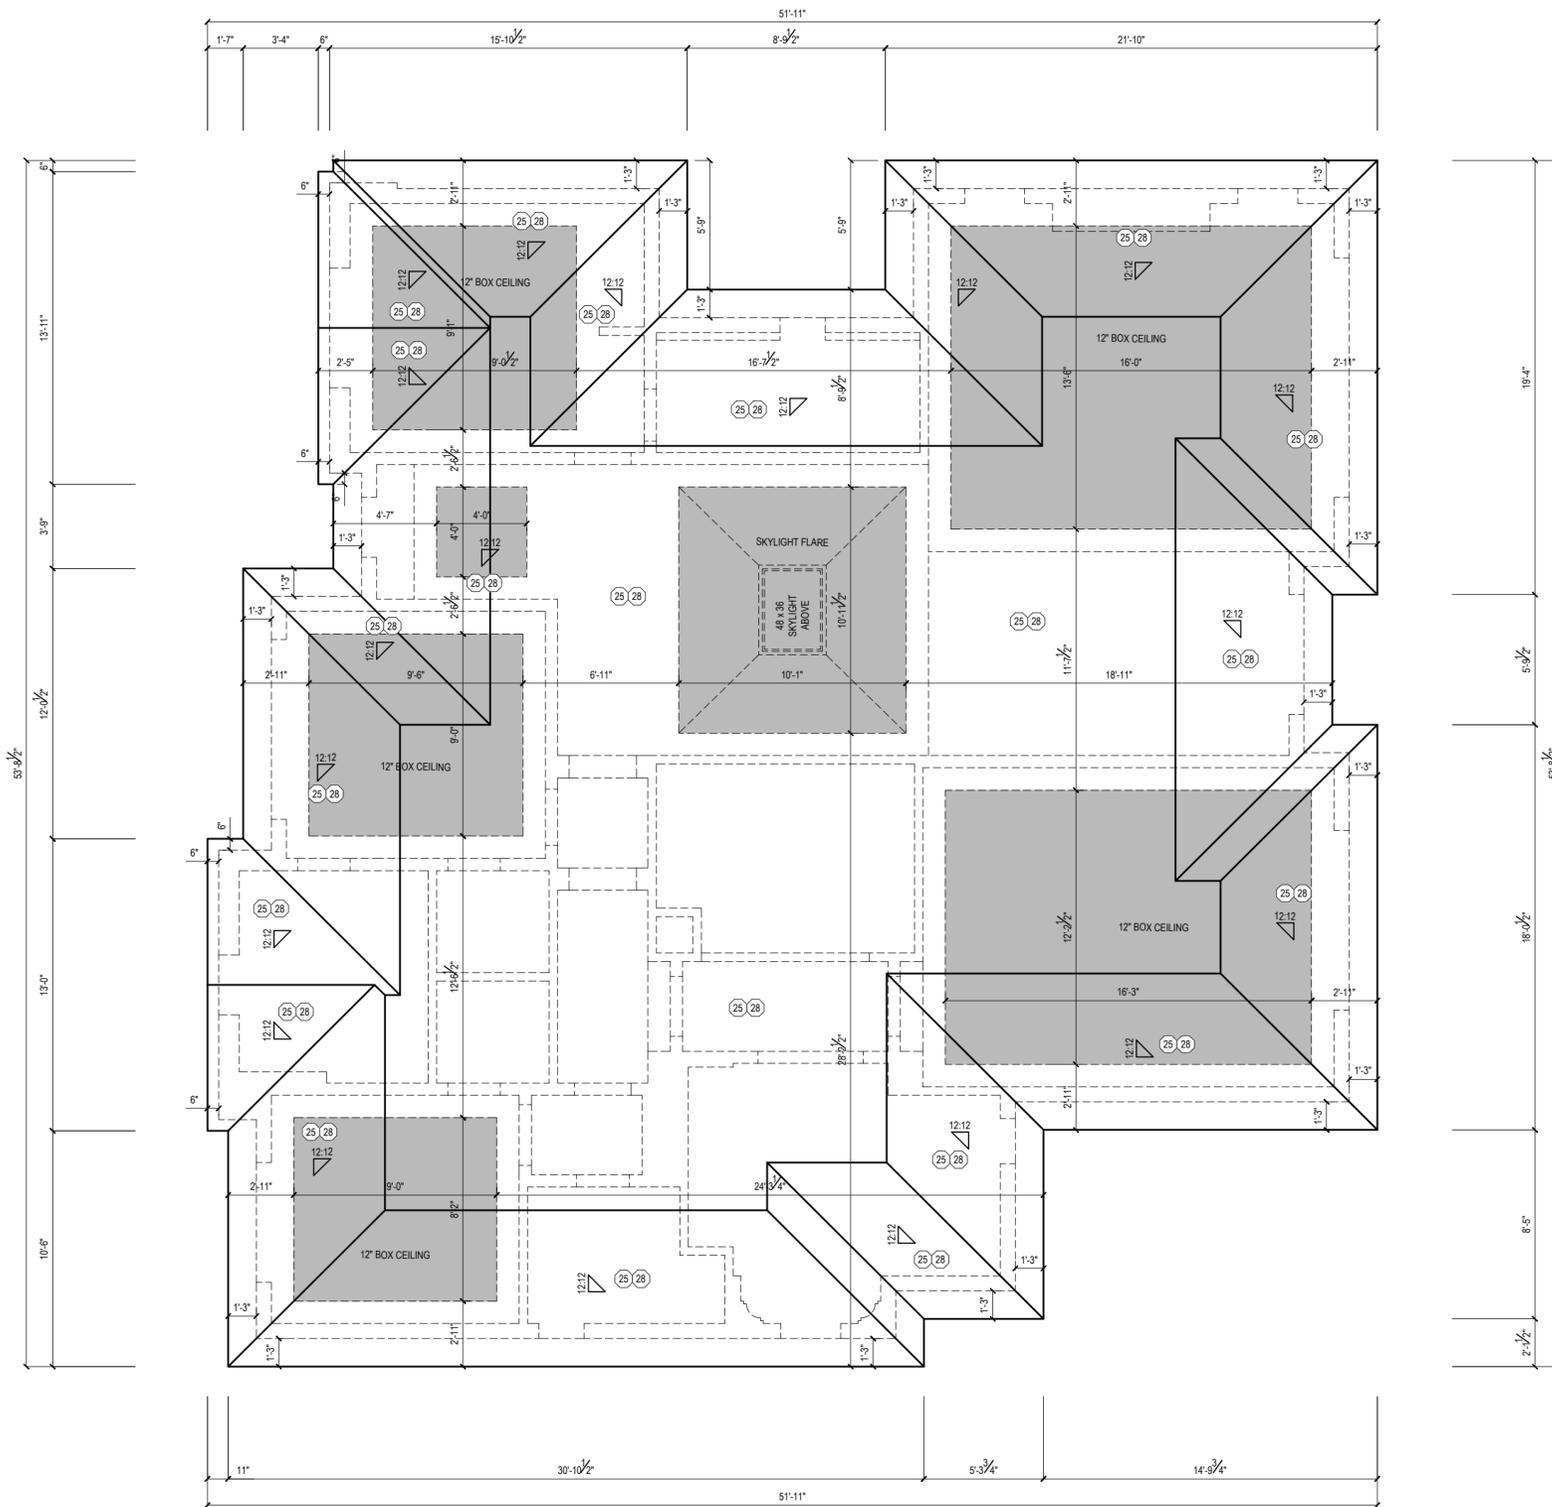
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ISSUE LIST

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2 -	MM.DD.YYYY	MM.DD.YYYY
3 -	MM.DD.YYYY	MM.DD.YYYY
4 -	MM.DD.YYYY	MM.DD.YYYY
5 -	MM.DD.YYYY	MM.DD.YYYY



DRAWING TITLE: WINDOW & DOOR SCHEDULES
DRAWN BY: PR **CHECKED BY:** -
ADDRESS: 388 WEIGHTON DR, OAKVILLE
PROJECT NO: 2024-65 **SCALE:** 1/4" = 1'-0"
SHEET NO. **A401**



ROOF PLAN

3/16"=1'-0"

CONSTRUCTION NOTES

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QUALIFICATION INFORMATION

AAMOU RAFIQ 113576
 NAME B.C.I.N.

LUCID HOMES INC. 114457
 FIRM NAME B.C.I.N.



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4 -	MM.DD.YYYY
5 -	MM.DD.YYYY



DRAWING TITLE: ROOF PLAN
 DRAWN BY: PR CHECKED BY: -
 ADDRESS: 388 WIGHTON DR, OAKVILLE
 PROJECT NO: 2024-65 SCALE: 3/16" = 1'-0"
 SHEET NO. **A103**

