

SITE STATISTICS - ZONE RL1-0 1. LOT AREA = 3524 m2 (1393.5m2 Minimum). 2. LOT FRONTAGE = 34.94m (30.00m Minimum). 3. AREAS FOR COVERAGE =630.45m2 (6786.37 sq.ft) (A) MAIN DWELLING (Includes Garage) =584.89m2 (B) COVERED PORCH = 30.17m2(C) GAZEBO = 15.39m24. LOT COVERAGE =17.89% (25.0% Maximum 881m2). 5. ESTABLISHED GRADE = 79.57m. - ROOF RIDGE = 10.07m (10.50m Maximum); - FRONT = 19.14m (min 10.5m); - REAR = 28.57m (Dwelling) (10.50m Minimum); - SIDES: 4.22m AND 4.23m (4.20m & 4.20m Min); 8. FLOOR AREA =727.97 m2.(7,835.90 sq.ft) 9. FA/LOT RATIO = 20.65% (29% Maximum 1021.96m2).

11. BUILDING WIDTH = 37.27m

SITE STATISTICS - ZONE RL1-0 1. LOT AREA = 3524 m2 (1393.5m2 Minimum). 2. LOT FRONTAGE = 34.94m (30.00m Minimum). 3. AREAS FOR COVERAGE = 734.03m2 (7901.03 sq.ft) (A) MAIN DWELLING (Includes Garage) = 709.77 (B) COVERED PORCH = 8.87m2(C) GAZEBO = 15.39m2

4. LOT COVERAGE =20.82% (25.0% Maximum 881m2).

- ROOF RIDGE = 10.07m (10.50m Maximum); – FRONT = 19.14m (min 10.5m); – REAR = 28.57m (Dwelling) (10.50m Minimum); - SIDES: 4.22m AND 5.00m (4.20m & 4.20m Min); 8. FLOOR AREA =942.07 m2.(10,140.42 sq.ft) 9. FA/LOT RATIO = 26.73% (29% Maximum 1021.96m2). 10. BUILDING DEPTH = 25.40m 11. BUILDING WIDTH = 36.44m

VARIANCES REQUESTED

1. BUILDING DEPTH-NEW WORKS PERMITTED=20m PROPOSED=25.40m VARIANCE = 5.40m

2. ROOF HEIGHT -NEW WORKS PERMITTED=9.0m PROPOSED=9.42m VARIANCE = 0.42m

3. DRIVEWAY WIDTH PERMITTED=9.0m PROPOSED=13.20m VARIANCE = 4.20m



BLOOR STREET, MISSISSAUGA, ONTARIO (416) 655-0245 email: jrcpdesigns@yahoo.ca

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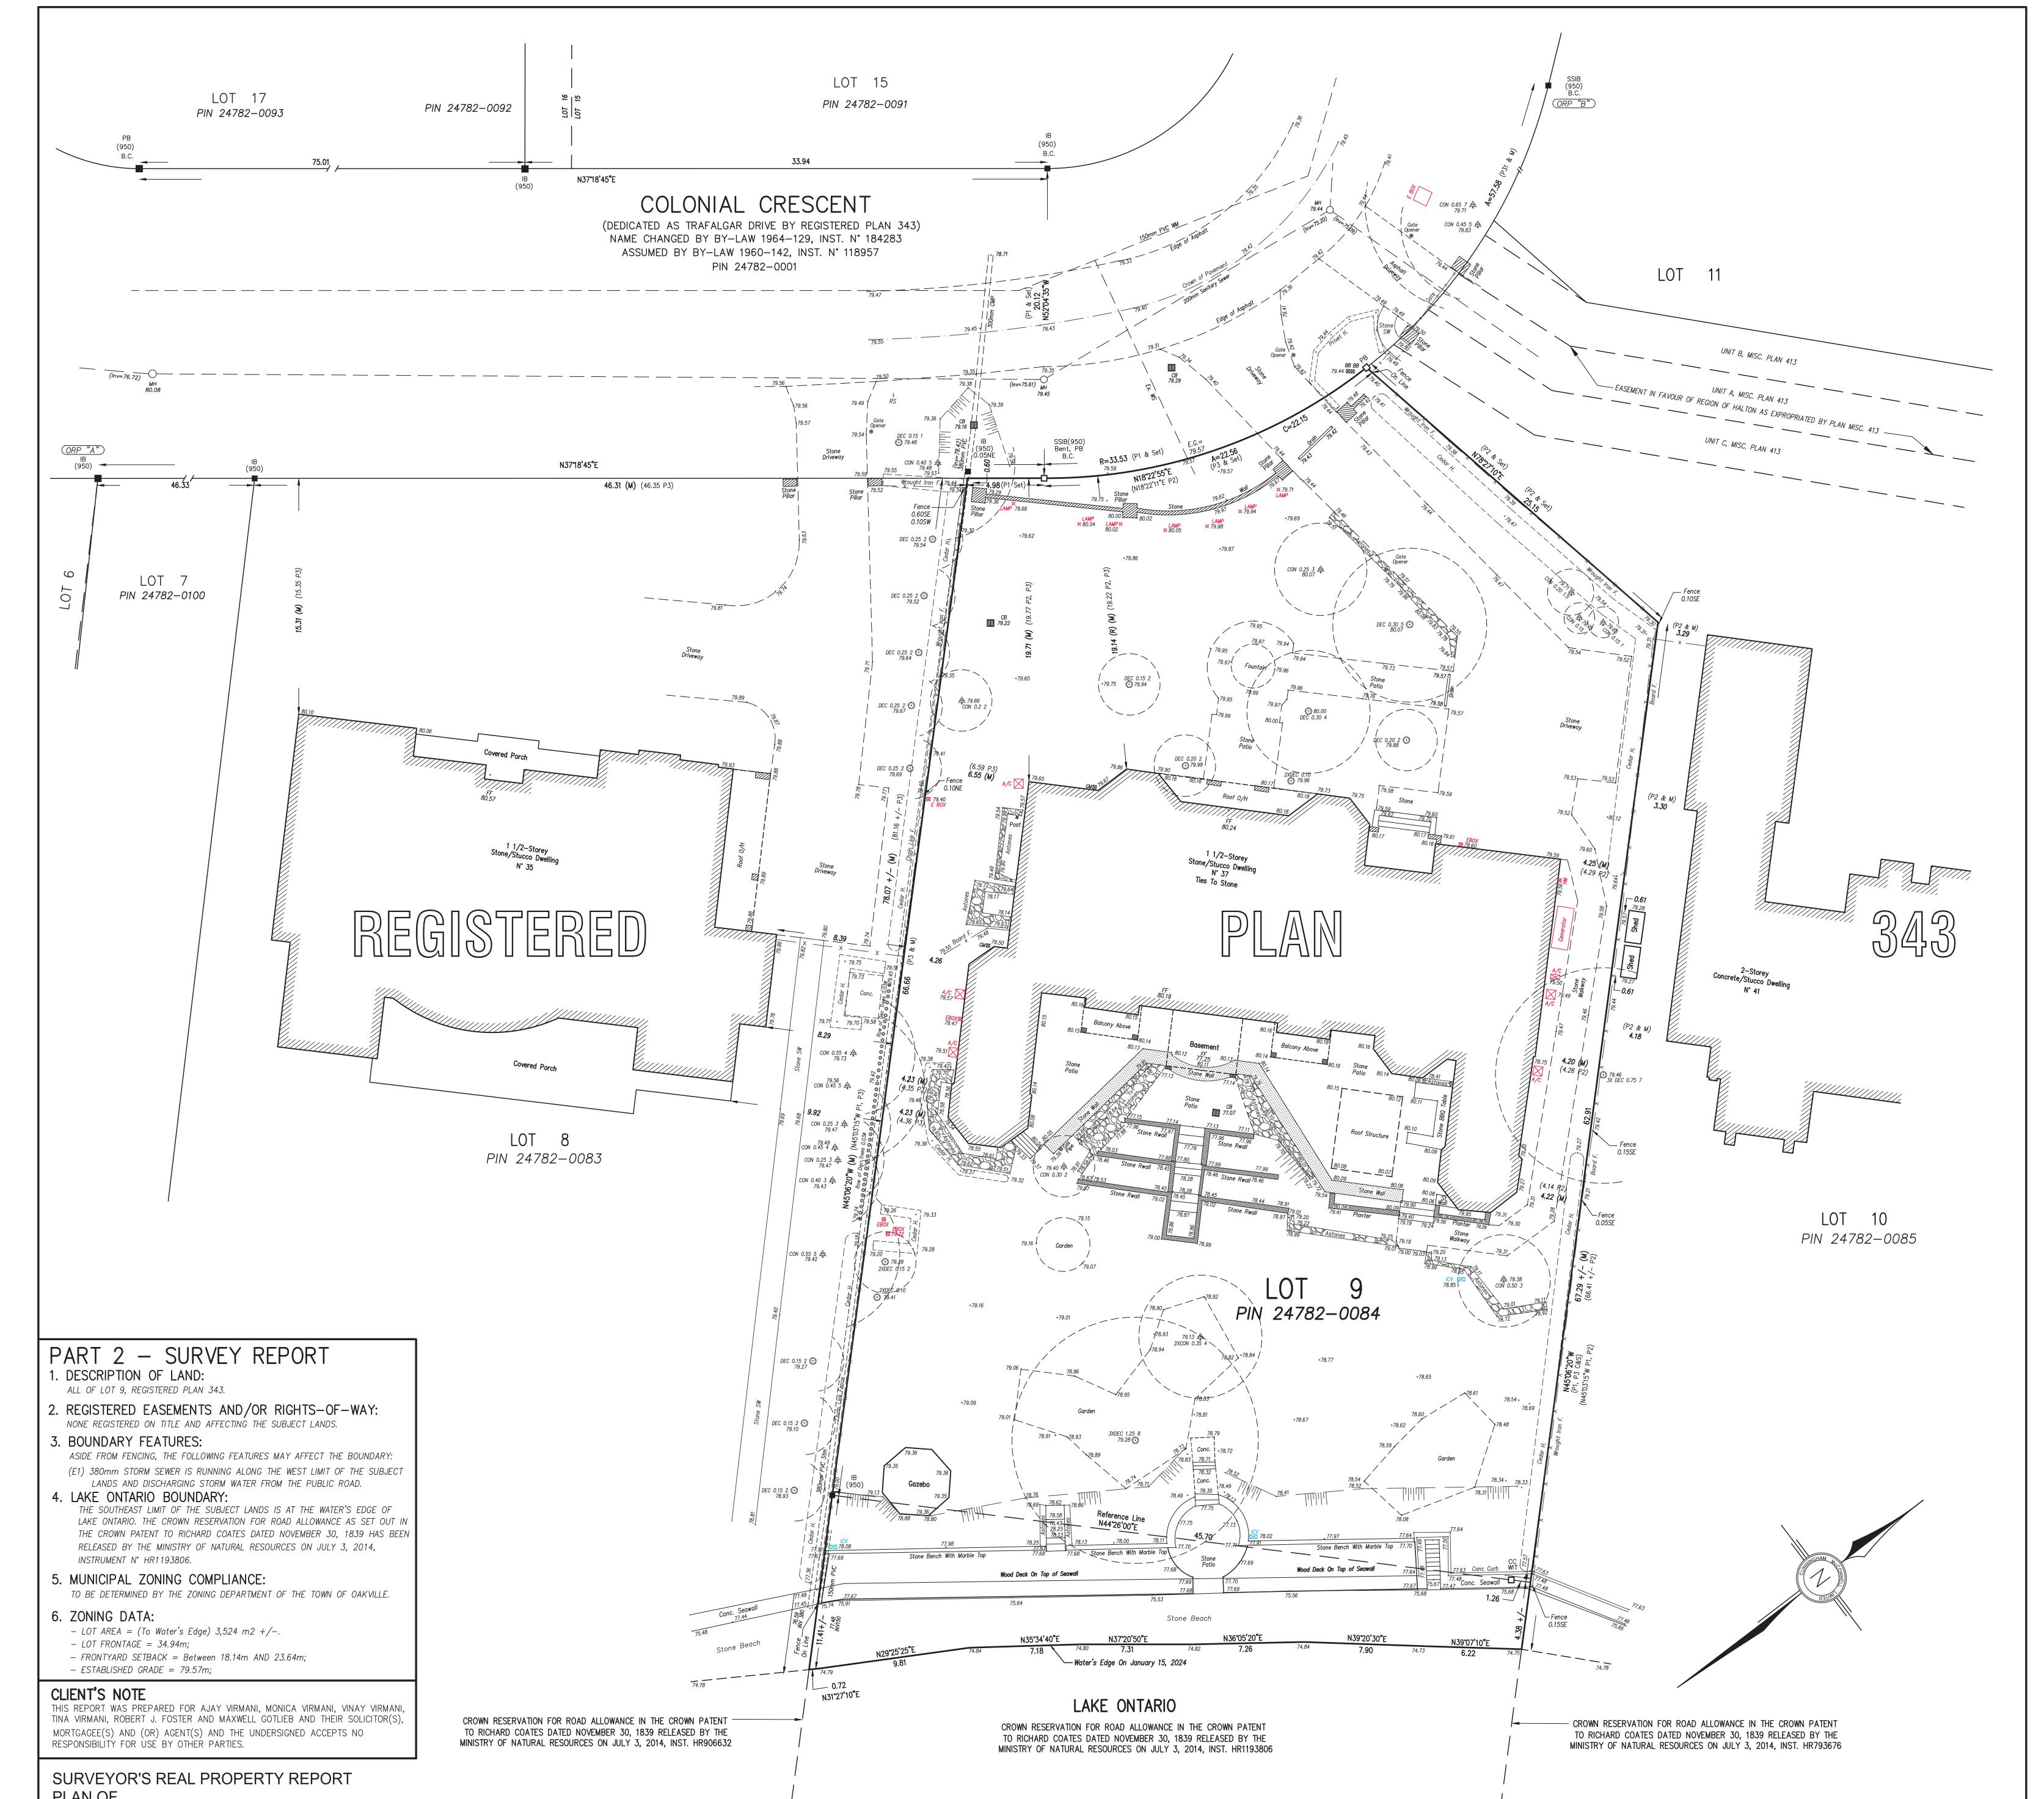
DRAWING STAGE FOR COA

PROJECT NAME AND ADDRESS:


PROPOSED **RESIDENCE AT** 37 COLONIAL CRES

OAKVILLE,

DRAWINGS TITLE	SHEET NO.
SITE PLAN	
DATE APRIL 0I 2025	A100
SCALE	
NOTED	



LOT 9 REGISTERED PLAN 343 TOWN OF OAKVILLE	ASSOCIATION OF ONTARIO LAND SURVEYORS PLAN SUBMISSION FORM V-63273	DISTANCES SHOWN HEREON ARE GROUND DISTANCES AND CAN BE CONVERTED INTO GRID DISTANCES BY MULTIPLYING BY A SCALE FACTOR OF 0.999746509. MULTIPLYING BY A SCALE FACTOR OF 0.999746509. BY BENOTES STANDARD IRON BAR DENOTES SHORT STANDARD IRON PIPE DENOTES SHORT STANDARD IRON PIPE	TOPOGRAPHIC LEGEND AW DENOTES ANCHOR WIRE(S) BB DENOTES BELL BOX -B- DENOTES U/G BELL CABLE CON-0.20 DENOTES CONIFEROUS TREE 0.20 DIA DEC-0.20 DENOTES DECIDUOUS TREE 0.20 DIA FH DENOTES FIRE HYDRANT GM DENOTES GAS METER SURVEYOR'S CERTIFICATE	CUNNINGHAM McCONNELL LIMITED ONTARIO LAND SURVEYORS 1200 SPEERS ROAD, UNIT 38 OAKVILLE, ONTARIO L6L 2X4 DUONTS (205) 2015 7407 DHONE (205) 878-7810
REGIONAL MUNICIPALITY OF HALTON SCALE 1 : 150 3 0 3 6 9 GRAPHIC SCALE - METRES	CO-ORDINATES TO URBAN ACCORACY PER SEC. 14(2) OF O.REG. 216/10.POINT N° NORTHING EASTING POINT N° 4,812,706.04 609,202.96 (B" 4,812,833.38 609,251.95THIS PLAN IS NOT VALID UNLESS IT IS AN EMBOSSED ORIGINAL COPY ISSUED BY THE SURVEYOR In accordance with Regulation 1026. Section 29(3).CO-ORDINATES CAN NOT, IN THEMSELVES, BE USED TO RE-ESTABLISH CORNERS OR BOUNDARIES SHOWN ON THIS PLAN.BEARING ROTATION: PLANS P1, P2, P3 = (-) 0°59'15"	ALL DISTANCES SHOWN HEREON ARE IN METRES AND CAN BE CONVERTED INTO FEET BY DIVIDING BY 0.3048. ELEVATION NOTE ALL ELEVATIONS SHOWN HEREON ARE GEODETIC AND WERE DERIVED FROM THE TOWN OF OAKVILLE BENCHMARK N° 0–251 HAVING AN ELEVATION OF 118.729m (CGVD–1928:1978). BENCHMARK N° 0–251 HAVING AN ELEVATION OF	GV DENOTES GAS VALVE -G- DENOTES U/G GAS MAIN -H- DENOTES U/G HYDRO CABLE LS DENOTES LIGHT STANDARD (LAMP) MH DENOTES LIGHT STANDARD (LAMP) MH DENOTES OVER HEAD WIRE(S) -SAN- DENOTES SANITARY SEWER -STM- DENOTES STORM SEWER UP DENOTES UTILITY POLE UPLS DENOTES UTILITY POLE/LIGHT STANDARD WV DENOTES WATER VALVE (KEY) -W- DENOTES U/G WATER MAIN B CERTIFY THAT: 1. THIS SURVEY AND PLAN ARE CORRECT AND IN ACCORDANCE WITH THE SURVEYS ACT, THE SURVEYORS ACT AND THE REGULATIONS MADE UNDER THEM. 2. THE SURVEY WAS COMPLETED ON FEBRUARY 20, 2024. DATE: FEBRUARY 20, 2024 JARD A. LEGAT, M.Sc. ONTARIO LAND SURVEYOR	PHONE (905) 845–3497 infooak@cmlsurveyors.ca CLIENT: A. VIRMANI PLAN 141–23–1 © COPYRIGHT NO PERSON MAY COPY, REPRODUCE, DISTRIBUTE OR ALTER THIS PLAN IN WHOLE OR IN PART WITHOUT THE WRITTEN PERMISSION OF CUNNINGHAM McCONNELL LIMITED.

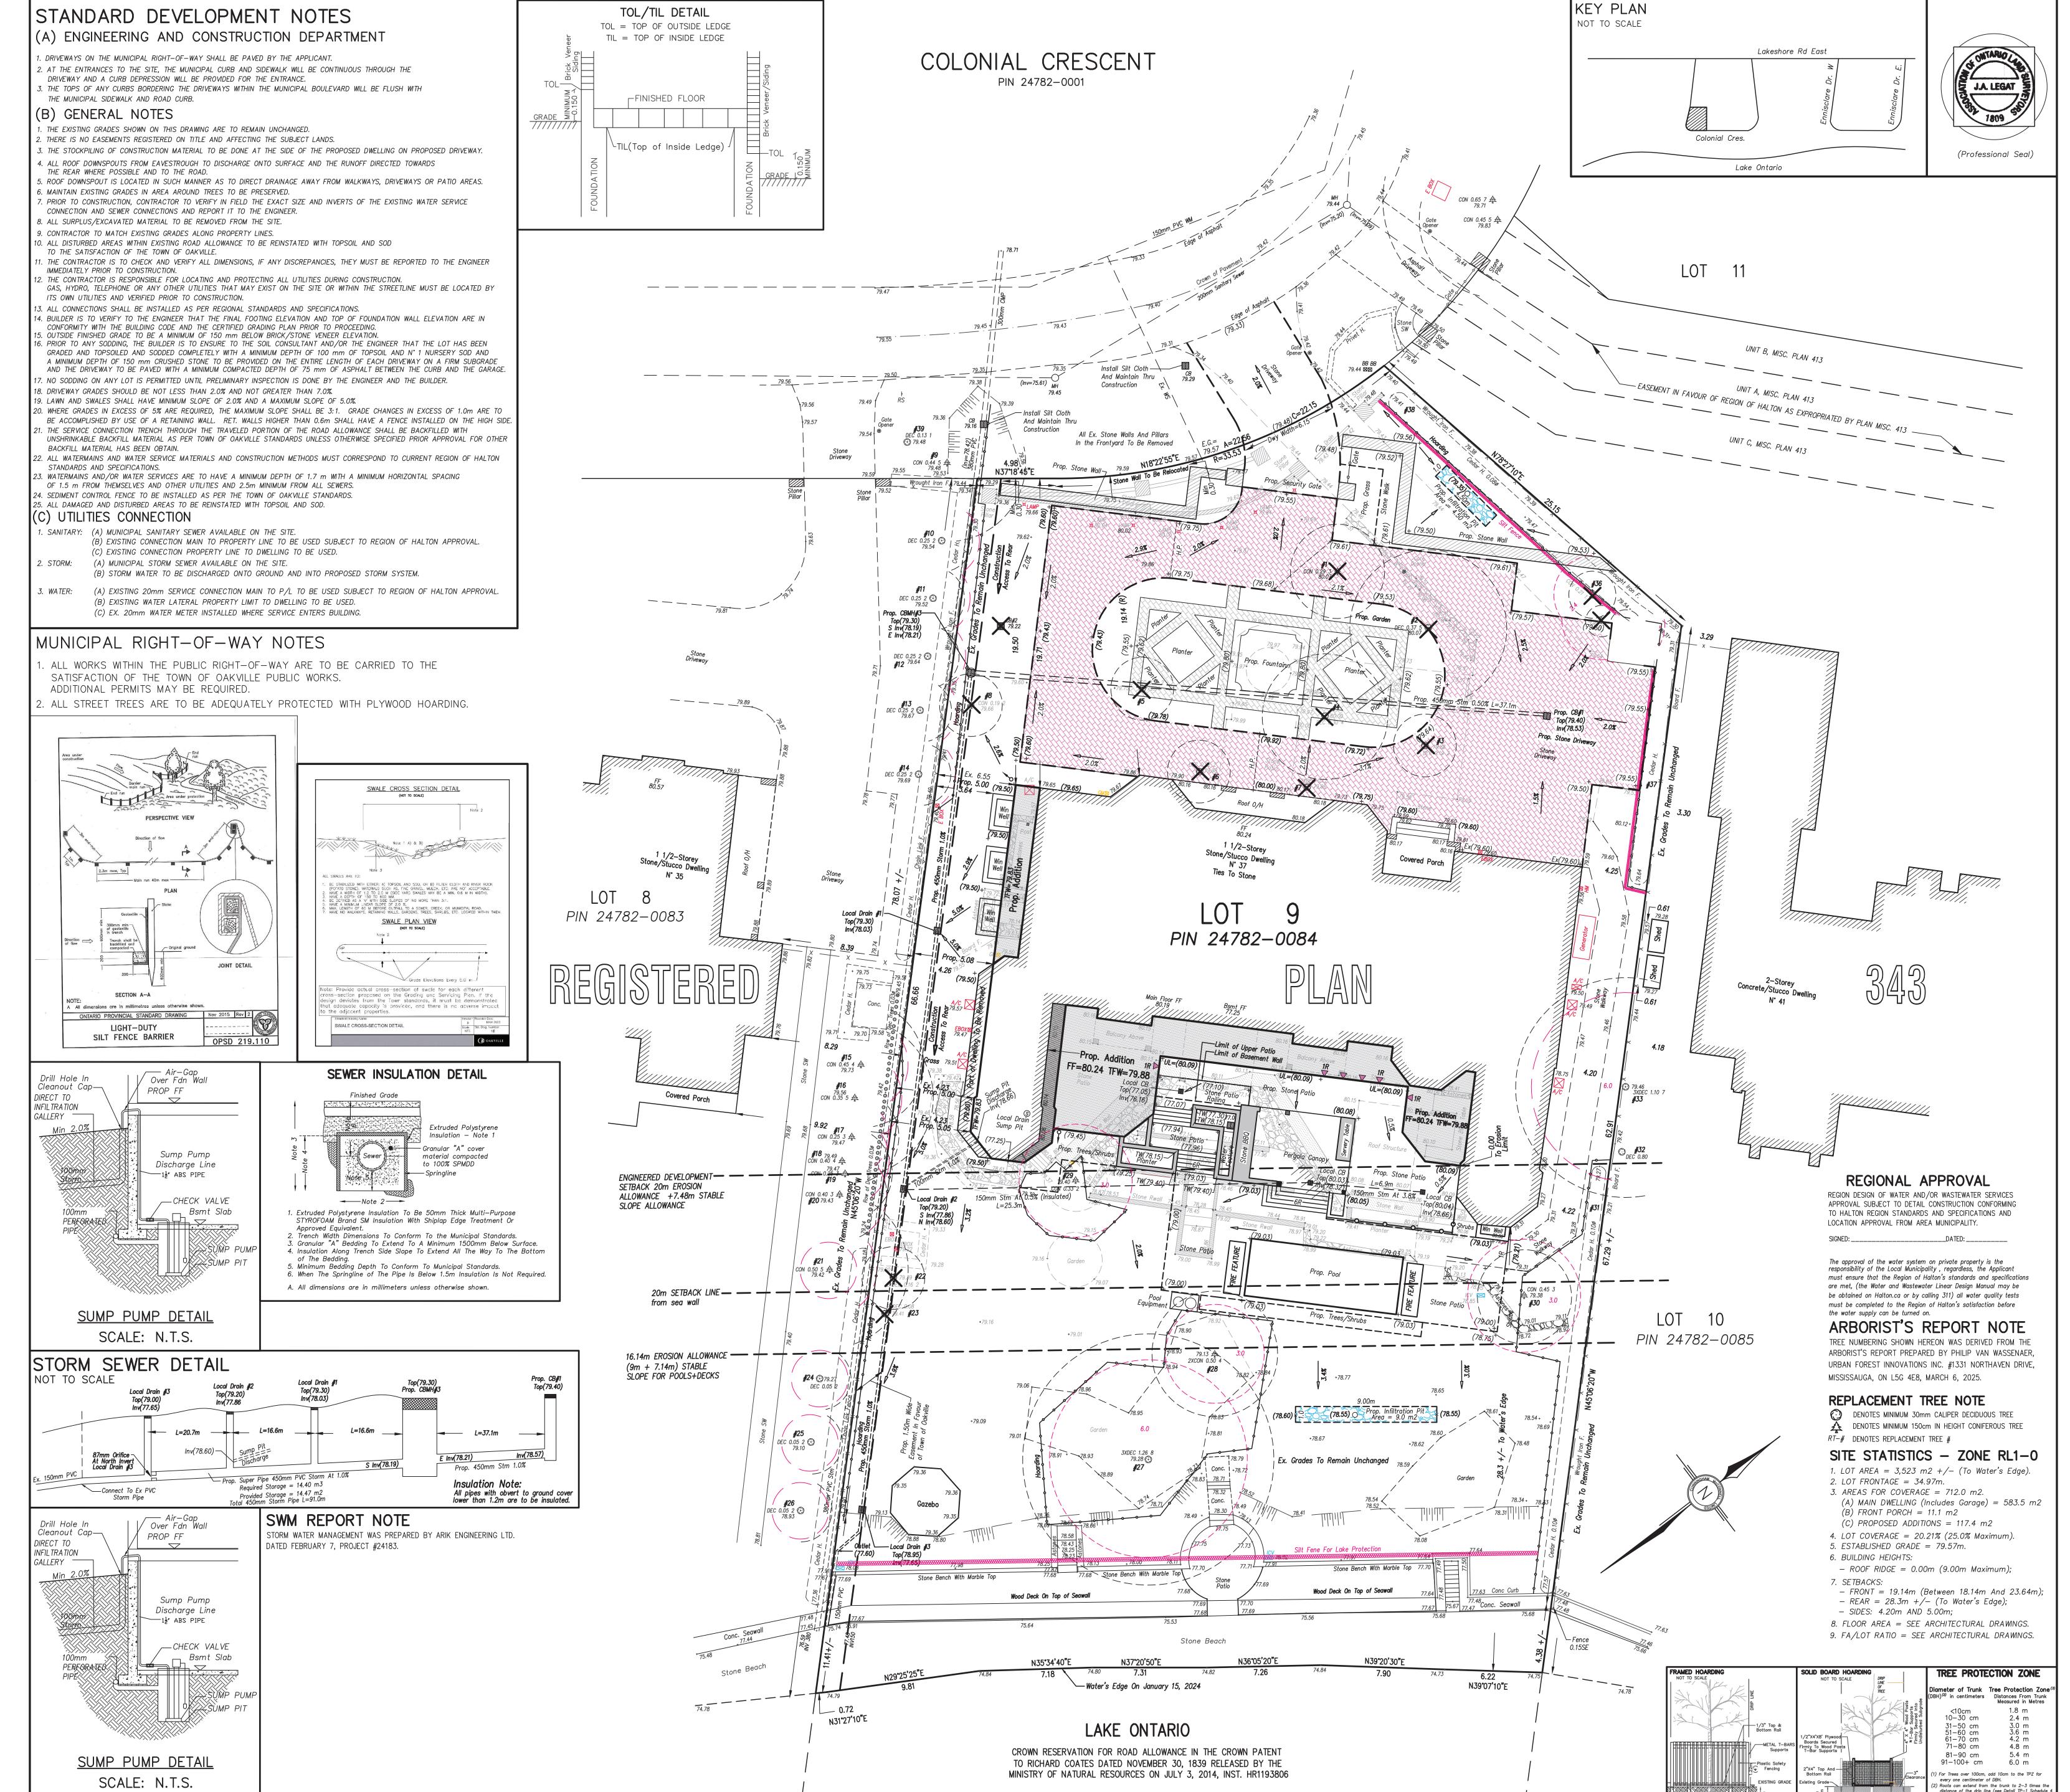

SITE GRADING PLAN OF						NOTE: 1. HOARDING DETAILS TO BE DETERMINED FOLLOWING INITIAL SITE 2. HOARDING TO BE APPROVED BY DEVELOPMENT AND DESIGN. 3. HOARDING MUST BE SUPPLIED, INSTALLED AND MAINTAINED BY CONSTRUCTION, UNTIL APPROVAL TO REMOVE IS OBTAINED FRO 4. DO NOT ALLOW WATER TO COLLECT AND POND BEHIND OR WIT * T-BAR SUPPORTS FOR SOLID HOARDING WILL ONLY BE ALLOWED WIT	Image: Solution of the solution
REGISTERED PLAN 343 TOWN OF OAKVILLE REGIONAL MUNICIPALITY OF HALTON SCALE 1:150	BOUNDARY NOTE ALL BOUNDARY SHOWN HEREON WAS DERIVED FROM PLAN BY CUNNINGHAM MCCONNELL LIMITED DATED FEBRUARY 20, 2024. GRADING CERTIFICATION NOTE AS PER OBC 9.14.6.1(1) I CERTIFY THAT THE BUILDING WILL BE LOCATED AND THAT SITE GRADING HAS BEEN DESIGNED SO THAT IT WILL NOT ADVERSELY AFFECT ADJACENT PROPERTIES.	DISTANCE NOTE DISTANCES SHOWN HEREON ARE GROUND DISTANCES AND CAN BE CONVERTED INTO GRID DISTANCES BY MULTIPLYING BY A SCALE FACTOR OF 0.999746509. METRIC NOTE ALL DISTANCES SHOWN HEREON ARE IN METRES AND CAN BE CONVERTED INTO FEET BY DIVIDING BY 0.3048 ELEVATION NOTE	TOPOGRAPHIC LEGEND AW DENOTES ANCHOR WIRE(S) BB DENOTES BELL BOX -B- DENOTES CONIFEROUS TREE 0.20 DIA DEC-0.20 DENOTES CONIFEROUS TREE 0.20 DIA DEC-0.20 DENOTES DECIDUOUS TREE 0.20 DIA FH DENOTES FIRE HYDRANT GM DENOTES GAS WALVE -G- DENOTES U/G GAS MAIN -H- DENOTES U/G HYDRO CABLE LS DENOTES MANHOLE -OW- DENOTES OVER HEAD WIRE(S) -SAN- DENOTES SANITARY SEWER	UNDERGROUND SERVICES NOTE ONLY UNDERGROUND SERVICES VISIBLE ON THE GROUND WERE LOCATED FOR THIS PLAN. THE USER OF THIS PLAN SHALL CONTACT THE LOCAL UTILITY COMPANIES FOR LOCATIONS PRIOR TO COMMENCEMENT OF CONSTRUCTION WORKS. SURVEYOR'S CERTIFICATE 1. THIS PLAN WAS PREPARED FOR THE DESIGN PURPOSES AND IS NOT SUITABLE FOR ANY LEGAL TRANSACTIONS AND (OR) MORTGAGE PURPOSES. 2. THE SURVEY WAS COMPLETED ON FEBRUARY 20, 2024.	CUNNINGHAM McCONNELL LIMITED ONTARIO LAND SURVEYORS 1200 SPEERS ROAD, UNIT 38 OAKVILLE, ONTARIO L6L 2X4 PHONE (905) 845–3497 infooak@cmlsurveyors.ca CLIENT: A. VIRMANI PLAN 141–23–2	2025/03/08 PER TOWN'S COMMENTS JAL 2025/02/06 FRONT AND REAR NEW LANDSCAPING ADDED JAL	#37 COLONIAL CRESCENT OAKVILLE SITE PLAN SITE GRADING AND SERVICING PLAN
3 0 3 6 9 	JARO A. L EGA T, M.Sc. ONTARIO LAND SURVEYOR	AND WERE DERIVED FROM THE TOWN OF OAKVILLE BENCHMARK N° 0–251 HAVING AN ELEVATION OF 118.729m (CGVD–1928:1978).	-STM- DENOTES STORM SEWER UP DENOTES UTILITY POLE UPLS DENOTES UTILITY POLE/LIGHT STANDARE WV DENOTES WATER VALVE (KEY) -W- DENOTES U/G WATER MAIN	D DATE: FEBRUARY 20, 2024	© COPYRIGHT NO PERSON MAY COPY, REPRODUCE, DISTRIBUTE OR ALTER THIS PLAN IN WHOLE OR IN PART WITHOUT THE WRITTEN PERMISSION OF CUNNINGHAM McCONNELL LIMITED.	2024/12/12ISSUED FOR GRADING APPROVALJAL2024/02/20ISSUED FOR DESIGNJAL	DATE: FEBRUARY 20, 2024 SCALE 1 : 150 AL DEPA PLAN 141-23-2







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DRAWING STAGE:

PROJECT NAME AND ADDRESS:

DRAWINGS TITLE

FRONT ELEVATION

APRIL 0I 2025

NOTED

DATE

SCALE


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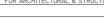
PROPOSED RESIDENCE AT 37 COLONIAL CRES

OAKVILLE,

SHEET NO.

A200



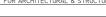





SOUTH ELEVATION - REAR A201

3/32"=1'-0" (1:128)



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PROJECT NAME AND ADDRESS:

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SOUTH ELEVATION


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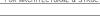
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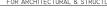










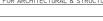



















PROPOSED RESIDENCE AT 37 COLONIAL CRES

OAKVILLE,

SHEET NO.

A201



















RÖDEL F.F.E-80.24m TOP OF FIRST FLOOR NEW WALL WEW WALL F.F.E-80.24m TOP OF FIRST FLOOR	65-7ĝ (20.0m) PERMITED BUILDING DEPTH		B9-64m TOP OF EECOND FLOOR U/S CEILING U/S CEILING
	NEW WALL	NEW WALL	F.F.E.=80.24m

WEST ELEVATION ____ A202/

3/32"=1'-0" (1:128)



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ISSUE DATE AND REVISION LOG NO. REVISION DATE

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FOR ARCHITECTURAL & STRUCTURAL

DRAWING STAGE: FOR COA

PROJECT NAME AND ADDRESS:

PROPOSED RESIDENCE AT 37 COLONIAL CRES

OAKVILLE,

DRAWINGS TITLE WEST ELEVATION SHEET NO.

A202

DATE APRIL 0I 2025 SCALE NOTED





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ISSUE DATE AND REVISION LOG

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FOR ARCHITECTURAL & STRUCTURAL

DRAWING STAGE:

FOR COA

PROJECT NAME AND ADDRESS:

PROPOSED RESIDENCE AT 37 COLONIAL CRES

OAKVILLE,

DRAWINGS TITLE

SHEET NO.

A203

SCALE NOTED

APRIL 0I 2025

DATE





TOWN OF OAKVILLE

SCHEDULE A 37 COLONIAL CRESCENT

VARIANCE REQUESTS AND REASONS FOR VARIANCES

The proposed building project is a renovation and addition to a home on the lake in Oakville. The existing house was built prior to the 0 section bylaws and as such the existing structure does not comply with the bylaw. While these can be considered as legal non conforming the addition all falls within the existing footprint limits but parts of it still exceed the current bylaw requirements so these variances are required.

BUILDING DEPTH

The existing building has a depth of 25.40 m on each side of the house whereas the current bylaw only allows 20 M. The new addition is placed within the court created at the back but portions of it exceed the maximum allowable depth so we wish to simply request permission for the variance within the existing building depth.

The depth of the new addition is 23.00 m

BUILDING HEIGHT

The existing building has a height of 10.07M and the new building does not exceed that height and in fact the new addition has a lower height of **9.42 m**

DRIVEWAY WIDTH

The existing driveway exceeds the permitted width and we are redoing the landscaping design of the entire front court but wish to keep the parking pad for additional cars on the east side and thus the new driveway width is 13.2 M versus the permitted width of 9 M. The allowable landscape exceeds the required minimum.

We thus believe this request is certainly consistent with the Op and the zoning bylaw and given that none of the addition exceeds the width or height or depth of the existing house that the proposed variances meet all four tests and would seek the approval of the committee of adjustment for these three individually stated minor variances.

Yours Truly

William R Hicks

B Arch, OAA, MRAIC