

SHEET LIST		
SHEET NUMBER	SHEET NAME	
A0.1	COVER PAGE	
A1	SITE PLAN	
A2	WALKOUT PLAN	
A3	WALKOUT -SECTION A	
A4	WALKOUT -SECTION B	
A5	GAURD/HAND RAIL DETAILS	

No.	DATE	ISSUED FOR	APVD

SCOPE OF WORK

CLIENT:

ENGINEER:

PROJECT NAME:

3519 STEDFORD RD, OAKVILLE, ON

PROJECT ADDRESS:

Enter address here

SHEET NAME:

COVER PAGE


DATE: 2024-06-22 PROJECT No.:

SCALE: 00

DRAWN BY:Author SHEET No:

CHECKER: Checker

A0.1

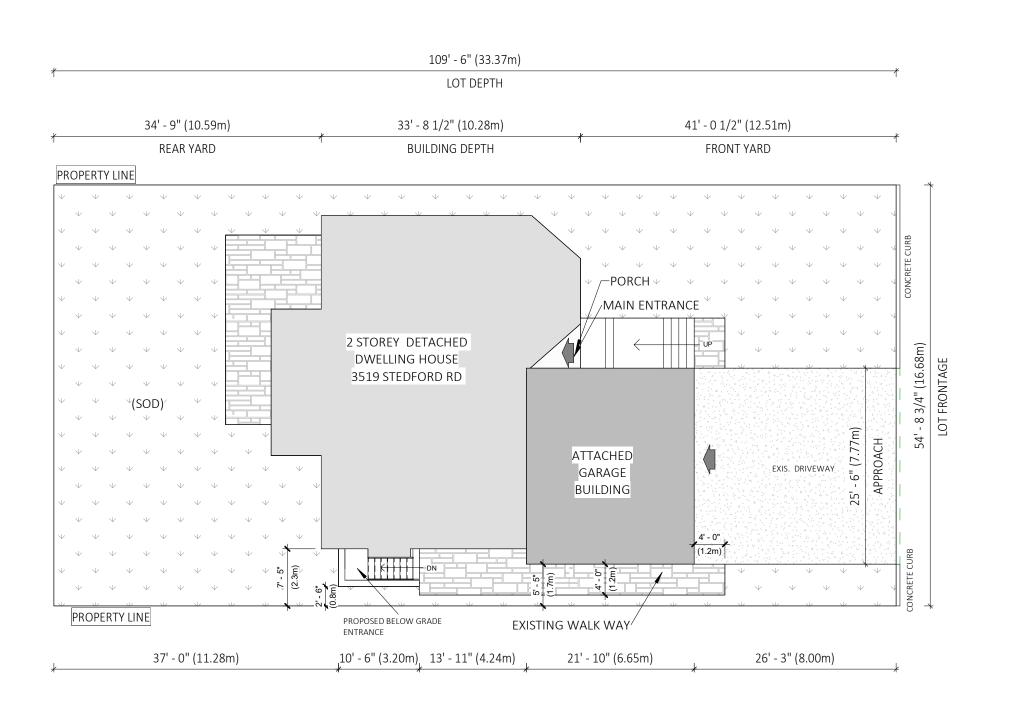

No.	DATE	ISSUED FOR	APVD
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3519 STEDFORD RD, OAKVILLE, ON

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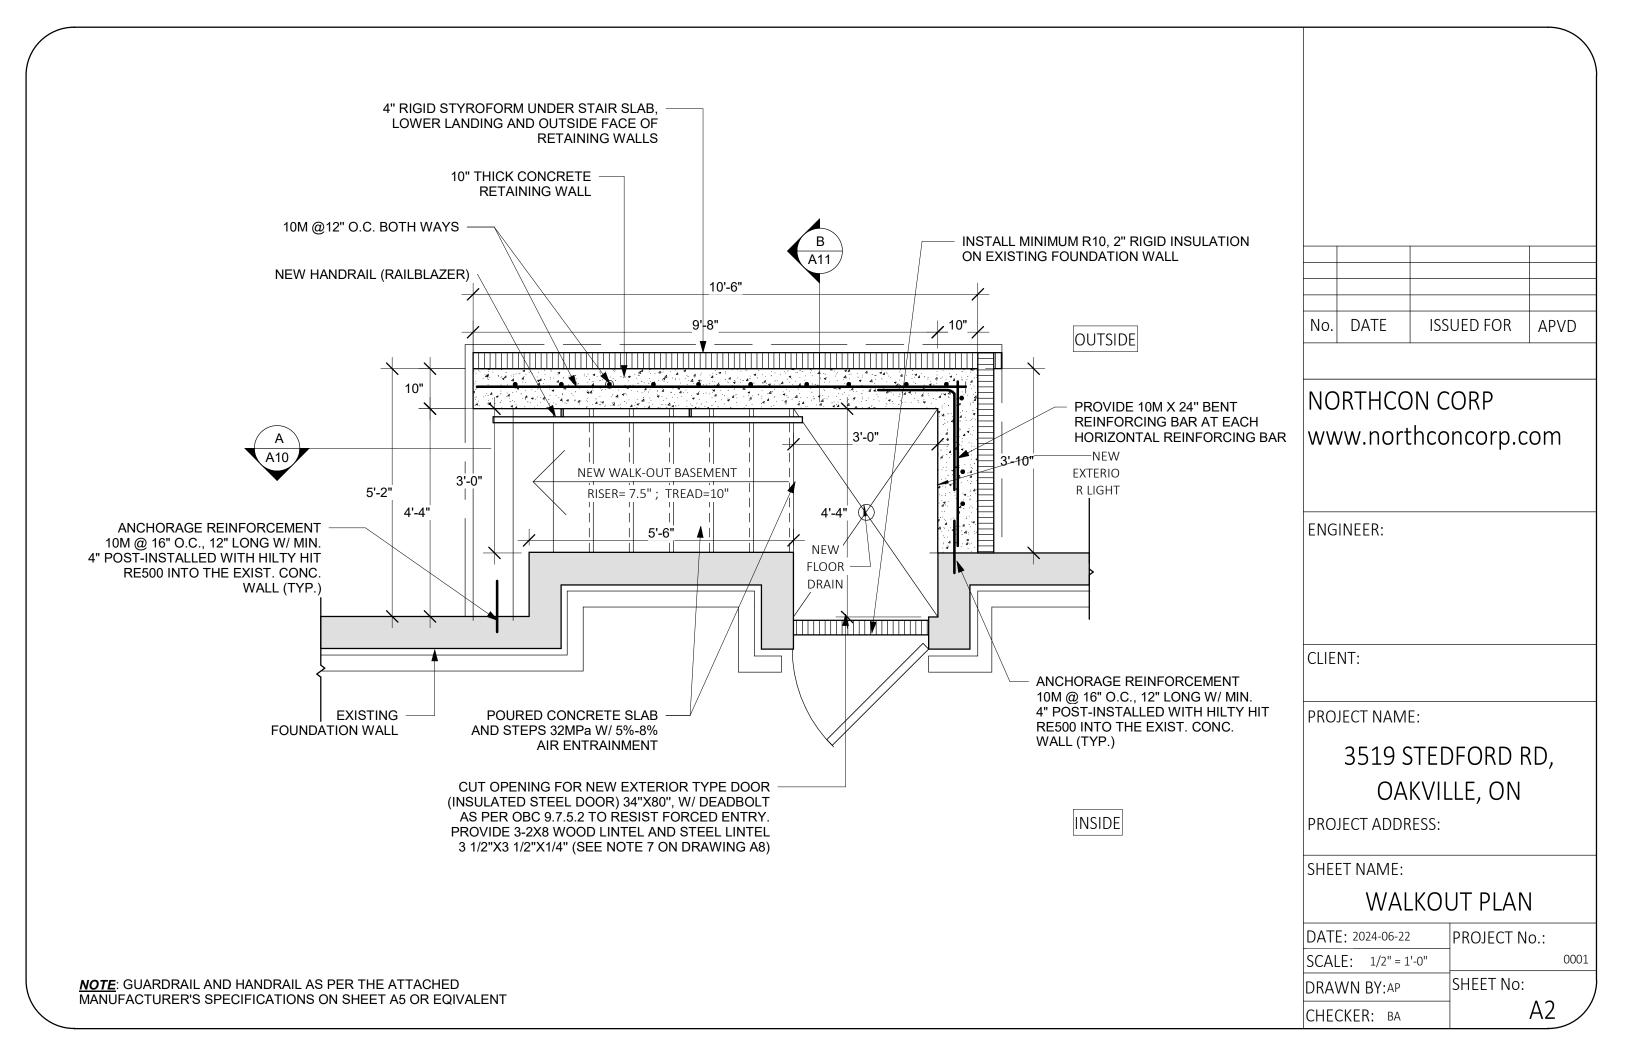
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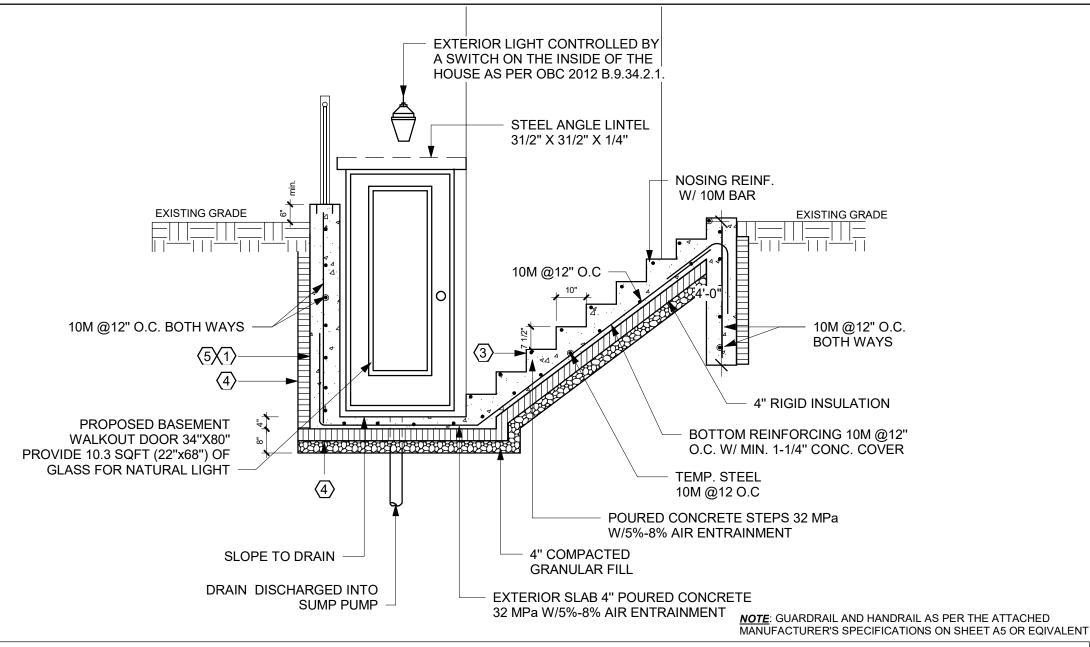
SHEET NAME:

SITE PLAN

DATE: 2024-06-22	PROJECT No.:
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DRAWING NOTES

1. CONCRETE

- MINIMUM COMPRESSIVE STRENGTH OF 32MPa @ 28 DAYS W/5% TO 8% AIR ENTRAINMENT

2. REINFORCEMENT

- MINIMUM YIELD STRENGTH OF STEEL 60 KSI
- THE REINFORCEMENT SHALL BE LAPPED A MINIMUM OF 450MM FOR 10M BARS AND 650MM FOR 10M BARS.

3. EXTERIOR STAIRS

RISE 4 7/8" MINIMUM 7 7/8" MAXIMUM RUN 10" MINIMUM 14" MAXIMUM ADJUST STEP SIZE TO SUIT SITE

4. INSULATION

- MIN. RSI 2.11 (R12) INSULATION & VAPOR BARRIER ON THE INSIDE FACE OF THE EXPOSED FOUNDATION WALL
- PROVIDE 4" THICK RIGID STYROFOAM INSULATION UNDER THE STAIR SLAB, LOWER LANDING AND OUTWARD FACE OF RETAINING WALLS

DRAWING NOTES

5. RETAINING WALL

- 10" POURED CONCRETE WALL W/NO REINFORCING REQUIRED FOR WALL HEIGHTS TO A MAX. OF 1200mm, UNLESS MENTIONED OTHERWISE
- PROVIDE 10M VERTICAL STEEL REINFORCEMENT @ 12" O.C. AND 10M HORIZONTAL REINFORCEMENT @ 12" O.C.

6. GUARDS

- 42" HIGH WHERE DISTANCE FROM GRADE TO BOTTOM OF WALKOUT EXCEEDS 5'-11" AND 36" FOR LESSER HEIGHTS. MAXIMUM 4" BETWEEN VERTICAL PICKETS

7. PROVIDE LINTEL AS FOLLOWS

- WOOD LINTEL: 3-2x8 SPF NO.1 or NO.2 WITH MINIMUM BEARING OF 4" AT EACH END
- STEEL LINTEL: 1L 3-1/2"x3-1/2"x1/4" ANGLE FOR BRICK VENEER WITH MINIMUM BEARING OF 6" AT EACH END
- STEEL LINTEL: 2L 3-1/2"x3-1/2"x1/4" ANGLE FOR SOLID MASONRY WITH MINIMUM BEARING OF 6" AT EACH END

8. EXTERIOR DOOR

- EXTERIOR TYPE DOOR (42MM INSULATED STEEL DOOR) SIZE 36"x80" (or 78"), W/DEADBOLT AS PER OBC 9.7.5.2. TO RESIST FORCED ENTRY.

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SECTION - A


DATE: 2024-06-22 PROJECT No.:

SCALE: 3/8" = 1'-0" 0001

DRAWN BY:AP SHEET No:

CHECKER: BA

А3

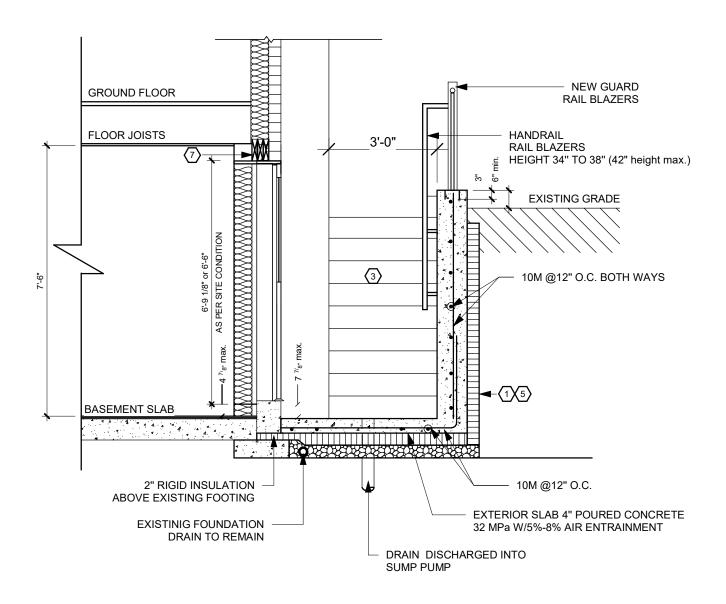

<u>NOTE</u>: GUARDRAIL AND HANDRAIL AS PER THE ATTACHED MANUFACTURER'S SPECIFICATIONS ON SHEET A5 OR EQIVALENT

GENERAL NOTES

- ALL WORK SHALL CONFORM TO ONTARIO BUILDING CODE (OBC) 2012, O. REF 332/12, AS AMENDED, CITY BY-LAWS AND STANDARDS
 - ALL WORKING ACCORDING TO GOOD CONSTRUCTION PRACTICES
- ALL FOOTINGS SHALL REST ON NATURAL UNDISTURBED SOIL OR COMPACTED GRANULAR FILL WITH A MINIMUM BEARING CAPACITY OF 75 KPA
 - WHERE THE FOUNDATIONS OF A BUILDING ARE TO BE CONSTRUCTED BELOW THE LEVEL OF THE FOOTINGS OF AN ADJACENT BUILDING AND WITHIN THE ANGLE OF REPOSE OF THE SOIL, OR THE UNDERPINNING EXCEEDS 1200mm OF LATERALLY UNSUPPORTED HEIGHT OR THE SOIL IS CLAY OR SILT, THE UNDERPINNING & RELATED CONSECUTION SHALL BE DESIGNED BY A PROFESSIONAL ENGINEER.
 - EXCAVATION SHALL CONFORM TO OBC 2012, O. REG. 332/12, AS AMENDED, DIVISION B, 9.12. BE UNDERTAKEN IN A MANNER SO AS TO PREVENT MOVEMENT WHICH WOULD CAUSE DAMAGE TO ADJACENT PROPERTIES, STRUCTURES, UTILITIES, —ROADS & SIDEWALKS.

GENERAL NOTES

- SHORE & BRACE WHERE NECESSARY TO ENSURE THE SAFETY & STABILITY OF THE EXISTING STRUCTURE DURING UNDERPINNING
 - DAMPROOFING ON THE INTERIOR SURFACE OF THE FOUNDATION WALL BELOW GRADE SHALL CONSISTS OF #2 TYPE BREATHER PAPER OR TYPE 'S' ROLL ROOFING
 - DRAINAGE SHALL CONFORM TO OBC 2012 O. REG. 332/12, AS AMENDED, DIVISION B, 9.14.
 - MAINTAIN PERIMETER FOUNDATION DRAINAGE MINIMUM 4 INCH DIAMETER WEEPING TILE, WITH A MINIMUM 6 INCH GRANULAR COVER.
 - ANY AREA DRAIN, EXTERIOR OF A BUILDING (IN A CONCRETE DECK OR IN THE LOWEST LANDING OF A STAIRWELL) SHALL BE CONNECTED TO EITHER THE STORM SEWER OR CONNECTED TO A SUMP PIT. IN EITHER SITUATION IT SHALL NOT BE CONNECTED TO THE SANITARY DRAINAGE SYSTEM OR WEEPING TILE

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SECTION - B

DATE: 2024-06-22

SCALE: 3/8" = 1'-0"

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