## FINISH BASEMENT — SECOND UNIT

# 2400 BARONWOOD DR, OAKVILLE





SITE DATA	
LOT AREA:	211.52 SQ M
ZONING	RM1 SP:269
BASEMENT FLOOR AREA:	56.19 SQ M
MAIN FLOOR AREA:	68.24 SQ M
SECOND FLOOR AREA:	65.01 SQ M

1 SITE DATA

A-0.0 SCALE 1:50

2 DRAWING LIST A-0.0 SCALE 1:50

DRAWING LIST

A-2.0

A - 3.0

DWG. NO. DWG. TITLE

COVERPAGE

ALL FLOOR PLAN

PLUMBING DETAIL

ASSEMBLY DETAIL

ELEVATION AND SECTION

GENERAL NOTES AND SITE PLAN





DO NOT SCALE THE DRAWING. WRITTEN DIMENSIONS SHALL HAVE PRECEDENCE OVER SCALED DIMENSIONS. CONTRACTOR SHALL VERIFY AND BE RESPONSIBLE FOR ALL DIMENSIONS AND CONDITIONS ON THE JOB, AND DVM ENGINEERING INC. SHALL BE INFORMED OF ANY VARIATIONS FROM THE DIMENSIONS AND CONDITIONS SHOWN ON THE DRAWING.

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ROJECT:

NO. DATE

REVISION TABLE

01-23-2025 ISSUED FOR BUILDING PERMIT
 02-07-2025 ISSUED FOR MINOR VARIANCE

1. 01-23-2025 ISSUED FOR BUILDING PERMIT

FINISH BASEMENT SECOND DWELLING

PROJECT ADDRESS:

2400 BARONWOOD DR, OAKVILLE, ON L6M 0J7

DRAWING TITLE:

COVERPAGE

DESIGNED BY:	DRAWN BY:	CHECKED BY:	
J.M.	G.M.	M.M.	
PROJECT NO.: 24012	SCALE: AS SHOWN	DATE: FEB 07, 2025	
DRAWING NO.:	REVISION	NO.:	

AWING NO.:

A-0.0

REVISION NO.:

R1

ISSUED FOR MINOR VARIANCE

#### **GENERAL NOTES:**

- READ IN CONJUNCTION WITH THE PROJECT SPECIFICATIONS.
- 2. CONTRACTOR IS RESPONSIBLE FOR ALL SITE PROTECTION AND SAFETY AND SHALL ENSURE THAT ALL CONSTRUCTION DEBRIS, MATERIAL STORAGE, DELIVERIES, EQUIPMENT, ETC. IS CONTAINED WITHIN THE PROJECT SITE BOUNDARIES.
- 3. CONTRACTOR SHALL ENSURE THAT ALL MATERIAL EXCLUDING NATIVE SOILS AND GRANULAR FILL SHALL BE STORED IN A DRY LOCATION AND PROTECTED FROM THE FLEMENTS.
- CONTRACTOR SHALL REPORT ANY DISCREPANCIES BETWEEN THE DRAWINGS AND SITE CONDITIONS TO THE ARCHITECT PRIOR TO COMMENCING ANY WORK.
- 5. CONTRACTOR SHALL ENSURE THAT ALL EXISTING TREES WITHIN THE PROJECT AREA SHALL BE PROTECTED FROM DAMAGE DURING THE COURSE OF CONSTRUCTION.
- 6. CONTRACTOR SHALL COORDINATE AND OBTAIN ALL WRITTEN APPROVALS FROM AUTHORITIES HAVING JURISDICTION PRIOR TO COMMENCING
- 7. CONTRACTOR SHALL COORDINATE WITH ALL MUNICIPAL AND PRIVATE SERVICE PROVIDERS TO OBTAIN UNDERGROUND AND / OR ABOVE GROUND SERVICES LOCATES PRIOR TO COMMENCING ANY WORK.
- 8. CONTRACTOR SHALL LAYOUT ALL PARTITION LOCATIONS FOR CONSULTANT'S REVIEW AND ADVISE CONSULTANT OF ANY DISCREPANCIES WITH THE DIMENSIONED PLANS OR CONFLICTS WITH OTHER PARTS OF THE WORK.
- ALL HINGED JAMBS OF THE DOOR FRAMES SHALL BE LOCATED 4" (100MM) FROM ADJACENT WALLS UNLESS NOTED OTHERWISE.
- 10. CONTRACTOR TO FOLLOW ALL MANUFACTURER'S RECOMMENDED INSTALLATION AND

SPECIFICATIONS FOR ALL FLOORING MATERIAL.

- 11. ALL FLOOR AREAS TO BE FEATHERED AS NECESSARY TO ENSURE THE SURFACE IS COMPLETELY SMOOTH PRIOR TO INSTALLATION OF FLOOR FINISHES. PROVIDE SKIM COAT AS
- 12. WHERE A CHANGE OF FLOORING MATERIAL OCCURS, JOINT IS TO BE IN LINE WITH THE DOOR THRESHOLD AND CONTRACTOR TO ENSURE THAT JOINT IS SMOOTH AND TIGHT.
- ENSURE THAT JOINT IS SMOOTH AND TIGHT.

  13. CONTRACTOR TO PROTECT ALL EXISTING FINISH SURFACES TO REMAIN DURING THE COURSE OF CONSTRUCTION.
- 14. ALL EXPOSED SURFACES OF SUCH AS ACCESS PANELS, GRILLES AND LINEAR DIFFUSERS ARE TO BE PAINTED TO MATCH THE CEILING COLOUR OR MATCH EXISTING LIKE MATERIALS UNLESS OTHERWISE NOTED.
- 15. ENSURE ALL JUNCTIONS BETWEEN DRYWALL AND ADJACENT SURFACES ARE SEAMLESS. PROVIDE CAULKING AT WOOD FRAME AND BASEBOARD JOINTS WHEN ADJACENT TO
- 16. PROVIDE 'BLUESKIN' WATERPROOF MEMBRANE AROUND ALL WINDOWS AND DOOR OPENINGS.
- 17. PROVIDE CONTINUOUS METAL FLASHING AT ALL BASE LOCATIONS

18. PROVIDE BELOW GRADE  $1-\frac{1}{2}$ " RIGID INSULATION

- TO A MIN. 2'-0" BELOW GRADE AT FOUNDATION WALLS.

  19. ALL FLOOR JOISTS SHALL BE SUPPORTED WITH JOIST HANGERS FULLY SECURED AS PER
- BOARDS.

  20. ALL WOOD BEAMS AND LINTELS SHALL HAVE A

MANUFACTURER'S SPECIFICATION IN ALL AREAS OF FLUSH WOOD LINTELS AND LEDGER

- 21. UNLESS OTHERWISE NOTED ALL LEDGER WALL ANCHORS SHALL BE ½"ø FULLY THREADED ROD c/w WELD NUTS, 1½"ø WASHERS, AND LOCK
- WASHERS SECURED FROM BOTH ENDS.

  22. UNLESS OTHERWISE NOTED ALL LVL LUMBER

MINIMUM 6" SOLID BEARING.

- SHALL BE GRADE 2E

  23. UNLESS OTHERWISE NOTED ALL SOLID BEARING
  (SB) SHALL BE A MINIMUM 3 STUD MEMBERS
  SIZED TO MATCH WALL STUD.
- 24. UNLESS OTHERWISE NOTED ALL MULTIPLE WOOD MEMBERS SHALL BE MECHANICALLY SECURED TO ONE ANOTHER WITH A MINIMUM OF 3-2½" ARDOX SPIRAL NAILS SPACED AT 6"
- 25. PROVIDE A MINIMUM 6" SOLID BEARING FOR ALL BEAM TYPES UNLESS OTHERWISE
- 26. CONTRACTOR SHALL ENSURE THAT ALL EXISTING FOOTINGS ARE PROTECTED AND ARE NOT DISTURBED AS A RESULT OF EXCAVATION REQUIREMENTS FOR NEW FOOTINGS.
- 27. CONTRACTOR SHALL BE RESPONSIBLE TO ERECT AND MAINTAIN ALL NECESSARY HOARDING AND SAFETY PRECAUTIONS IN ACCORDANCE WITH THE LATEST EDITION OF THE WSIB REGULATIONS. CONTRACTOR SHALL PROVIDE THE CLIENT WITH WRITTEN DOCUMENTATION FOR REVIEW PERTAINING TO THE TYPE, LOCATION, AND PHYSICAL REQUIREMENTS OF ANY HOARDING OR SAFETY PRECAUTIONS THAT MAY BE USED DURING THE
- 28. CONTRACTOR TO ENSURE THAT ALL SURFACES ARE PROPERLY CLEANED AND PREPARED TO RECEIVE FINISHES.

COURSE OF THE WORK.

- 29. PATCH AND REPAIR ALL EXISTING SURFACES AFFECTED BY THE WORK AND PREPARE TO ACCEPT NEW FINISHES AS PER DOCUMENTS.
- 30. REFER TO SPECIFICATIONS, SCHEDULES AND PLANS FOR PRODUCTS AND COLOUR INFORMATION FOR ALL FINISHES.REMOVE ALL SURFACE APPLIED ACCESSORIES, COVER PLATES AND OTHER DEVICES PRIOR TO PREPARING WALLS FOR NEW FINISHES. REINSTALL AFTER FINISHING IS COMPLETE ENSURING ACCESSORIES ARE LEVEL AND
- 31. ENSURE ALL MATERIAL ON SITE SITE IS STORED IN A DRY AREA FREE OF WATER AND MOISTURE. ENSURE ALL WOOD WHEN DELIVERED IS TAPED AND COVERED TO AVOID
- 32. ALL MATERIAL JOINTS AT GARAGE DEMISING PARTITIONS TO BE CAULKED WITH ACOUSTICAL CAULKING TO ENSURE GAS/VAPOUR SEAL.

33. ATTIC HATCH SHALL BE A MINIMUM 1'- $7\frac{3}{4}$ " x 2'-4" c/w WEATHER-STRIPPING AND R-40 RIGID INSULATION BACKING

SMOKE ALARMS/CARBON MONOXIDE DETECTORS:

- PROVIDE ONE SMOKE ALARM PER FLOOR
   WITHIN 2 METERS OF THE TOP OF EACH STAIR
   RUN
- 2. PROVIDE SMOKE ALARMS IN OR OUTSIDE EACH BEDROOM, IF OUTSIDE WITHIN 5 METERS MEASURED FOLLOWING CORRIDORS AND DOORWAYS, OF THE BEDROOM DOOR.
- 3. EACH ALARM SHALL BE PERMANENTLY
  CONNECTED TO AN ELECTRICAL CIRCUIT AND
  SHALL HAVE NO DISCONNECT SWITCH BETWEEN
  THE OVERCURRECT DEVICE AND THE ALARM.
- 4. EACH ALARM SHALL BE WIRED SO AS TO ACTIVATE SIMULTANEOUSLY IF ONE ALARM IS ACTIVATED.
- SMOKE ALARMS SHALL BE INSTALLED IN CONFORMANCE TO MANUFACTURES INSTRUCTIONS.
- 6. CARBON MONOXIDE DETECTORS SHALL CONFORM TO:
  CAN,/CGA-6.19 RESIDENTIAL CARBON MONOXIDE DETECTORS
  CSA 6.19 RESIDENTIAL CARBON MONOXIDE ALARMING DEVICES, OR
  UL 2034, SINGLE AND MULTIPLE STATION CARBON MONOXIDE DETECTORS
- 7. PROVIDE CEILING MOUNTED CARBON MONOXIDE DETECTORS ADJACENT TO EACH BEDROOM.
- 8. EACH DETECTOR SHALL BE PERMANENTLY CONNECTED TO AN ELECTRICAL CIRCUIT AND SHALL HAVE NO DISCONNECT SWITCH BETWEEN THE OVERCURRECT DEVICE AND THE DETECTOR. EACH DETECTOR SHALL BE WIRED SO THAT ITS ACTIVATION WILL ACTIVATE ALL DETECTORS.
- 9. EACH DETECTOR SHALL BE EQUIPPED WITH AN ALARM THAT IS AUDIBLE WITHIN THE BEDROOMS WHEN THE INTERVENING DOORS ARE CLOSED, AND WHERE LOCATED ADJACENT TO BED ROOMS.

### STAIRS HANDRAILS AND GUARDS:

#### STAIRS:

1. STAIR TREAD AND RISERS SHALL BE CONSTRUCTED WITH A UNIFORM RISE AND RUN IN ANY ONE FLIGHT.

STAIR RISE, RUN, TREAD AND NOSING MAXIMUM RISE = 8"

MAXIMUM RUN = 10"

MAXIMUM TREAD = 10"

MAXIMUM NOSING = 1"


#### HEADROOM:

1. THE HEADROOM MEASURED VERTICALLY FROM A LINE DRAWN THROUGH THE OUTER EDGES OF THE NOSINGS SHALL BE AT LEAST 6'-5".

#### HANDRAILS:

- 1. HANDRAILS SHALL BE PROVIDED ON AT LEAST ONE SIDE OF STAIRS LESS THAN 3'-7" IN WIDTH AND TWO SIDE OF STAIRS GREATER THAN 3'-7" IN WIDTH.
- NO HANDRAILS ARE REQUIRED FOR INTERIOR STAIRS NOT MORE THAN 2 RISERS, AND EXTERIOR STAIRS NOT MORE THAN 3 RISERS.
- PROVIDE ONE HANDRAIL FOR EXTERIOR STAIRS HAVING MORE THAN 3 RISERS.
- 4. HANDRAILS SHALL BE PLACED AT BETWEEN 2'-7" TO 3'-2" IN HEIGHT.
- 5. PROVIDE A MINIMUM 19/6" CLEARANCE BETWEEN HANDRAILS AND WALLS.
- 6. HANDRAILS SHALL BE ATTACHED TO WOOD STUDS, BLOCKING, STEEL STUDS OR MASONRY AT POINTS SPACED NOT MORE THAN 4'-8"
- 7. MINIMUM HEIGHT OF GUARD SHALL BE 3'-0" AFF WHERE THE WALKING SURFACE SERVED BY THE GUARD IS LESS THAN 6'-0" ABOVE THE FINISHED GROUND LEVEL.
- 8. MINIMUM HEIGHT OF GUARD WHERE WALKING SURFACE EEXCEEDS 6'-0" ABOVE THE FINISHED GROUND FLOOR LEVEL IS 3'-6".
- 9. NO OPENING WITHIN THE GUARD SHALL ALLOW

THE PASSAGE OF A 4" Ø SPHERE.

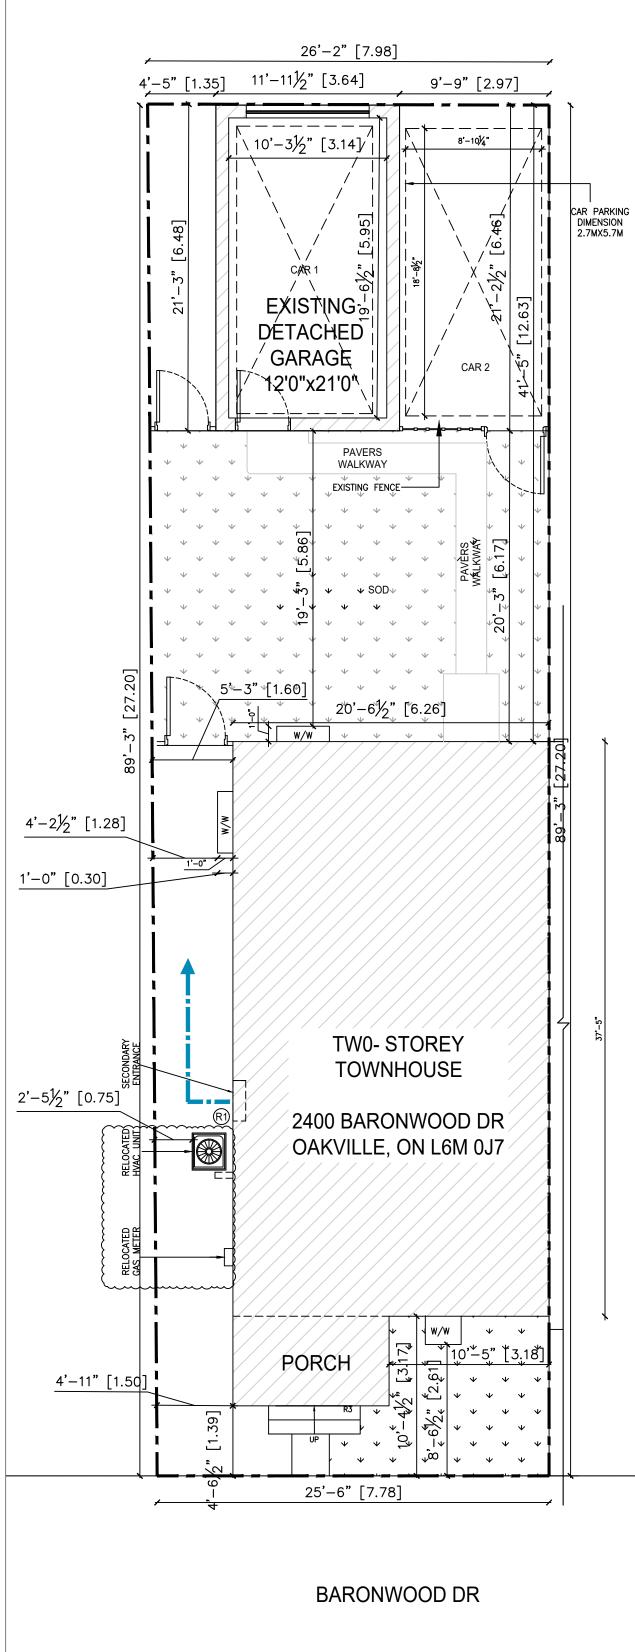

1 SITE PLAN A-1.0 SCALE 1:75 SITE STATISTICS AND ZONING PROVISIONS

MUNICIPAL ADDRESS:
2400 BARONWOOD DR
OAKVILLE, ON L6M 0J7

ZONING DESIGNATION: RM1 sp: 269

PROJECT DESCRIPTION: BUILDING PERMIT

NOTE FOR MINOR VARIANCE :

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	PERMITTED	EXISTING	PROPOSED
MIN. LOT AREA		371.20 SQ M	371.20 SQ M
MIN. LOT FRONTAGE		12.19 M.	12.19 M.
GROSS FLOOR AREA			
BASEMENT FLOOR AREA			56.19 SQ M
MAIN FLOOR AREA		68.24 SQ M	68.24 SQ M
SECOND FL. AREA		65.01 SQ M	65.01 SQ M
TOTAL GROSS FLOOR AREA		133.25 SQ M	189.44 SQ M.
BUILDING COVERAGE AREA		76.90 SQ M	76.90 SQ M
MIN. FRONT YARD SETBACK		1.39 M	1.39 M
MIN. SIDE YARD RIGHT SIDE		0.0 M	0.0 M
MIN. SIDE YARD LEFT SIDE		1.50 M	1.50 M
MIN. REAR YARD		12.63 M	12.63 M
PARKING(NO)		2	2

OUR PROPERTY HAS TWO (2) PARKING SPACES: ONE (1) INTERIOR AND ONE

ACCOMMODATE A THIRD PARKING SPACE AS REQUIRED BY THE BY-LAW.

THEREFORE, WE ARE REQUESTING A MINOR VARIANCE TO PERMIT AN

EXEMPTION FROM THE REQUIREMENT FOR A THIRD PARKING SPACE.

(1) EXTERIOR. DUE TO SITE CONSTRAINTS, WE ARE UNABLE TO

SEAL:

RROFESSIONAL

M.B.MAVANI

100178008

ISSUE TABLE

REVISION TABLE

DESCRIPTION

1. 01-23-2025 ISSUED FOR BUILDING PERMIT

2. 02-07-2025 ISSUED FOR MINOR VARIANCE

1. 01-23-2025 ISSUED FOR BUILDING PERMIT

NO. DATE

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MISSISSAUGA, ON L5N 5M3 Ph: (416) 451-5114 info@dvmeng.com

PROJECT:

FINISH BASEMENT SECOND DWELLING

PROJECT ADDRESS:

2400 BARONWOOD DR, OAKVILLE, ON L6M 0J7


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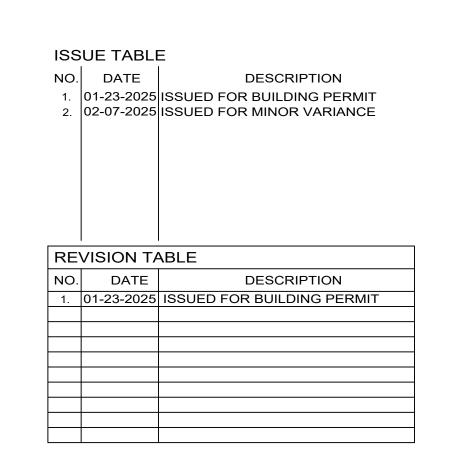
GENERAL NOTES AND SITE PLAN,SITE DATA

DESIGNED BY:	DRAWN BY:	CHECKED BY:
J.M.	G.M.	M.M.
PROJECT NO.: 24012	SCALE: AS SHOWN	DATE: FEB 07, 2025
DRAWING NO.:	REVISION	I NO.:

A-1.0 R1

ISSUED FOR MINOR VARIANCE



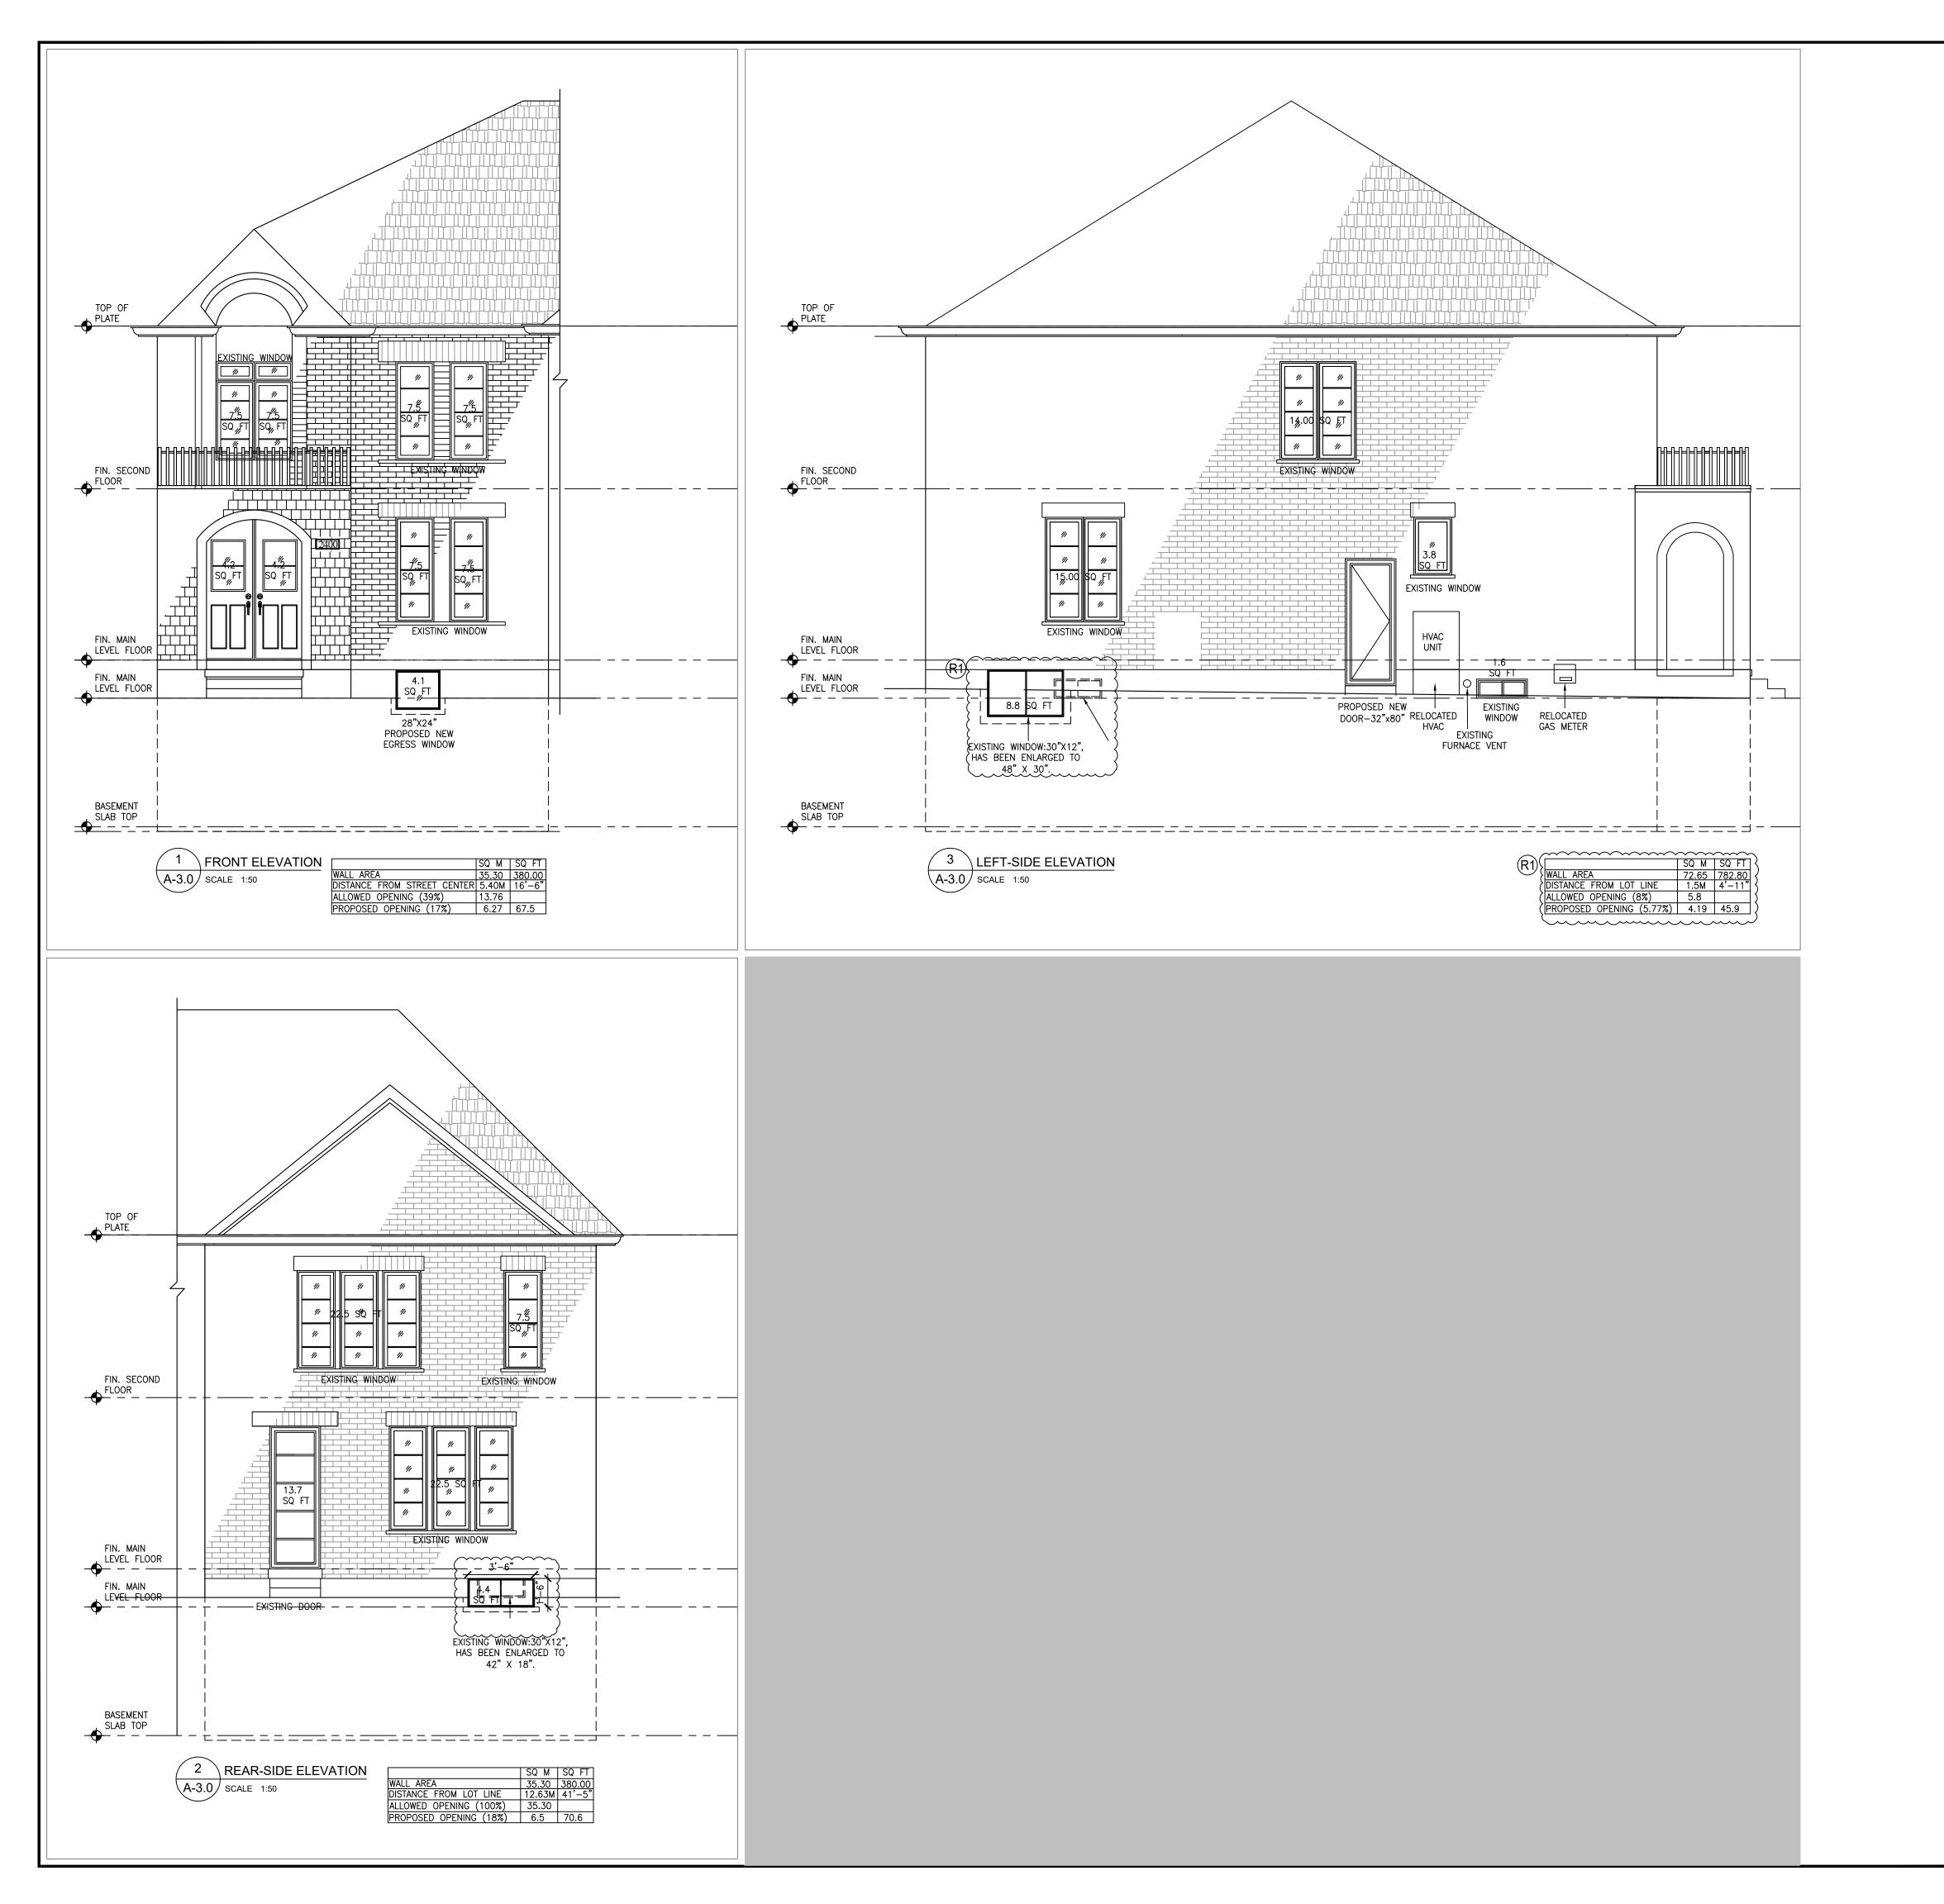



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PROJECT:

FINISH BASEMENT SECOND DWELLING

PROJECT ADDRESS:

2400 BARONWOOD DR, OAKVILLE, ON L6M 0J7

DAWING TITLE.

ELEVATION AND SECTION

DESIGNED BY: J.M.	DRAWN BY: G.M.		CHECKED BY: M.M.
PROJECT NO.: 24012	SCALE: AS SHOWN		DATE: FEB 07, 2025
DRAWING NO.:	REVISION		NO.:

A-4.0 R1

ISSUED FOR MINOR VARIANCE