

Diagram illustrating the installation of a snow fence in front of a tree. The tree is shown with a trunk and a canopy. A snow fence is positioned in front of the tree. The fence is divided into sections, with sections 1, 2, and 3 labeled. Section 1 is a standard snow fence panel. Section 2 is a snow fence panel with a diagonal brace. Section 3 is a snow fence panel with a diagonal brace. The fence is supported by a base. The diagram is labeled "SEE SECTION 4 FOR DETAILS" and "SNOW FENCING".

1. TREE PROTECTION BARRIERS MUST BE 1.2m (4'-0") HIGH, WAFFERBOARD HOARDING OR AN EQUIVALENT APPROVED BY URBAN FORESTRY SERVICES.
2. TREE PROTECTION BARRIERS FOR TREES SITUATED ON THE TOWN ROAD ALLOWANCE WHERE VISIBILITY MUST BE MAINTAINED CAN BE 1.2m (4'-0") HEIGHT AND CONSIST OF ORANGE PLASTIC WEB SNOW FENCING ON A WOOD FRAME MADE OF 2"x4" S.
3. WHERE SOME EXCAVATE OR FILL HAS TO BE TEMPORARILY LOCATED NEAR A TREE PROTECTION BARRIER, PLYWOOD MUST BE USED TO ENSURE NO MATERIAL ENTERS THE TREE PROTECTION ZONE.
4. ALL SUPPORTS AND BRACING SHOULD BE OUTSIDE THE TREE PROTECTION ZONE. ALL SUCH SUPPORTS SHOULD MINIMIZE DAMAGING ROOTS OUTSIDE THE TREE PROTECTION BARRIER.
5. NO CONSTRUCTION ACTIVITY, GRADE CHANGES, SURFACE TREATMENT OR EXCAVATIONS OF ANY KIND IS PERMITTED WITHIN THE TREE PROTECTION ZONE.
6. ALL LOCATES MUST BE OBTAINED PRIOR TO THE INSTALLATION OF THE PROPOSED HOARDING WITHIN THE MUNICIPAL RIGHT OF WAY.

1.	A SIGN (AS PER BELOW) MUST BE MOUNTED ON ALL SIDES OF A TREE PROTECTION BARRIER FOR THE DURATION OF THE PROJECT. THE SIGN SHOULD BE A MINIMUM OF 40cmX60cm AND MADE OF WHITE GATOR BOARD OR EQUIVALENT MATERIAL.
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TOWN OF OAKVILLE
PARKS AND RECREATION
DEPARTMENT


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(A1.2) SCALE: DNS

3. THE EROSION & SEDIMENT CONTROL FENCE SHALL BE AS DETAILED.

A2.1 SCALE: DNS



A2.1 SCALE: 1:150

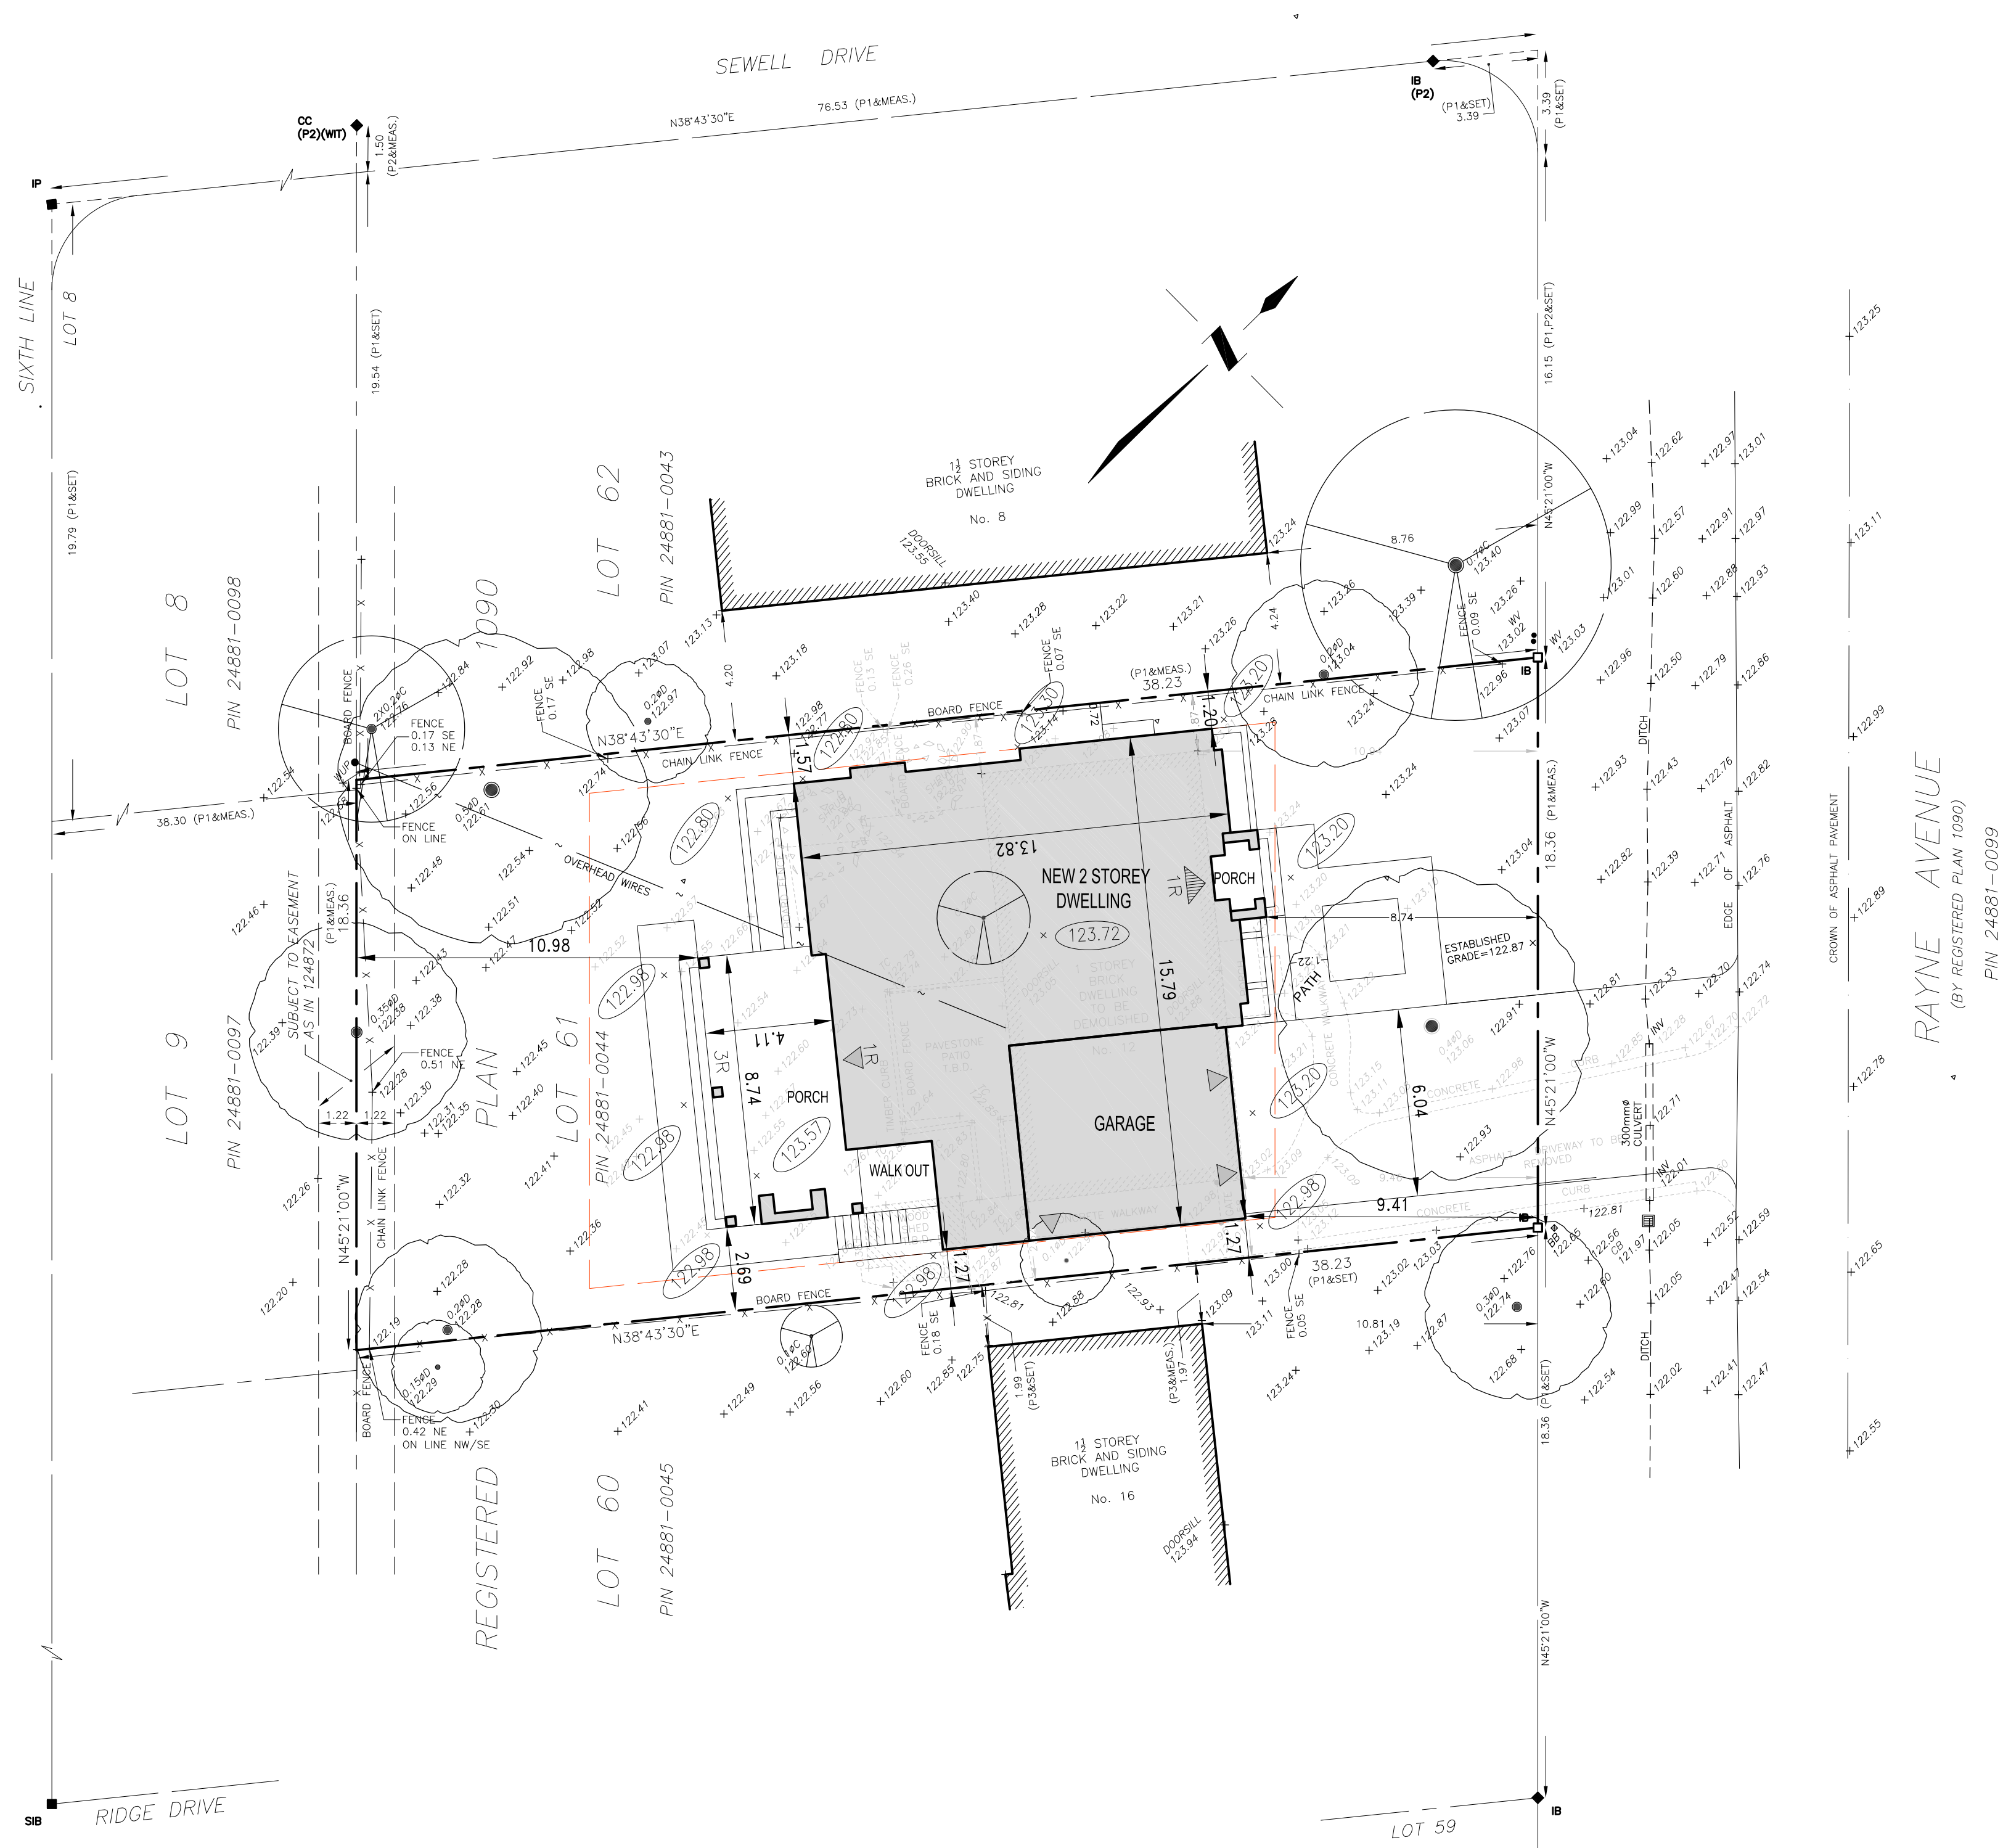A2.1 SCALE: DNS

COMMENTS: NOTE LOCATION OF FENCES.



A2.1 SCALE: DNS

A2.1 SCALE: DNS

A2.1 SCALE. NA

2	11.18.24	REVISED FOR C.O.A. DEFERRAL
1	09.21.24	ISSUED FOR GRADING DESIGN
REF.	DATE:	DESCRIPTION:



A1.2








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DATE:



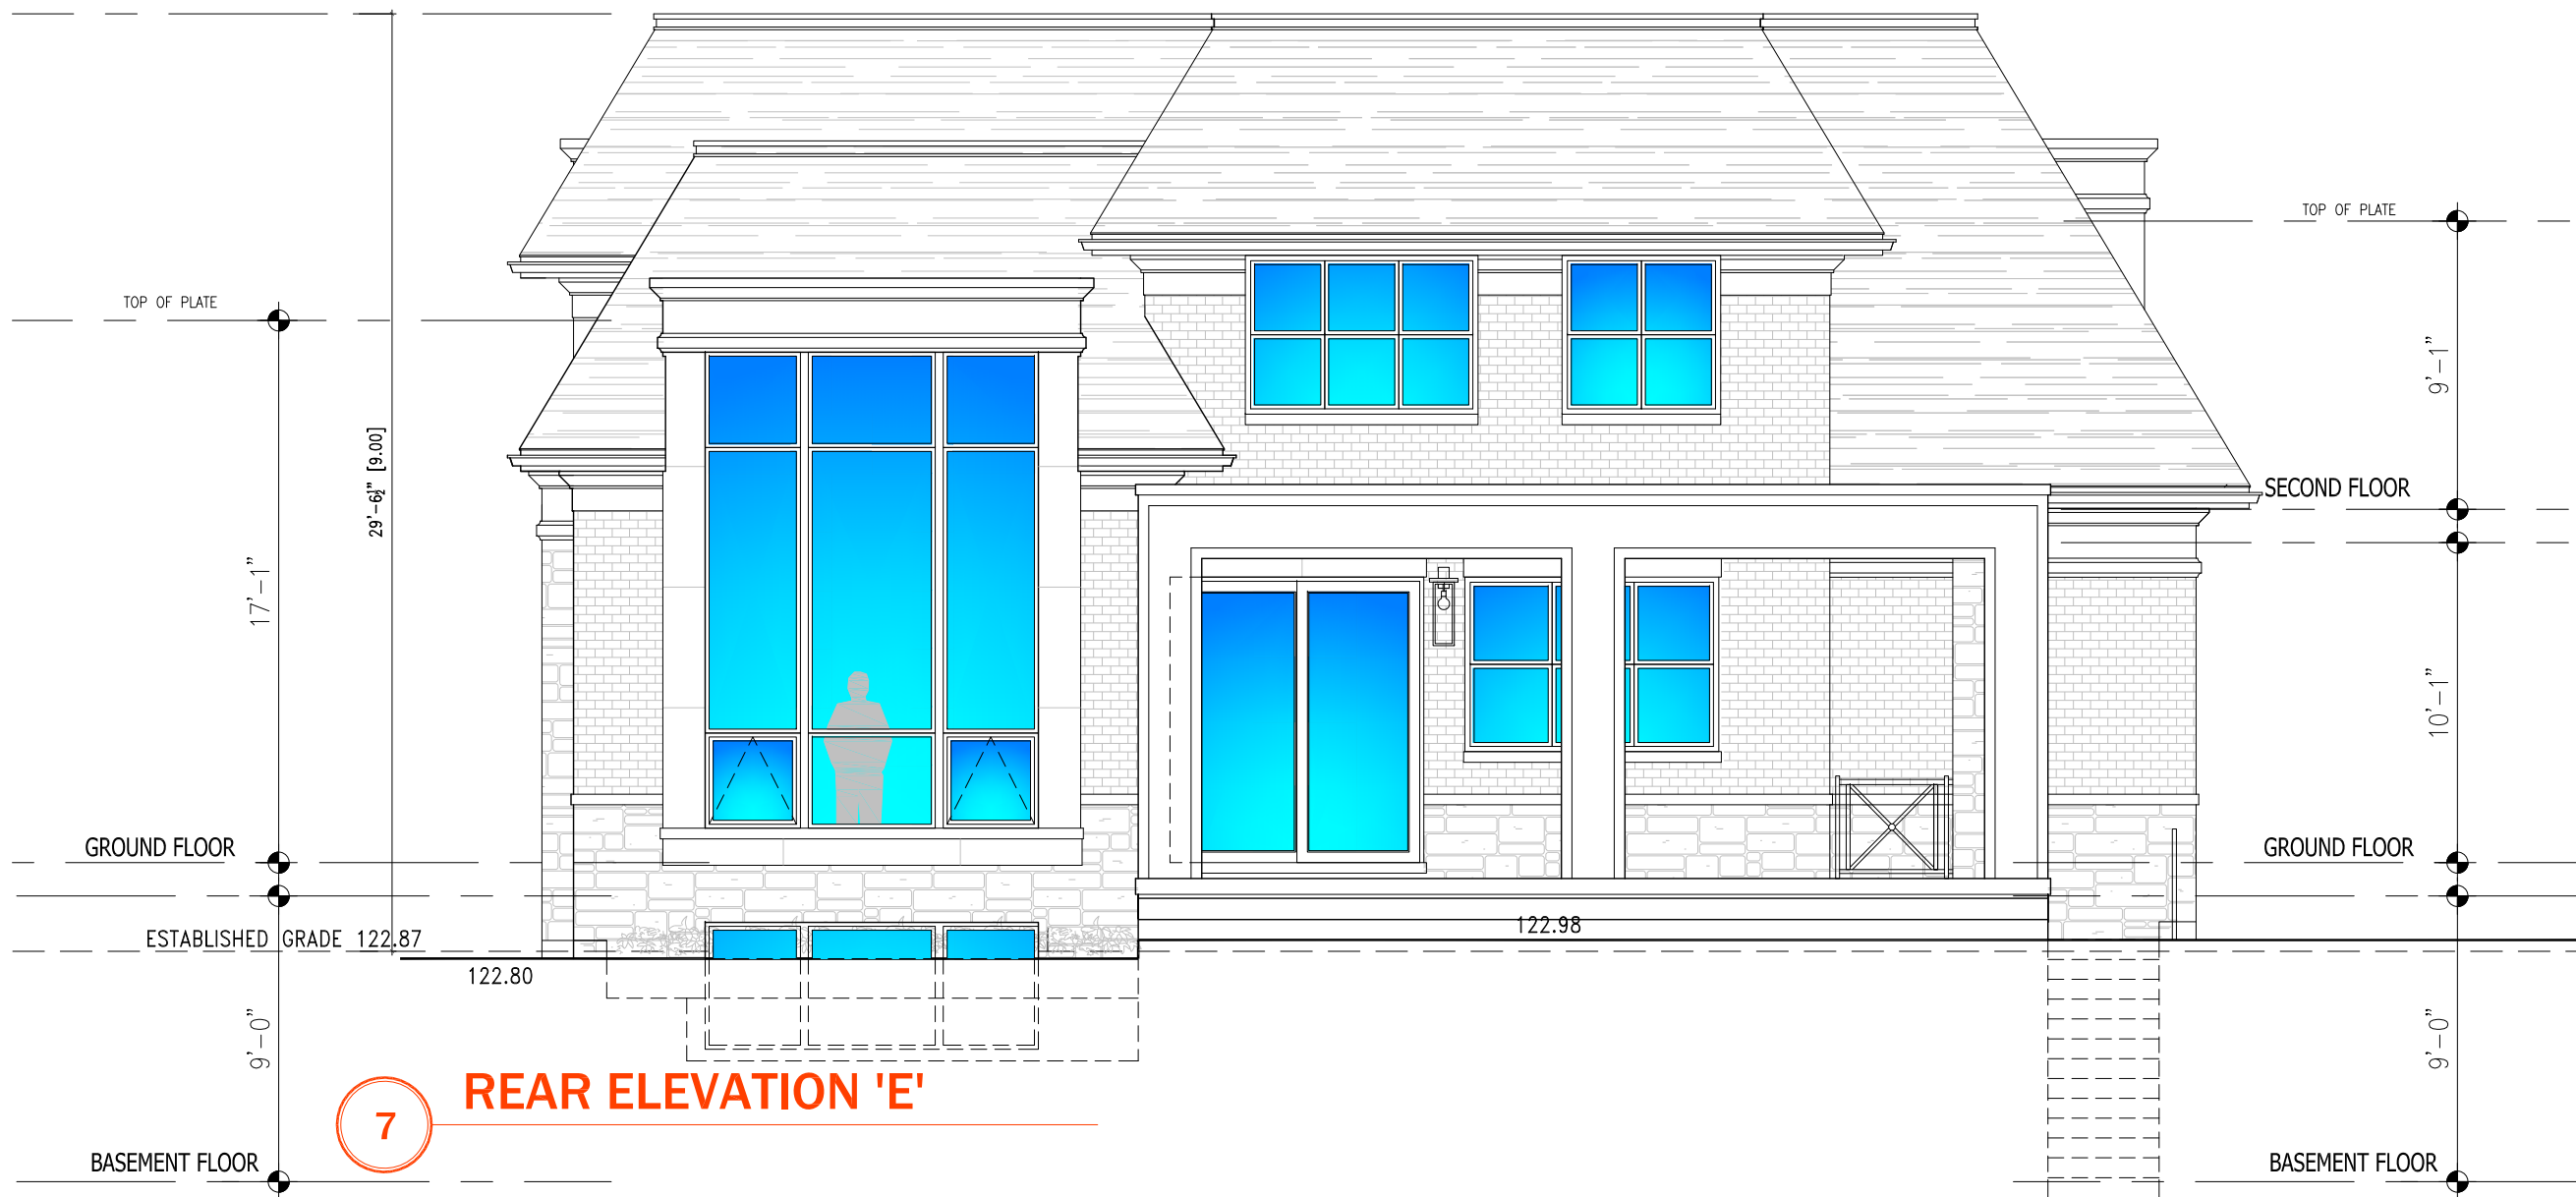

KEYSTONE

HOME DESIGNS

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251 NORTH SERVICE RD.
SUITE 303
OAKVILLE, ON.
L6M 3E7
905-616-2221
info@keystonehomedesigns.com
www.keystonehomedesigns.com

NOT FOR CONSTRUCTION

PROJECT:

WALIA
RESIDENCE

12 RAYNE AVENUE.
OAKVILLE, ON.

ELEVATION

PROJECT: 24-06

DATE: NOV. 17.2024


SCALE: N.T.S.

DRAWN BY: G. CASTILLO

A4.4

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DATE:

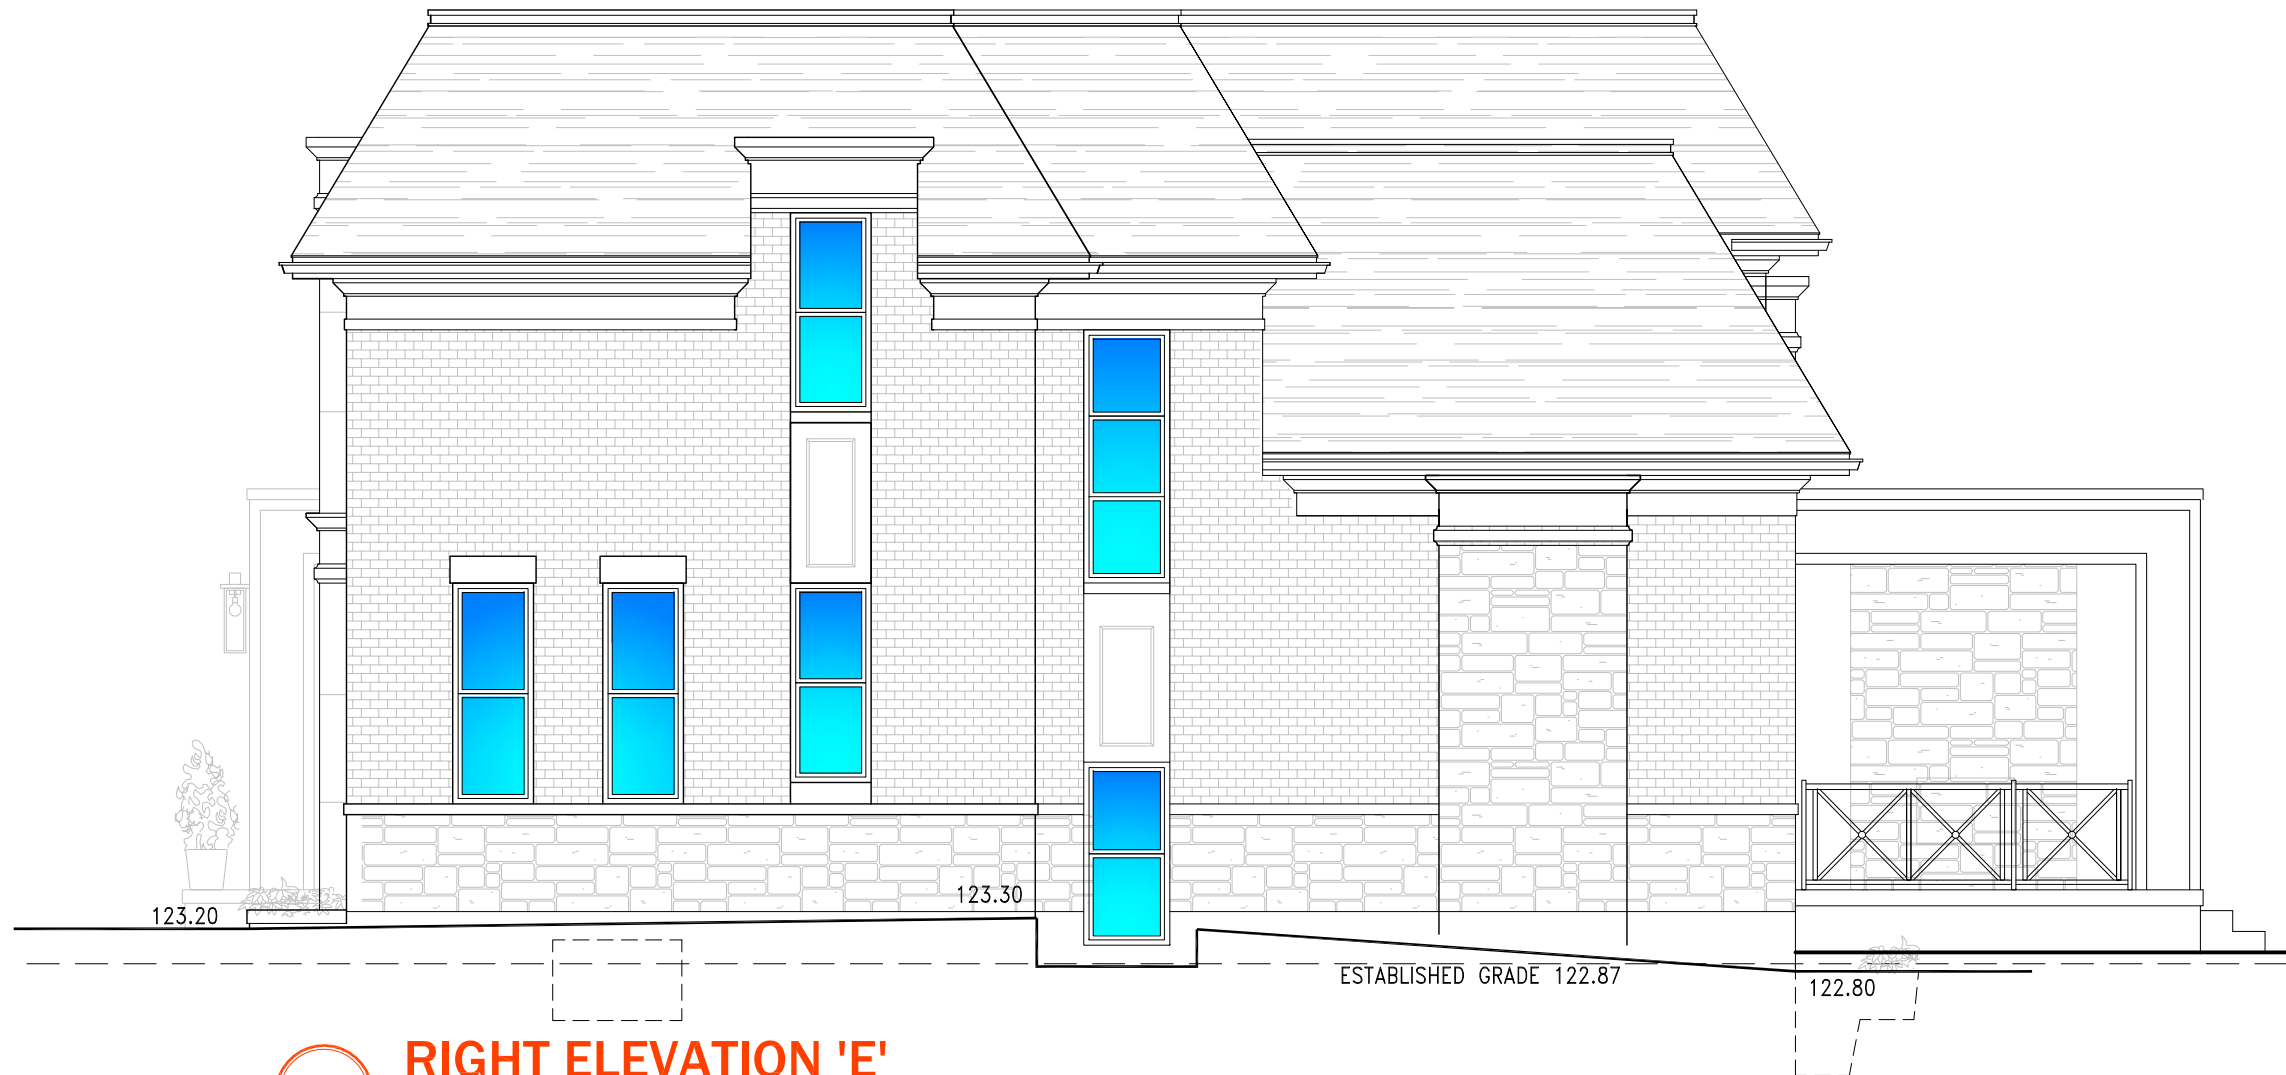

6

RIGHT ELEVATION 'E'



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ELEVATION

PROJECT:

24-06

DATE:

NOV. 17.2024

SCALE:

N.T.S.

DRAWN BY:

G. CASTILLO

A4.3

DESIGNED APPROVED BY:

DATE:



5

LEFT ELEVATION 'E'



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ELEVATION

PROJECT:

24-06

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NOV. 17.2024

SCALE:

N.T.S.

DRAWN BY:

G. CASTILLO

A4.2

DESIGNED APPROVED BY:

DATE:



4 FRONT ELEVATION 'E'



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NOV. 17, 2024

SCALE:

N.T.S.

DRAWN BY:

G. CASTILLO

A4.1