

TREE PROTECTION BARRIERS MUST BE 1.2m (4'-0") HIGH. WAFERBOARD HOARDING OR AN EQUIVALENT APPROVED BY URBAN FORESTRY SERVICES. TREE PROTECTION BARRIERS FOR TREES SITUATED ON THE TOWN ROAD ALLOWANCE WHERE VISIBILITY MUST BE MAINTAINED CAN BE 1.2m (4'-0") HEIGHT AND CONSIST OF ORANGE PLASTIC WEB SNOW FENCING ON A WOOD FRAME MADE OF 2"X4"'S.

WHERE SOME EXCAVATE OR FILL HAS TO BE TEMPORARILY LOCATED NEAR A TREE PROTECTION BARRIER, PLYWOOD MUST BE USED TO ENSURE NO MATERIAL ENTERS THE TREE PROTECTION ZONE.

ALL SUPPORTS AND BRACING SHOULD BE OUTSIDE THE TREE PROTECTION ZONE. ALL SUCH SUPPORTS SHOULD MINIMIZE DAMAGING ROOTS OUTSIDE THE TREE PROTECTION BARRIER.

NO CONSTRUCTION ACTIVITY, GRADE CHANGES, SURFACE TREATMENT OR EXCAVATIONS OF ANY KIND IS PERMITTED WITHIN THE TREE PROTECTION ZONE. ALL LOCATES MUST BE OBTAINED PRIOR TO THE INSTALLATION OF THE PROPOSED HOARDING WITHIN THE MUNICIPAL RIGHT OF WAY.

SECTION 4, SIGNAGE

A SIGN (AS PER BELOW) MUST BE MOUNTED ON ALL SIDES OF A TREE PROTECTION BARRIER FOR THE DURATION OF THE PROJECT. THE SIGN SHOULD BE A MINIMUM OF 40cmX60cm AND MADE OF WHITE GATOR BOARD OR EQUIVALENT MATERIAL.

"TREE PROTECTION ZONE NO GRADE CHANGE, STORAGE OF MATERIALS OR EQUIPMENT IS PERMITTED WITHIN THIS AREA. THE TREE PROTECTION BARRIER MUST NOT BE REMOVED WITHOUT THE WRITTEN AUTHORIZATION OF THE TOWN OF CARVILLE

> TOWN OF OAKVILLE PARKS AND RECREATION DEPARTMENT

NAME: TREE PROTECTION BARRIERS

FILE NO.:

SOLID HOARDING (PLYWOOD BOARDS)

FRAMED HOARDING (PLASTIC SAFETY FENCING)

1 OAKVILLE SITE REQUIREMENTS

A1.2 SCALE: DNS

1. GENERAL NOTES: A) SILTATION CONTROL MEASURES SHALL BE IMPLEMENTED BY THE CONTRACTOR PRIOR TO THE COMMENCEMENT OF SITE GRADING WORKS. TO SATISFACTION OF THE CITY AND HALTON CONSERVATION.

B) IF CONSTRUCTION IS INTERRUPTED AND/OR INACTIVITY EXCESS 30 DAYS, STRIPPED/ BASE AREAS SHALL BE STABILIZED BY SEEDING.

C) THE SEDIMENT CONTROL DEVICES SHALL BE INSPECTED AFTER EVERY RAINFALL AND/ OR EVERY WEEK.

D) THE SEDIMENT CONTROL DEVICES MUST BE REPAIRED, CLEANED AND/ OR REPLACED IF NECESSARY OR AS DIRECTED BY THE ENGINEER. CONSERVATION AUTHORITY OR THE CITY.

E) ALL SEDIMENT CONTROL DEVICES SHALL REMAIN IN PLACE UNTIL ALL CONSTRUCTION, GRADING, TOPSOILING AND SODDING ARE COMPLETE.

F) WHEN ALL CONSTRUCTION, GRADING AND SODDING IS COMPLETED. THE SEDIMENT CONTROL DEVICES SHALL BE REMOVED AND THE DISTURBED AREAS REINSTATED.


2. ALL CATCH BASINS ON SITE SHALL HAVE PROPER SEDIMENT CONTROLS AS NOTED HEREON.

3. THE EROSION & SEDIMENT CONTROL FENCE SHALL BE AS

4. CONTRACTOR TO OBTAIN ALL NECESSARY ROAD OCCUPANCY PERMITS FOR PROPOSED WORKS WITHIN THE MUNICIPAL ROAD ALLOWANCES.


2 EROSION AND SEDIMENT CONTROL

A2.1 SCALE: DNS

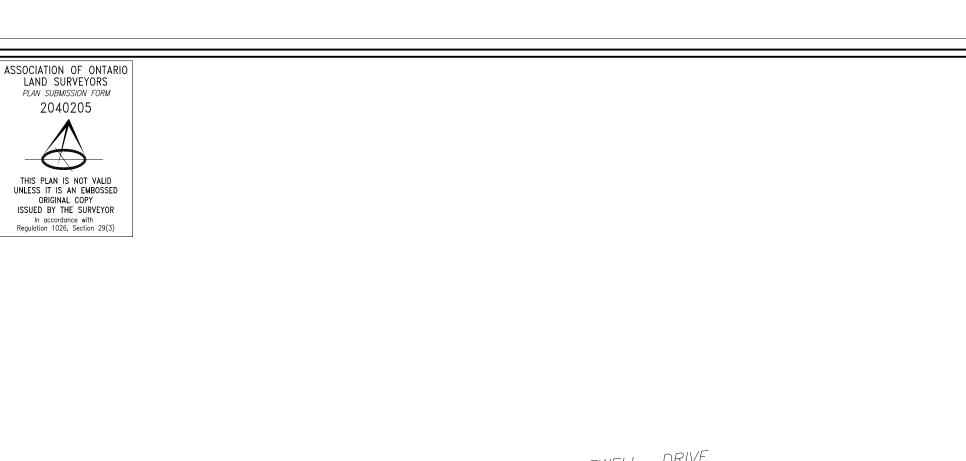

REPORT SUMMARY PROPERTY DESCRIPTION: 12 RAYNE AVENUE, BEING LOT 61, REGISTERED PLAN 1090, TOWN OF OAKVILLE, REGIONAL MUNICIPALITY OF HALTON, PIN 24881-0044 EASEMENTS/RIGHTS-OF-WAY: SUBJECT TO EASEMENT IN FAVOUR OF THE BELL TELEPHONE COMPANY OF CANADA AS IN 124872

COMMENTS: NOTE LOCATION OF FENCES.

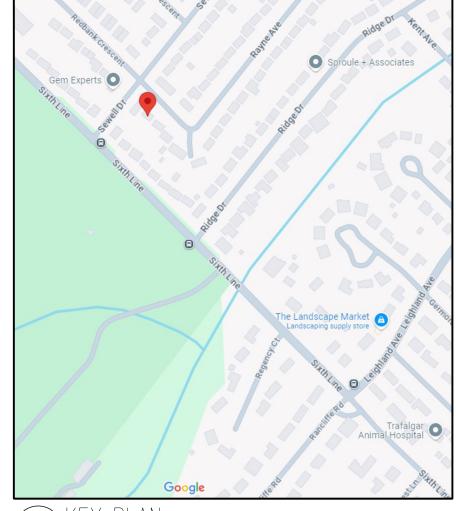

A21/SCALE: DNS

ZONING 12 RAYNE AVE.

ZONE RL7-0 697.7 m.²(7,509 SQ.FT.) LOT AREA: MIN. LOT FRONTAGE: MAXIMUM HEIGHT: 244.19m² (2,628 s.f.) MAX. LOT COV. 35%: 286.05m² (3,078 s.f.) MAX. R.F.A. 41%: MIN FRONT SETBACK: APROX. 8.46m. MIN SIDE SETBACK: 7.5m. MIN REAR SETBACK: PROPOSED $(154.31\text{m}^2)1,661\text{ s.f.}$ **GROUND FLOOR** $(153.84\text{m}^2)1,656 \text{ s.f.}$ SECOND FLOOR EXT. GARAGE (45.98m²) 495 s.f. INT. GARAGE (42.08m^2) 453 s.f.

PROPOSED LOT COV.: 34.47% (240.52m²) 2,589 s.f. PROPOSED R.F.A. (44.17%): (308.15m²) 3,317 s.f. 9.0 m

 $(40.22m^2)$ 433 s.f.

09.21.24 | ISSUED FOR GRADING DESIGN REF. DATE: DESCRIPTION:

Drawings must NOT be scaled. Contractor must check and verify all dimensions, specifications and drawings on site and report any discrepancies to the architect prior to proceeding with any of the work.

SITE LEGEND:

FINISHED FLOOR ELEVATION

FINISHED DECK ELEVATION

PROPOSED ADDITION AREA

EXISTING TREE TO REMAIN

RAIN WATER DOWNSPOUT

EXISTING TREE TO BE REMOVED

SITE ACCREDITATION

REGISTERED PLAN 1090

REGIONAL MUNICIPALITY OF HALTON

INFORMATION TAKEN FROM A SURVEY PREPARED BY:

TARASICK McMILLAN KUBICKI LIMITED 9438-SRPR-T

DISTANCES SHOWN ON THIS PLAN ARE IN METRES

AND CAN BE CONVERTED TO FEET BY DIVIDING BY

ELEVATIONS ARE REFERRED TO CANADIAN GEODETIC

VERTICAL DATUM-1928, AND WERE DERIVED FROM TOWN

OF OAKVILLE, BENCHMARK No. 227, HAVING A PUBLISHED

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SECONDARY ENTRANCE

FINISHED BASEMENT ELEVATION

EXISTING GRADE FINISHED GRADE

MAIN ENTRANCE

TREE HOARDING

PLAN OF TOPOGRAPHY OF

TOWN OF OAKVILLE

ONTARIO LAND SURVEYORS

AUGUST 15, 2024

ELEVATION OF 131.8305 metres.

LOT 61

0.3048.

--- PROPERTY LINE

A2.1 SCALE: DNS

COVERED PORCHES

(GARAGE & PORCHES INCL'D.)

PROPOSED ROOF HEIGHT

(& COV'D AREAS)

REGIONAL APPROVAL

REGION DESIGN OF WATER AND/OR WASTEWATER SERVICES APPROVED SUBJECT TO DETAIL CONSTRUCTION CONFORMING TO HALTON REGION STANDARDS AND SPECIFICATIONS AND LOCATION APPROVAL FROM THE AREA MUNICIPALITY.

INFRASTRUCTURE PLANNING AND POLICY

THE APPLICANT SHOULD BE AWARE THAT THE APPROVAL OF THE WATER SYSTEM ON PRIVATE PROPERTY IS THE RESPONSIBILITY OF THE LOCAL MUNICIPALITY. REGARDLESS, THE APPLICANT MUST ENSURE THAT THE REGION OF HALTON'S STANDARDS AND SPECIFICATIONS ARE MET (THE WATER AND WASTEWATER LINEAR DESIGN MANUAL MAY BE OBTAINED FRO<u>M THE DATA MANAGEMENT GROU</u>P AT 905-825-6032) FURTHERMOFALL WATER QUALITY TESTS MUST BE COMPLETED TO THE REGION OF HALTON'S SATISFACTION BEFORE THE WATER SUPPLY CAN BE TURNED

6 REGION OF HALTON A2.1 SCALE: DNS

7 GRADING CERTIFICATE
A2.1 SCALE: NA

CERTIFICATION FOR PROPOSED GRADING



INFO@KEYSTONEHOMEDESIGNS.COM

905.616.2221 251 NORTH SERVICE RD. SUITE 303

OAKVILLE, ON. L6M 3E7 905-616-2221 info@keystonehomedesigns.com www.keystonehomedesigns.com

CLIENT:


WALIA RESIDENCE

ADDRESS: 12 RAYNE AVENUE OAKVILLE, ON. DRAWING TITLE:

SITE PLAN

DRAWN: G.C. DATE: 09/15/24 JOB NUMBER: 24-06

SCALE: AS SHOWN SHEET NUMBER: A2.1

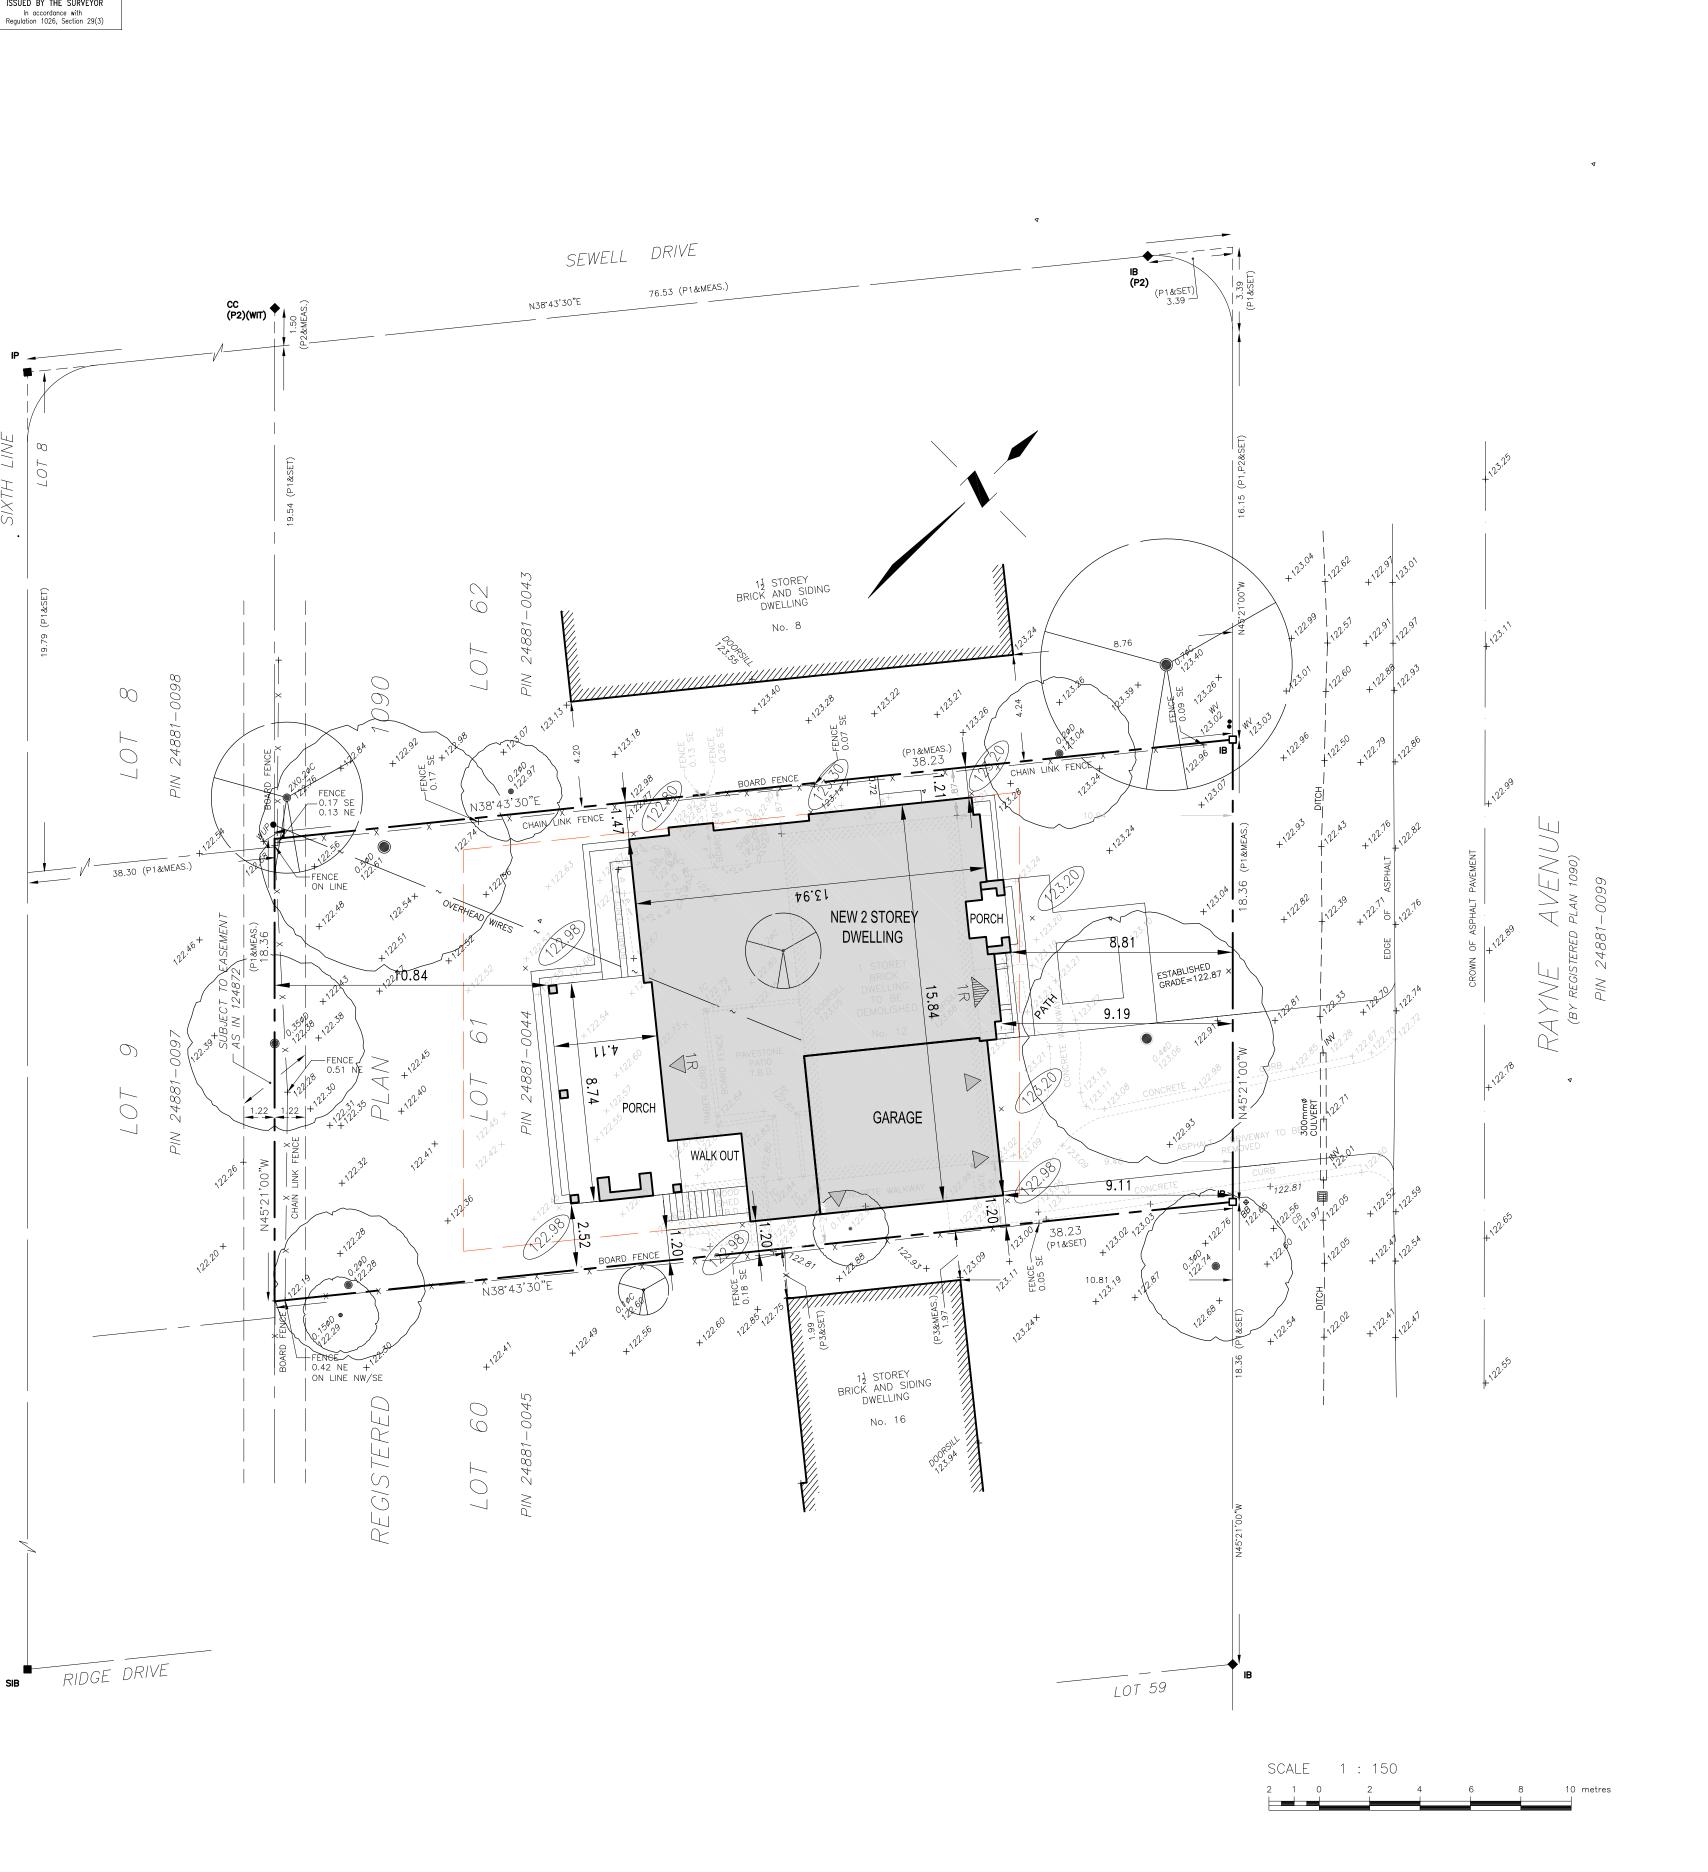

A2.1 SCALE: 1:150



DESIGNED APPROVED BY:

DATE:





© 202

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NOT FOR CONSTRUCTION

PROJECT:

WALIA RESIDENCE

12 RAYNE AVENUE. OAKVILLE, ON. **ELEVATION 'B3'**

PROJECT: 24-06

DATE: SEP.09.24

SCALE: N.T.S.

G. CASTILLO

A4.2

DESIGNED APPROVED BY:

DATE:





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NOT FOR CONSTRUCTION

PROJECT:

WALIA RESIDENCE

12 RAYNE AVENUE. OAKVILLE, ON. **ELEVATION 'B3'**

PROJECT: 24-06

DATE: SEP.09.24

SCALE: N.T.S.

G. CASTILLO

A4.3

DESIGNED APPROVED BY:

DATE:





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NUI FUR CUNSTRUCTIUN

WALIA RESIDENCE

PROJECT:

12 RAYNE AVENUE. OAKVILLE, ON. ELEVATION 'B4'

PRO)JECT: 24-06
DAT	E: SEP.10.24
SCA	N.T.S.
DRA	WN BY:

G. CASTILLO

A4.4





