



SURVEYOR'S REAL PROPERTY REPORT - PART 1 PLAN OF SURVEY OF

PART OF LOT C. BLOCK 16 REGISTERED PLAN I TOWN OF OAKVILLE

REGIONAL MUNICIPALITY OF HALTON

20 Metres

Scale 1:200

J. H. Gelbloom Surveying Limited Ontario Land Surveyor

2024

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SURVEYOR'S REAL PROPERTY REPORT - PART 2

REGISTERED EASEMENTS AND/OR RIGHT-OF-WAY

NOTABLES Note the location of the Fences around the Subject Property.

#### LEGEND

IB

Survey Monument Set North Survey Monument Found East South SIB Standard Iron Bar Iron Bar West TOC Top of Concrete McConnell and Maughan Ltd., O.L.S. Board Fence

(950)F. G. Cunningham O.L.S. J. H. Gelbloom Ltd., O.L.S. (1808)(OU) Origin Unknown (WIT) Witness

Plan 20R-20256 UGS Unfinished Garage Sill Elevation

Specified Control Point SCP

Elevations are Geodetic and are Referred to the Geodetic Surveys of Canada Benchmark No. 18 having an Elevation of 90.393 m.

This REPORT can be updated by this office, however NO ADDITIONAL PRINTS of this ORIGINAL REPORT will be issued, subsequent to the DATE OF CERTIFICATION.

All building ties are from the foundation and are perpendicular to property lines, unless otherwise noted.

This REPORT was prepared for Craig Auwaerter and the undersigned accepts no responsibility for use by other parties.

Distances shown on this plan are in metres and can be converted to feet by dividing by 0.3048.

BEARINGS ARE GRID, DERIVED FROM SPECIFIED CONTROL POINTS LISTED IN THE FOLLOWING TABLE, AND ARE REFERENCED TO THE THE CENTRAL MERIDIAN OF 6° UTM ZONE 17 (81° WEST LONGITUDE) NAD83 (ORIG).

SPECIFIED CONTROL POINTS: UTM ZONE 17, NAD83 (ORIG). COORDINATES TO URBAN ACCURACY PER SEC. 14(2) OF O.REG. 216/10

		, ,
POINT ID	NORTHING	EASTING
00119653145	4 810 478.250	608 001.415
04519910016	4 812 799.242	609 426.602
00819830507	4 812 448.026	606 736.355

COORDINATES CANNOT, IN THEMSELVES, BE USED TO RE-ESTABLISH CURNERS OR BOUNDARIES SHOWN ON THIS PLAN.

Distances shown on this plan are Ground Distances and can be converted to Grid Distances by Multiplying the Combined Scale Factor of 0.999737.

### SURVEYOR'S CERTIFICATE

certify that:

- This survey and plan are correct and in accordance with the Surveys Act, the Surveyors Act, and the Regulations made under them.
- 2: The survey was completed on the 29th day of January, 2024.

ASSOCIATION OF ONTARIO LAND SURVEYORS PLAN SUBMISSION FORM V-69429




THIS PLAN IS NOT VALID UNLESS IT IS AN EMBOSSED ORIGINAL COPY ISSUED BY THE SURVEYOR. In accordance with Regulation 1026, Section 29(3) May 16, 2024



Party Chief: Drawn By: Checked By: 23-134



J. H. Gelbloom Surveying Limited Ontario Land Surveyor 476 Morden Road, Unit 102, Oakville, Ont., L6K 3W4 office@jhgsurveying.ca Phone:(905) 338-8210

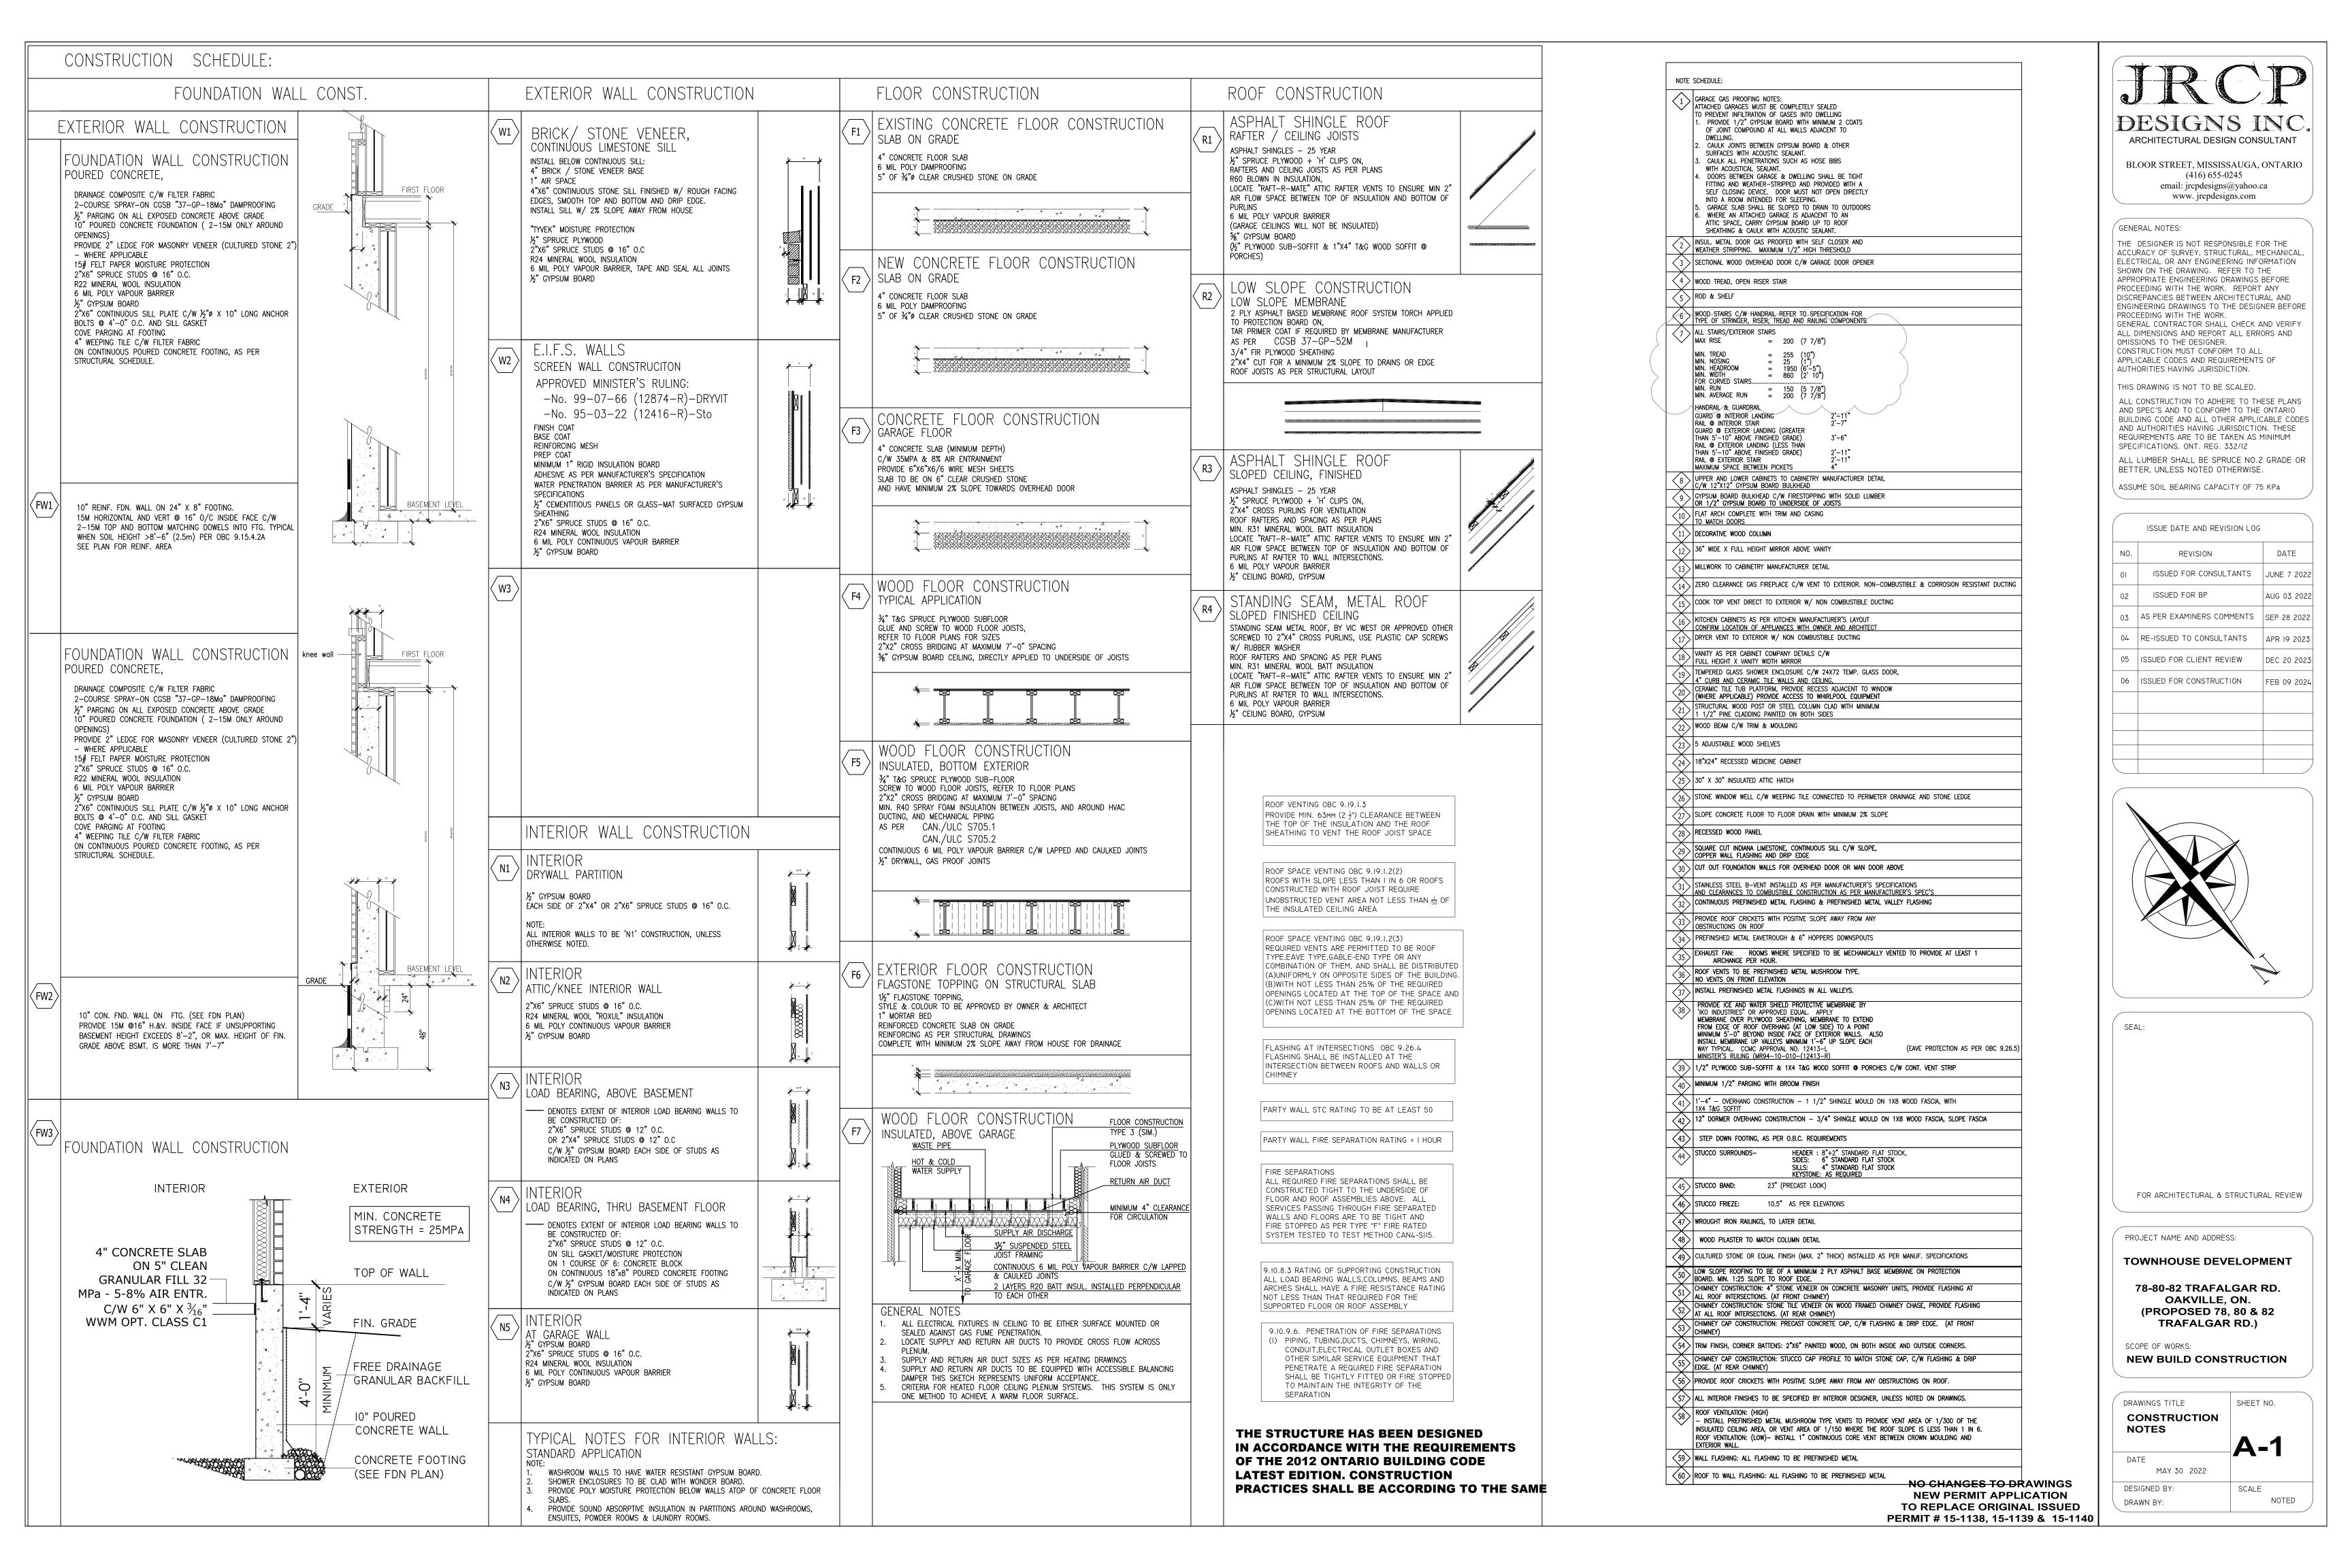

2. CONTRACTOR IS TO NOTIFY ENGINEER OF COMMENCEMENT OF CONSTRUCTION.

3. CONTRACTOR IS TO NOTIFY ENGINEER 48 HOURS PRIOR TO FIRST FOUNDATION WALL POUR FOR REBAR

4. CONTRACTOR IS TO CONTACT ENGINEER FOR FINAL FRAMING INSPECTION.

5. CONTRACTOR IS TO PROVIDE ADEQUATE SHORING DURING CONSTRUCTION FOR THE SAFE INSTALLATION OF ALL CONSTRUCTION MATERIALS.

6. ALL TIMBER TO BE SPF #2 OR BETTER. ROOF TRUSS LATERAL DEFLECTION NOT TO EXCEED 1/4".

7. ALL ENGINEERED LUMBER TO BE GRADE 2.0e PSL OR LVL (EXCEPT WHERE NOTED).

8. ALL STRUCTURAL STEEL BEAMS AND COLUMNS SHALL CONFORM TO CSA G40.21-92.

9. ALL REINFORCING STEEL TO BE GRADE 400 MPa AND SHALL CONFORM TO CSA-G30.18-M92.

10. CONCRETE FOR FOOTINGS AND FOUNDATION WALLS: F'c = 25 MPA AT 28 DAYS, SLUMP 75 MM (3"), AIR CONTENT IN CONCRETE EXPOSED TO WEATHER 3%-6%.

11. ALL TIMBER EXPOSED TO THE EXTERIOR IS TO BE PRESSURE TREATED, INCLUDING STRUCTURAL TIMBER WITHIN EXTERIOR COLUMNS.

12. ALL STEEL EXPOSED TO THE EXTERIOR IS TO BE HOT DIPPED GALVANIZED.

13. ARCHITECT TO CONFIRM FLUSH AND DROPPED BEAMS (ALL BEAMS FLUSH UNLESS OTHERWISE NOTED). PROVIDE SADDLE FOR WOOD BEAMS WHICH BEAR ONTO OR INTO STEEL COLUMNS W/ 2-1/2" THROUGH

14. PROVIDE AND CONNECT A 2"x6" WOOD TOP PLATE TO THE TOP OF ALL STEEL BEAMS AND FASTEN WITH ½" DIAMETER THROUGH BOLT @ 2'-0" o/c STAGGERED IN PRE-DRILLED HOLES, IF USING SIDE MOUNTED HANGERS, FILL WEB OF STEEL BEAM WITH 2"x MEMBERS TO CLEAR FLANGE AND FASTEN TO BEAM WEB USING 1/2" THROUGH BOLT @ 2'-0" o/c.

15. ENGINEERED JOIST AND BEAM SHOP DRAWINGS (STAMPED BY P. ENG.) WHICH INCLUDE SPECS FOR ALL REQUIRED JOIST AND BEAM HANGERS ARE TO BE PROVIDED TO ENGINEER FOR REVIEW.

16. DESIGN LOADS: GROUND AND SECOND FLOOR LIVE LOADS = 40 PSF. ROOF SNOW LOAD = 25 PSF. GROUND AND SECOND FLOOR DEAD LOADS = 15 PSF. ROOF DEAD LOAD = 15 PSF.TERRACE/BALCONY LIVE LOAD = 40 PSF. CEILING LIVE LOAD= 7 PSF. TERRACE/BALCONY DEAD LOAD = 12 PSF. CEILING DEAD LOAD= 5 PSF. DEAD LOAD FOR ALL TILED AREAS = 20 psf

17. ROOF SHEATHING TO BE 1/2" PLYWOOD MIN. W/ H-CLIPS.

18. FLOOR SHEATHING TO BE 34" PLYWOOD MIN. T&G, GLUED AND SCREWED.

19. PROVIDE DOUBLE JOISTS (D.J.) BELOW WALLS WHICH ARE NON-BEARING AND PARALLEL TO SAID JOISTS.

20. PROVIDE SOLID BLOCKING BETWEEN JOISTS BELOW ALL BEARING WALLS WHICH ARE PERPENDICULAR TO SAID JOISTS.

21. FLOOR JOIST SCHEDULE

TJI JOISTS HAVE BEEN DESIGNED FOR A DIRECT APPLIED GYPSUM CEILING TO THEIR BOTTOM CHORDS PLUS SOLID BLOCKING OR BRIDGING AT 8'-0" O.C. MAX.

FJ-2= 9 1/2" TJI-S31 @ 16" o.c FJ-3= 9 1/2" TJI-S33 @ 12" o.c FJ-4= EXISTING 2"x8" @ 16"+ NEW 9 1/2" TJI-S31 @ 16" o.c FJ-5= 2"x8" @ 16"

22. <u>TIMBER BEAM SCHEDULE</u>

2B8=2-2x82B11=2 PLY 1\frac{3}{4}"x11\hstar\* 2.0e PSL 3B8 = 3 - 2x8 $2B9=2 PLY 1\frac{3}{4}"x9\frac{1}{2}" 2.0e PSL$ 3B11=3 PLY 14"x111%" 2.0e PSL  $3B9=3 PLY 1\frac{3}{4}"x9\frac{1}{2}" 2.0e PSL$ 4B11=4 PLY 13"x11%" 2.0e PSL 4B9 = 4 PLY 14"x9½" 2.0e PSL

23. <u>TIMBER LINTEL SCHEDULE</u>

3L10=3-2x10

2L8=2-2x8 $2L11=2 PLY 1\frac{3}{4}$ "x11\%" 2.0e PSL 3L8=3-2x82L9=2 PLY 14"x9½" 2.0e PSL 3L11=3 PLY 14"x111%" 2.0e PSL 3L9=3 PLY  $1\frac{3}{4}$ "x9½" 2.0e PSL 2L10=2-2x10 3L12=3-2x12

24. TYPICAL BEARING WALL IS 2"X6" @ 12" O.C.

25. POST SCHEDULE: P2: 2-2"X6" P3: 3-2"X6" P4: 4-2"X6"

P5: 5-2"X6" 26. COLUMN SCHEDULE:

C1: HSS 3.5" x 0.25" PLUS 6"x3/8"x8" CAP PLATE W/ 4- 3/4" bolts and 6"x3/8"x8" BASE PLATE W/ 2- ½" A.Bolts.

C2: HSS 4"x4"x0.313" COLUMN PLUS 8"X56"X8" CAP PLATE

W/  $4-\frac{1}{2}$ "ø BOLTS AND 10" $x\frac{3}{8}$ "x10" BASE PLATE W/ 4-5/8"ø A.BOLTS.

C3: HSS 5"x5"x0.25 COLUMN PLUS 8"X56"X8" CAP PLATE 12"X\2"X12" BASE PLATE W/ 4-5/8"\00e9 A.BOLTS.

WHERE STEEL BEAMS ARE NOTED AS CONTINUOUS OVER INTERMEDIATE COLUMNS, PROVIDE A 5/16" THICK WEB STIFFENER PLATE ON BOTH SIDES OF THE BEAM WEB (DIRECTLY OVER THE COLUMNS).

27. 10" (OR 12" THICK - SEE PLAN AND SECTIONS) BASEMENT CONCRETE WALLS NOT EXCEEDING 8'-2" (2500) IN UNSUPPORTED HEIGHT WITH A MAXIMUM HEIGHT OF FINISH GRADE ABOVE THE BASEMENT FLOOR NOT EXCEEDING 7'-7" (2300) CAN BE CONSTRUCTED OF UNREINFROCED CONCRETE. POURED CONCRETE FOUNDATION WALLS, 25 MPA AT 28 DAYS, WITH A MAXIMUM HEIGHT OF 10'-6" (3200MM) IN UNSUPPORTED HEIGHT WILL REQUIRE THE FOLLOWING REINFORCING (DOWELS FROM FOOTINGS TO WALLS SHALL MATCH THE SIZE & SPACING OF WALL REINFORCING):

15M @ 16" O.C. V.I.F. (V.I.F. = VERTICAL INSIDE FACE) 15M @ 16" O.C. H.I.F. (H.I.F. = HORIZONTAL INSIDE FACE)

28. PROVIDE 2-15M VERT. FULL HEIGHT ON EITHER SIDE OF BASEMENT WINDOW 4'-0" IN WIDTH OR

29. TYPICAL EXTERIOR STRIP FOOTING TO BE 24"x8" DP. W/ 2-15M CONTINUOUS U/N OTHERWISE

30. TYPICAL INTERIOR STRIP FOOTING TO BE 20"X8" DP. W/ 2-15M CONTINUOUS U/N OTHERWISE <u>FT-1:</u> 48"x48"x 16" THICK <u>FT-2:</u> 36"x36"x 15" THICK

31. TYP. FIREPLACE FOOTING: 12" DEEP WITH 12" PROJECTION AROUND BASE REINFORCED WITH 15M @ 12" O.C. TOP AND BOTTOM EACH WAY.

32. PROVIDE 4'-0" MINIMUM FROST COVER FOR ALL EXTERIOR FOOTINGS.

33. STRUCTURAL SLAB 'S1' DENOTES 6" THICK 32 MPa, 6%~8% AIR ENTRAINED CONCRETE REINFORCED WITH 10M@8" BOTTOM EACH WAY + 10M@18" TOP DOWELS ALL AROUND.

STRUCTURAL SLAB S2 DENOTES 8" THICK 32 MPa, 4%~8% AIR ENTRAINED CONCRETE REINFORCED WITH 20M@12" BOTTOM LOWER LAYER (SHORT DIRECTION) AND 15M@12" BOTTOM UPPER LAYER (LONG DIRECTION) + 10M@18" TOP DOWELS ALL AROUND.

34. FOR ALL STEEL BEAMS BEARING ON CONCRETE WALL, PROVIDE A 6"x3/8"x10" WALL PLATE W/ 2-1/2"

35. LOOSE LINTELS:

<u>FT-3:</u> 66"x66"x 30" THICK


<u>FT-4:</u> 72"x72"x 33" THICK

L1: L3.5"X3.5"X1/4" UP TO 3'-11" (4" BEARING). L2: L4"X3.5"X5/16" UP TO 5'-11" (6" BEARING). L3: L5"X3.5"X5/16" UP TO 7'-10" (8" BEARING).

L4: L6"X4"X3/8" UP TO 9'-10" (8" BEARING).

ENGINEER AT THE UNDERSIDE OF FOOTINGS PRIOR TO POURING CONCRETE.

**NO CHANGES TO DRAWINGS** NEW PERMIT APPLICATION TO REPLACE ORIGINAL ISSUED PERMIT # 15-1138, 15-1139 & 15-1140

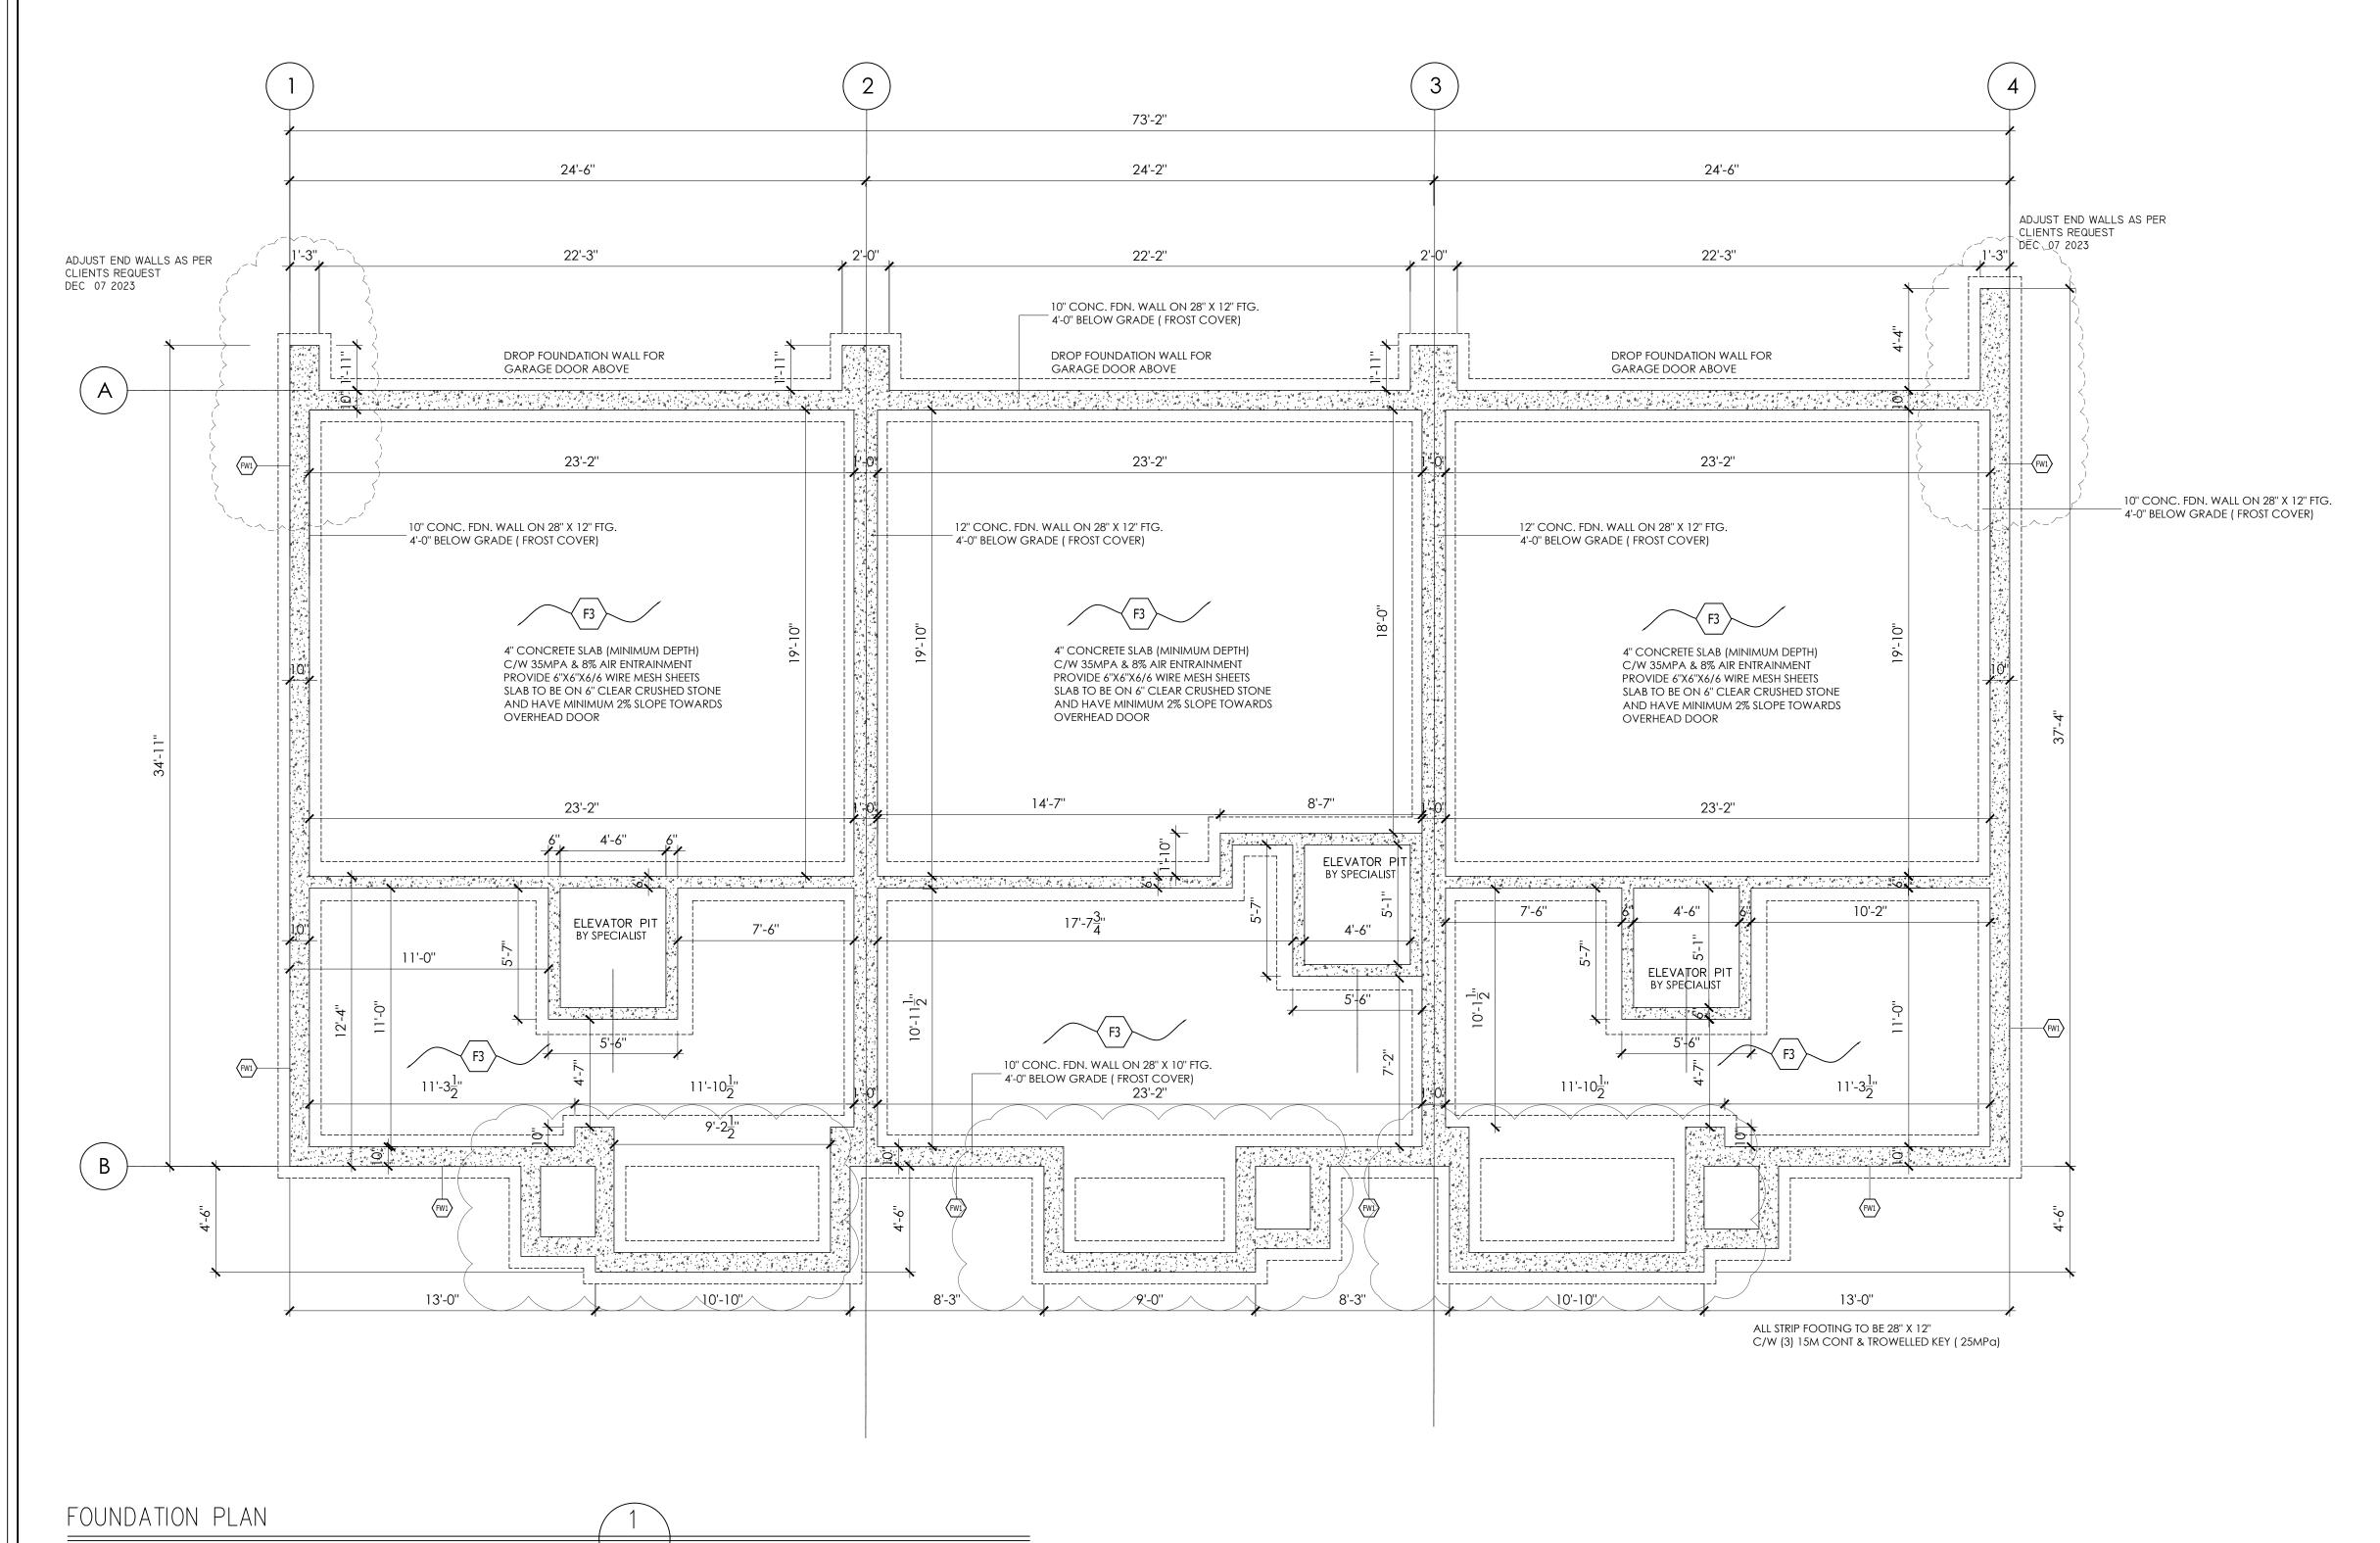

DAMPPROOFING INTERIOR WALLS O.B.C. 9.13.2.6 WHERE AN INTERIOR FINISH IS APPLIED TO FOUNDATION WALLS THE INTERIOR SURFACE OF THE WALL SHALL BE DAMPPROOFED BELOW GROUND LEVEL

1/4"=-1'0"

WOOD FRAME CONSTRUCTION

OR TYPE S ROLL ROOFING

UNTREATED WOOD FRAMING MEMBERS ON

NATURAL VENTILATION O.B.C. 9.13.2.6

CONCRETE SHALL BE SEPARATED FROM THE

OPENING FOR NATURAL VENTILATION OF COLD

AND PROTECTED FROM WEATHER AND INSECTS

CELLAR SHALL BE 0.2 PERCENT OF FLOOR AREA

CONCRETE BY MIN. 0.05MM (6MIL) POLYETHYLENE

O.B.C. 9.23.2.3

9.9.10.1 EGRESS WINDOWS OR DOORS FOR BEDROOMS (I) EXCEPT WHERE A DOOR ON THE SAME FLOOR LEVEL AS THE BEDROOM PROVIDES DIRECT ACCESS TO THE EXTERIOR, EVERY FLOOR LEVEL CONTAINING A BEDROOM IN A SUITE SHALL BE PROVIDED WITH A LEAST ONE OUTSIDE WINDOW THAT A)IS OPENABLE FROM THE INSIDE WITHOUT THE USE OF

DESCRIBED IN SENTENCE (I) SHALL HAVE A MAXIMUM

SILL HEIGHT OF 1000MM (3FT 3IN) ABOVE THE FLOOR.

(3)WHEN SLIDING WINDOWS ARE USED, THE MINIMUM

THE OPENABLE PORTION OF THE WINDOW

DIMENSION DESCRIBED IN SENTENCE (I) SHALL APPLY TO

B)PROVIDES AN INDIVIDUAL, UNOBSTRUCTED OPEN PORTION HAVING A MINIMUM AREA OF 0.35 M2 (3.8 FT) WITH NO DIMENSION LESS THAN 380MM (I5 IN) AND C)MAINTAINS THE REQUIRED OPENING DESCRIBED IN CLAUSE (B) WITHOUT THE NEED FOR ADDITIONAL (2)EXCEPT FOR BASEMENT AREAS, THE WINDOW

INSTALLED TO RECEIVE DRAIN WATER FROM ALL SHOWERS OR AT LEAST TWO SHOWERS WHERE THERE ARE TWO OR MORE SHOWERS IN A DWELLING IN AN UPRIGHT POSITION THAT DOES NOT DIVERGE MORE THAN 5 DEGREES FROM THE VERTICAL IN A POSITION SUCH THAT THE COLD WATER INLET CONNECTION IS AT THE BOTTOM OF THE UNIT. DOWNSTREAM OF A WATER SOFTENER WHERE A WATER SOFTENER IS INSTALLED AND IN A CONDITIONED SPACE OR ON THE WARM SIDE OF THE DEWPOINT OF THE WALL ASSEMBLY

SB-I2, 3.I.I.I2 DRAIN WATER HEAT RECOVERY

A DRAIN WATER HEAT RECOVERY UNIT SHALL BE

STAIRWAY LIGHTING O.B.C. 9.34.2.3.(2) 3 WAY WALL SWITCHES LOCATED AT THE HEAD AND FOOT OF EVERY STAIRWAY SHALL BE PROVIDED TO CONTROL AT LEAST ONE LIGHTING OUTLET FOR STAIRWAYS WITH MORE THAN 4 RISERS

SHALL BE PROTECTED WITH A GUARD OR GRATE O.B.C. 9.14.6.3 WINDOW WELLS SHALL BE DRAINED | TO FOOTING LEVEL OR OTHER SUITABLE LOCATION

9.7.1.4 WINDOW OPENING INTO A WINDOW WELL I)WHERE A WINDOW REQUIRED IN ARTICLE 9.7.1.3 OPENS INTO A WINDOW WELL, A CLEARANCE OF NOT LESS THAN 550MM SHALL BE PROVIDED IN FRONT OF THE WINDOW. (2)WHERE THE SASH OF A WINDOW REFERRED

TO IN SENTENCE (I) SWINGS TOWARDS THE

WINDOW-WELL. THE OPERATION OF THE SASH

THAT WOULD RESTRICT ESCAPE IN AN EMERGENCY

ALL WINDOW MECHANICAL SYSTEM EFFIENCIES AND THERMAL INSULATION LEVELS ARE TO COMPLY WITH THE APPROVED EEDS FORM.

FLOOR AND ROOF FRAMING TO BE CO-ORDINATED

ENGINEERING PLANS AND SPECIFICATIONS FROM

BETWEEN ARCHITECTURAL PLANS AND

LUMBER COMPANY

SEE SEPARATE HVAC DRAWINGS FOR ALL HVAC APPROVAL INFORAMTION, REVIEW NOTES AND RELATED |SHALL NOT REDUCE THE CLEARANCE IN A MANNER | COMMENTS

IN ACCORDANCE WITH THE REQUIREMENTS OF THE 2012 ONTARIO BUILDING CODE LATEST EDITION. CONSTRUCTION PRACTICES SHALL BE ACCORDING TO THE SAME

THE STRUCTURE HAS BEEN DESIGNED



BLOOR STREET, MISSISSAUGA, ONTARIO (416) 655-0245 email: jrcpdesigns@yahoo.ca

www. jrcpdesigns.com

GENERAL NOTES:

THE DESIGNER IS NOT RESPONSIBLE FOR THE ACCURACY OF SURVEY, STRUCTURAL, MECHANICAL, ELECTRICAL OR ANY ENGINEERING INFORMATION SHOWN ON THE DRAWING. REFER TO THE APPROPRIATE ENGINEERING DRAWINGS BEFORE PROCEEDING WITH THE WORK. REPORT ANY DISCREPANCIES BETWEEN ARCHITECTURAL AND ENGINEERING DRAWINGS TO THE DESIGNER BEFORE PROCEEDING WITH THE WORK. GENERAL CONTRACTOR SHALL CHECK AND VERIFY ALL DIMENSIONS AND REPORT ALL ERRORS AND OMISSIONS TO THE DESIGNER. CONSTRUCTION MUST CONFORM TO ALL

THIS DRAWING IS NOT TO BE SCALED.

AUTHORITIES HAVING JURISDICTION.


APPLICABLE CODES AND REQUIREMENTS OF

ALL CONSTRUCTION TO ADHERE TO THESE PLANS AND SPEC'S AND TO CONFORM TO THE ONTARIO BUILDING CODE AND ALL OTHER APPLICABLE CODES AND AUTHORITIES HAVING JURISDICTION. THESE REQUIREMENTS ARE TO BE TAKEN AS MINIMUM SPECIFICATIONS. ONT. REG. 332/12

ALL LUMBER SHALL BE SPRUCE NO.2 GRADE OR BETTER, UNLESS NOTED OTHERWISE.

ASSUME SOIL BEARING CAPACITY OF 75 KPA

NO.	REVISION	DATE
01	ISSUED FOR CONSULTANTS	JUNE 7
02	ISSUED FOR BP	AUG 03
03	AS PER EXAMINERS COMMENTS	SEP 28 2
04	RE-ISSUED TO CONSULTANTS	APR 19 2
05	ADJUST END WALLS AS PER CLIENTS REQUEST SEE BUBBLES	DEC 07 2
06	ADDED COLD ROOM	DEC 18
07	ISSUED FOR CLIENT REVIEW	DEC 20
08	ISSUED FOR STL. SUPPLIER	JAN 29
09	ISSUED FOR CONSTRUCTION	FEB 09

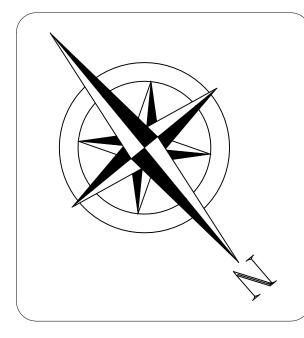

SEAL: FOR ARCHITECTURAL & STRUCTURAL REVIEW

**TOWNHOUSE DEVELOPMENT 78-80-82 TRAFALGAR RD.** 


PROJECT NAME AND ADDRESS:

OAKVILLE, ON. (PROPOSED 78, 80 & 82 TRAFALGAR RD.)

SCOPE OF WORKS:

**NEW BUILD CONSTRUCTION** 

DRAWINGS TITLE SHEET NO. **FOUNDATION** PLAN MAY 30 2022 DESIGNED BY: SCALE NOTED DRAWN BY:

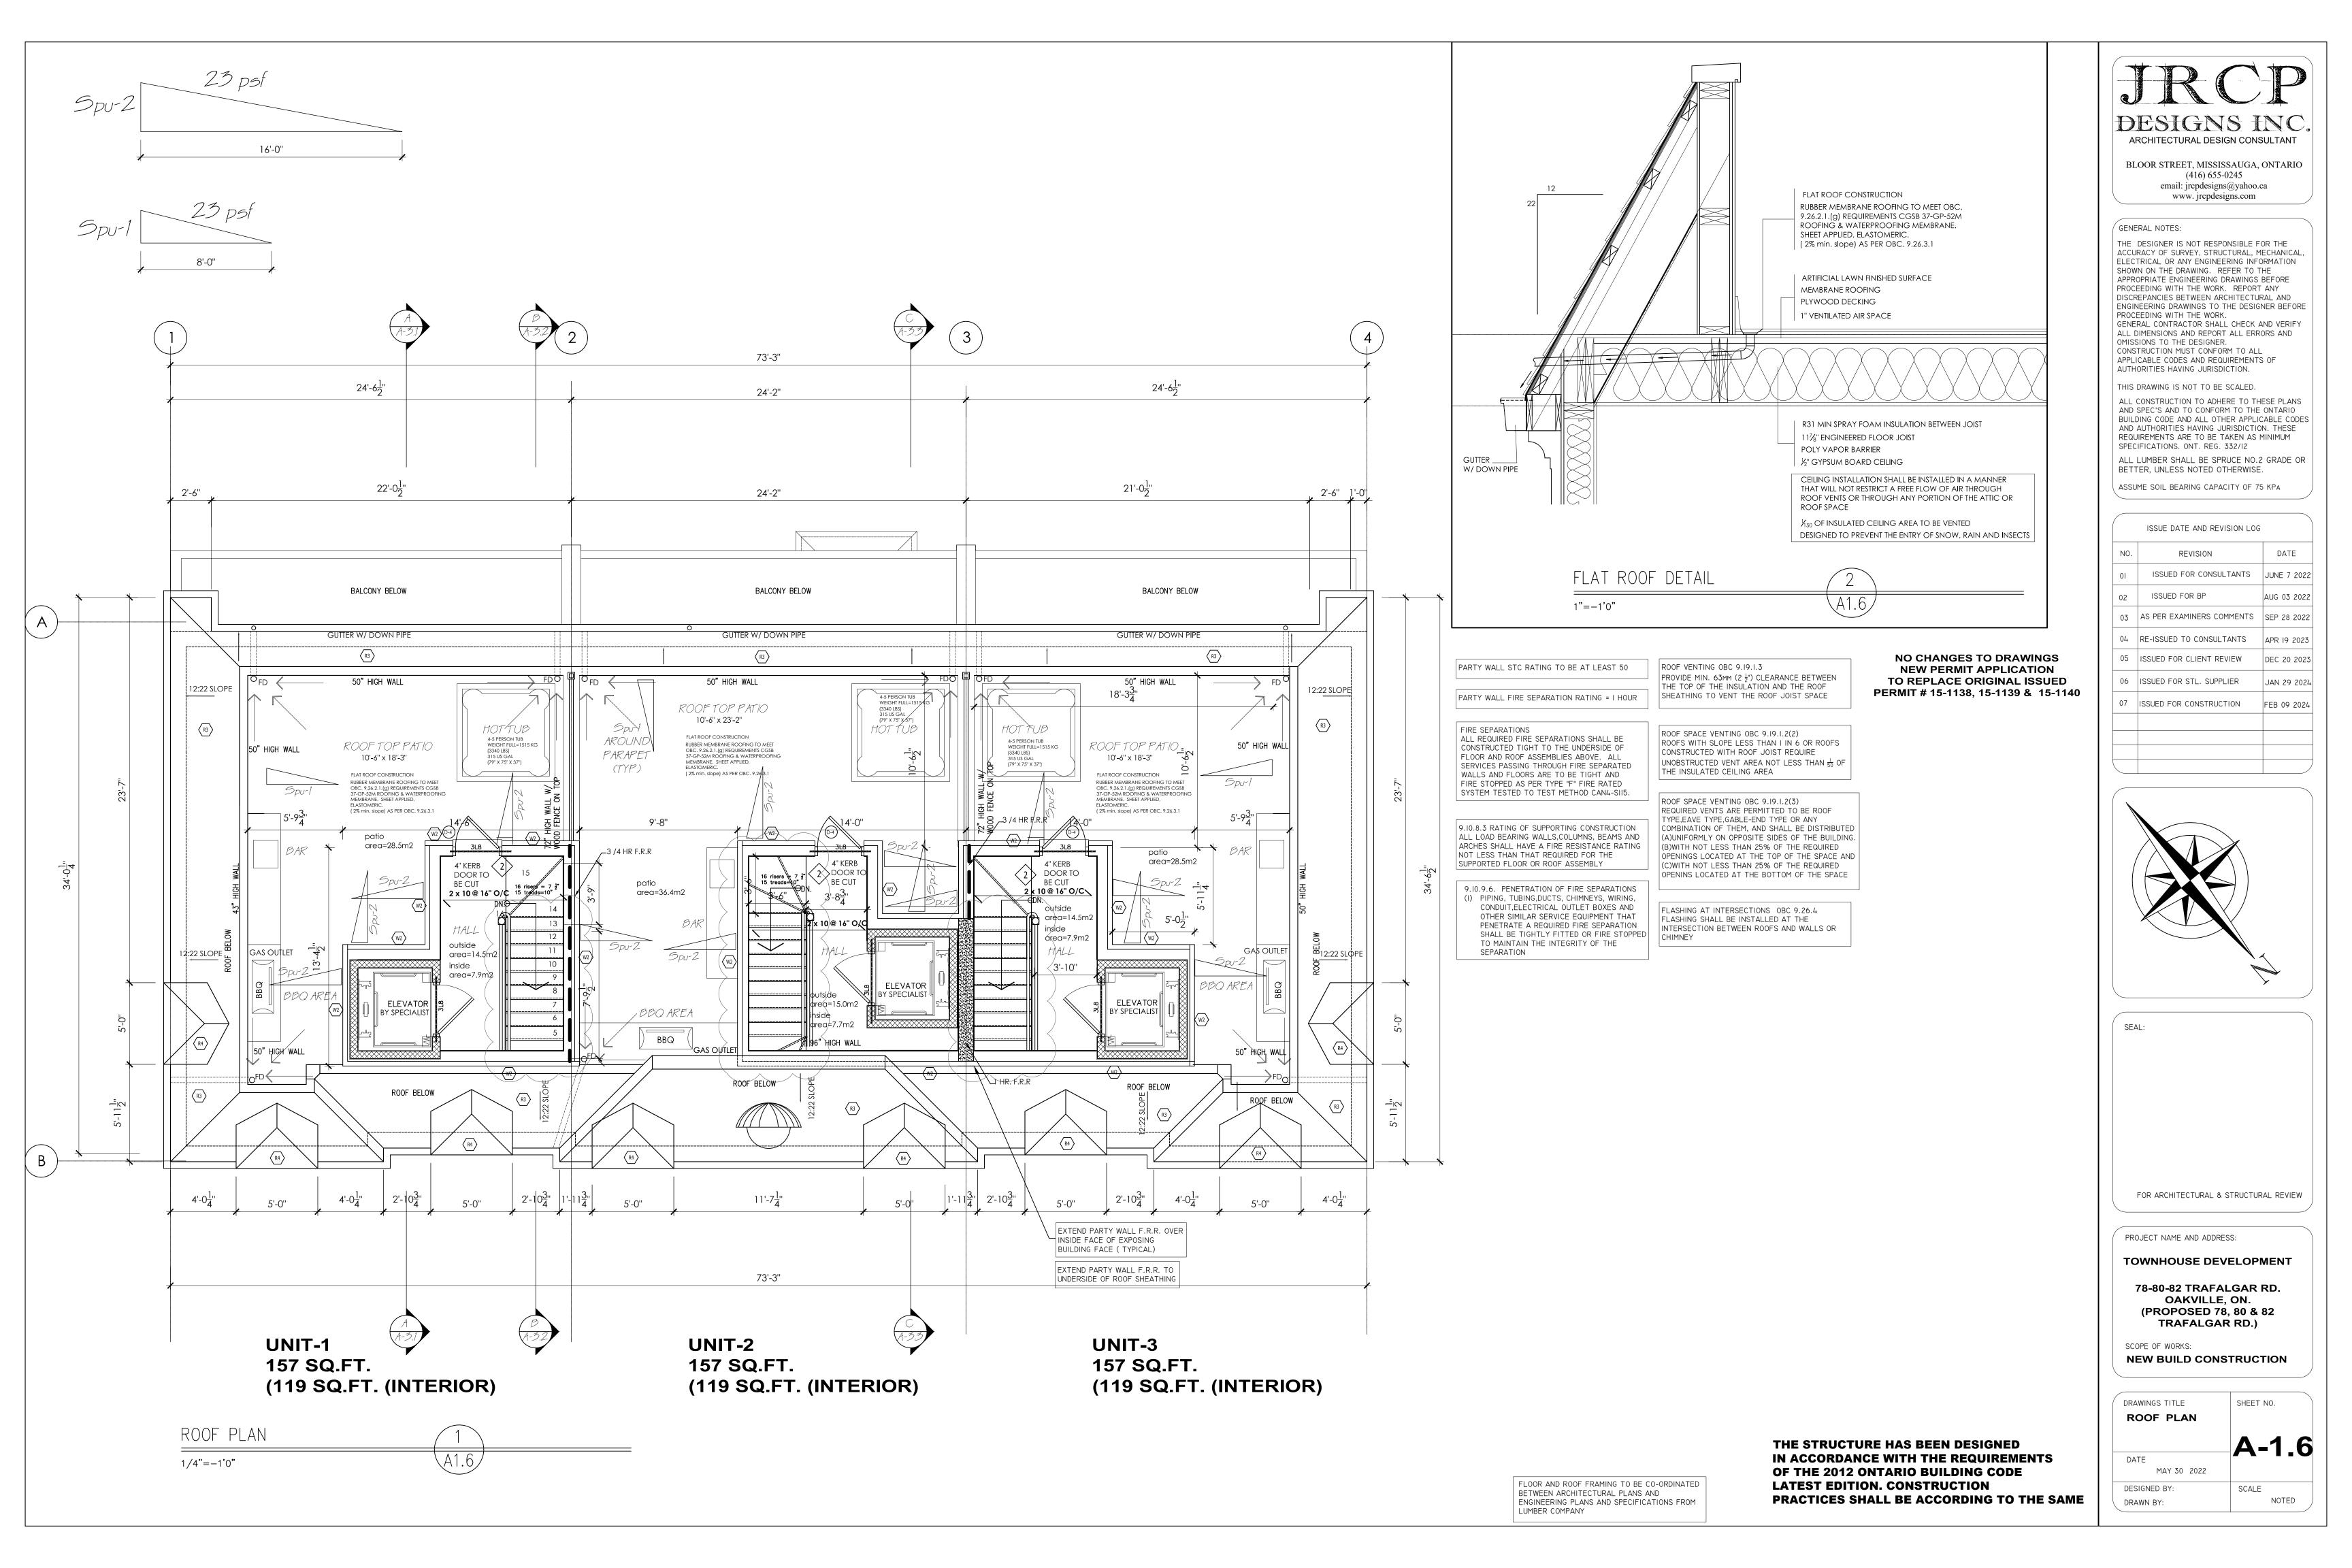



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ARCHITECTURAL DESIGN CONSULTANT

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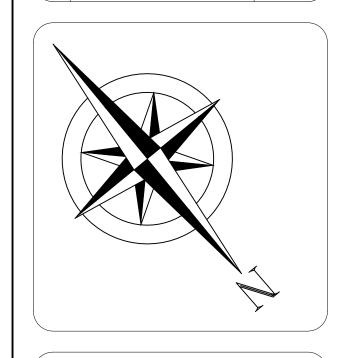
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ISSUE DATE AND REVISION LOG DATE REVISION ISSUED FOR CONSULTANTS JUNE 7 2022 ISSUED FOR BP AUG 03 2022 03 AS PER EXAMINERS COMMENTS SEP 28 2022 04 RE-ISSUED TO CONSULTANTS APR 19 2023 05 ISSUED FOR CLIENT REVIEW DEC 20 2023 06 ISSUED FOR STL. SUPPLIER JAN 29 2024 07 ISSUED FOR CONSTRUCTION FEB 09 2024



SEAL:

FOR ARCHITECTURAL & STRUCTURAL REVIEW

PROJECT NAME AND ADDRESS:


TOWNHOUSE DEVELOPMENT

78-80-82 TRAFALGAR RD. OAKVILLE, ON. (PROPOSED 78, 80 & 82 TRAFALGAR RD.)

SCOPE OF WORKS:

NEW BUILD CONSTRUCTION

DRAWINGS TITLE SHEET NO. **ROOF PLAN** A-1.7 DATE MAY 30 2022 DESIGNED BY: SCALE NOTED DRAWN BY:

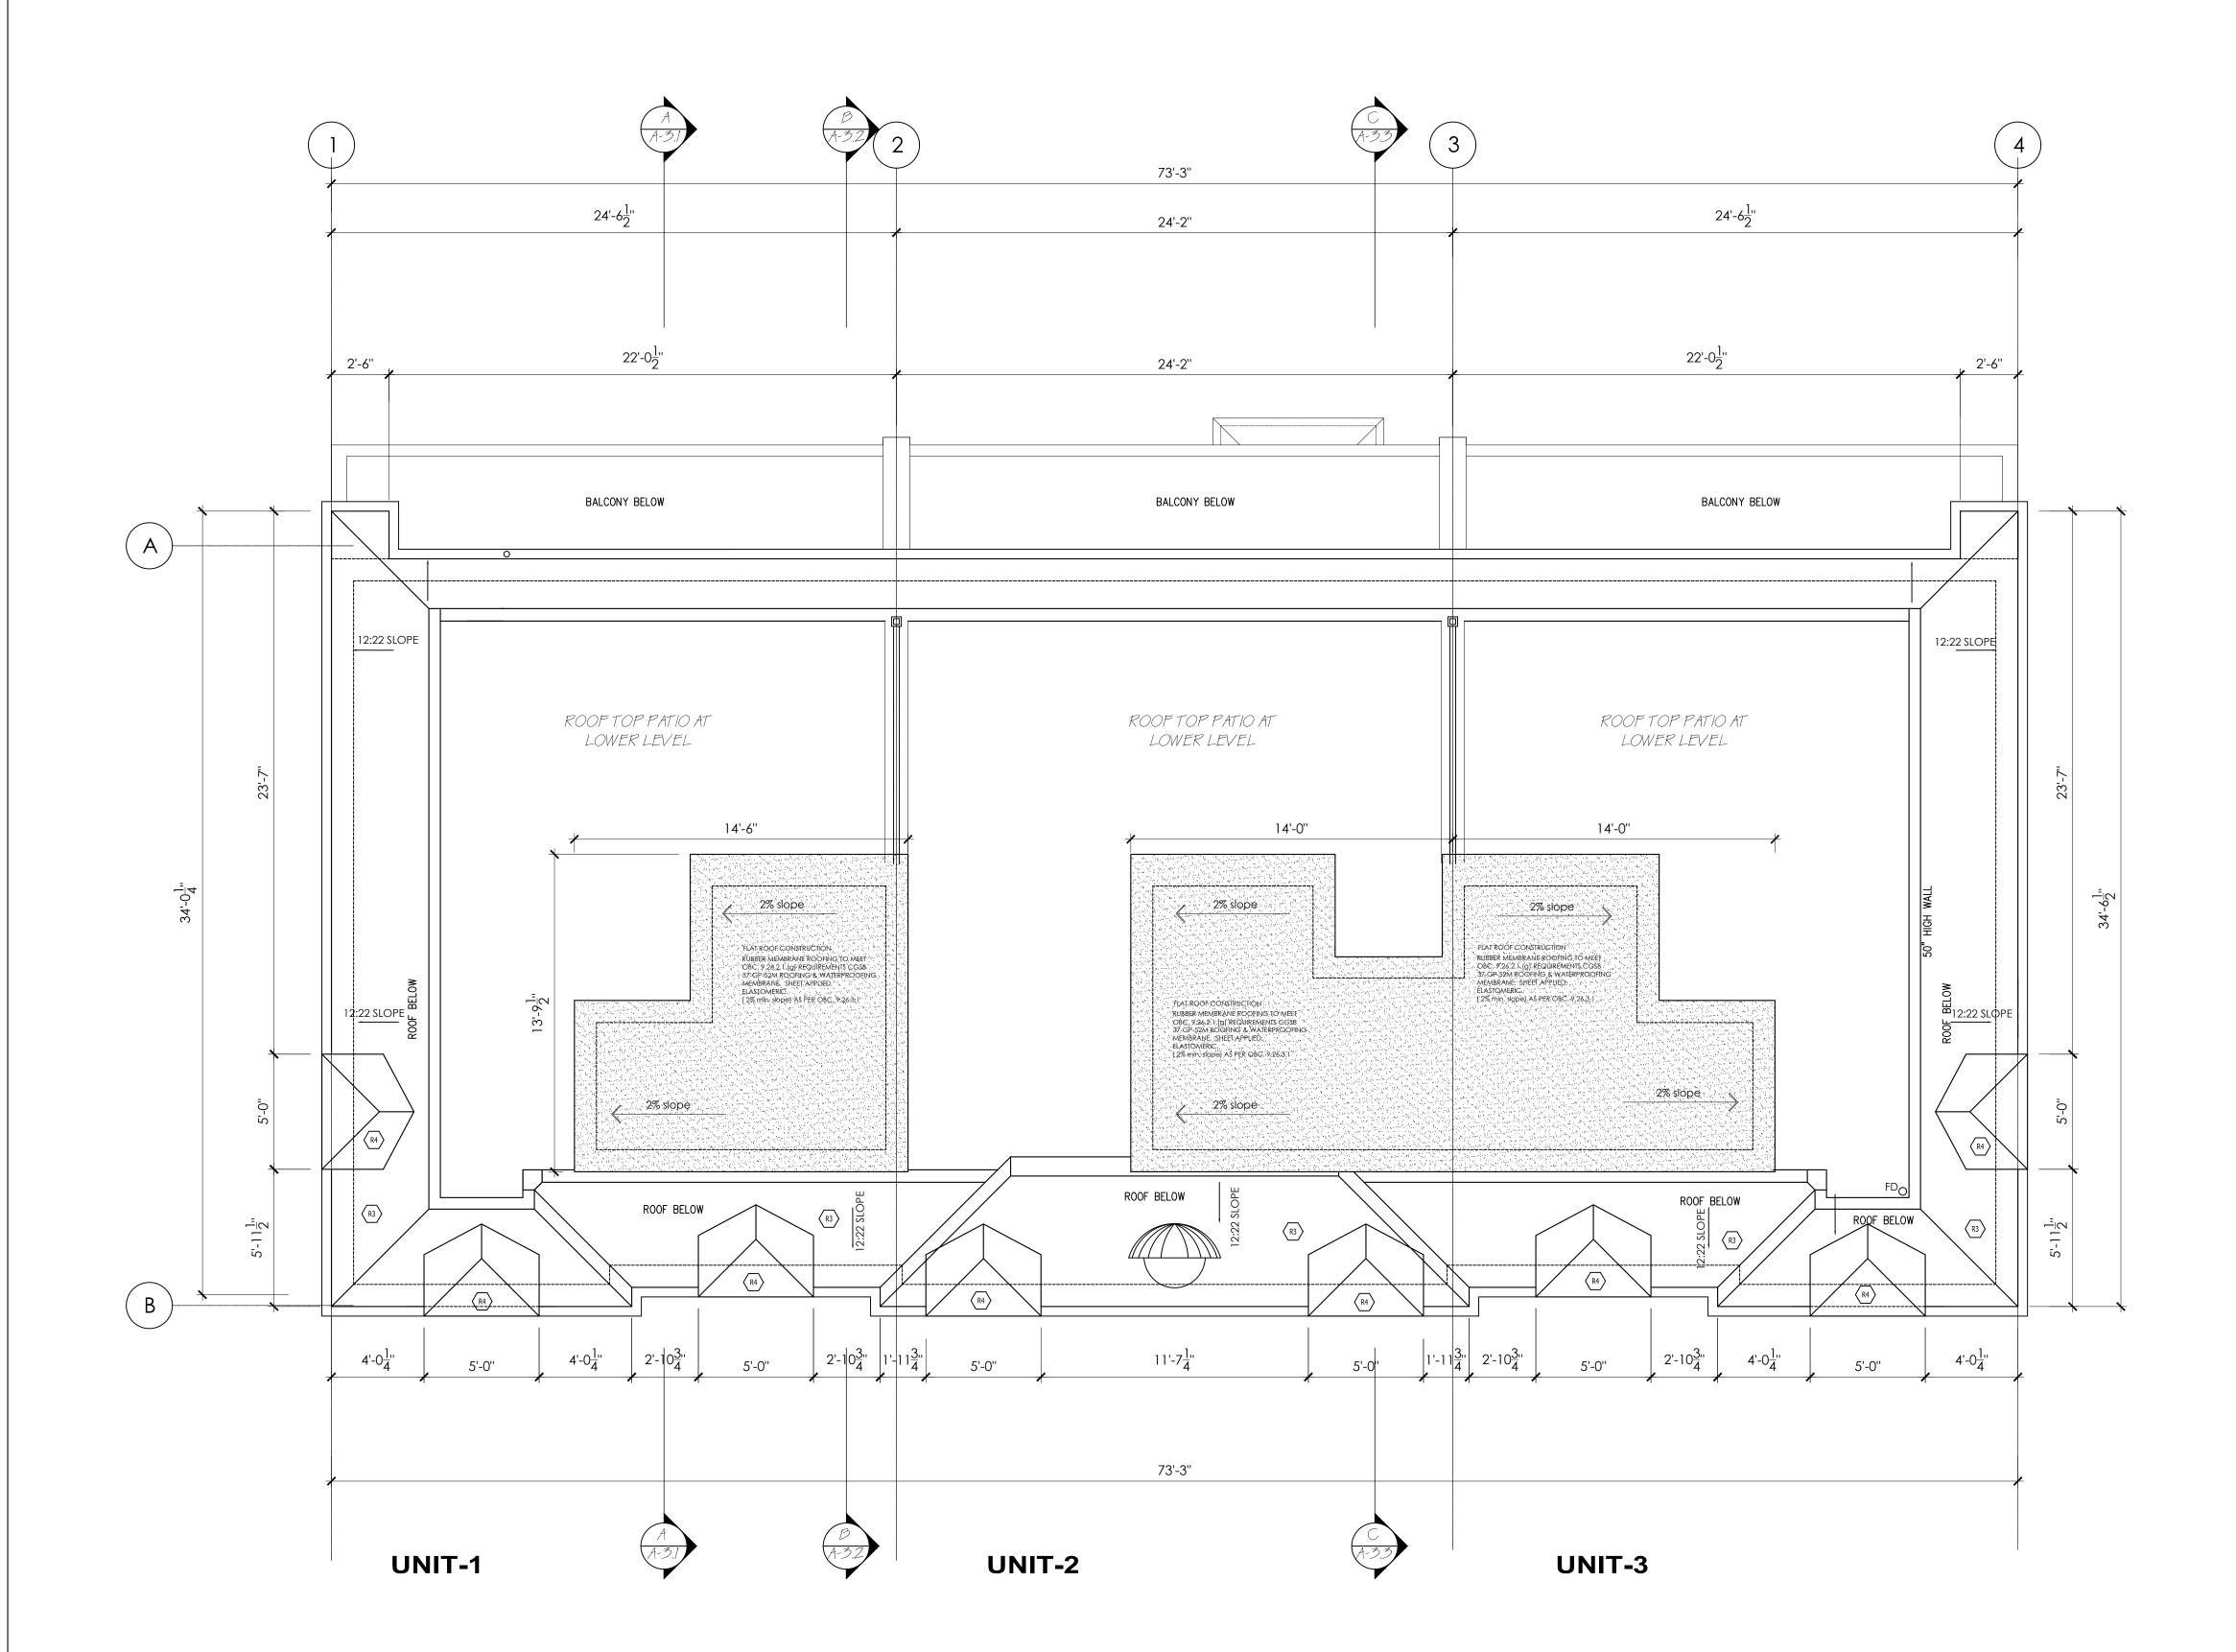

ROOF PLAN ( AT TOP OF ELEVATOR SHAFT)

1/4"=-1'0"

BETWEEN ARCHITECTURAL PLANS AND ENGINEERING PLANS AND SPECIFICATIONS FROM LUMBER COMPANY

OF THE 2012 ONTARIO BUILDING CODE FLOOR AND ROOF FRAMING TO BE CO-ORDINATED LATEST EDITION. CONSTRUCTION PRACTICES SHALL BE ACCORDING TO THE SAME

THE STRUCTURE HAS BEEN DESIGNED

IN ACCORDANCE WITH THE REQUIREMENTS



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CONSTRUCTION MUST CONFORM TO ALL APPLICABLE CODES AND REQUIREMENTS OF AUTHORITIES HAVING JURISDICTION.


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ASSUME SOIL BEARING CAPACITY OF 75 KPA

NO.	REVISION	DATE
01	ISSUED FOR CONSULTANTS	JUNE 7 2022
02	ISSUED FOR BP	AUG 03 2022
03	AS PER EXAMINERS COMMENTS	SEP 28 2022
04	METER BANK LOCATION	JAN 31 2023
05	RE-ISSUED TO CONSULTANTS	APR 19 2023
06	ISSUED FOR CLIENT REVIEW	DEC 20 2023
07	ISSUED FOR STL. SUPPLIER	JAN 29 2024
08	ISSUED FOR CLIENT REVIEW REVISED ELEVATIONS	FEB 0I 2024
09	ISSUED FOR CONSTRUCTION	FEB 09 2024



FOR ARCHITECTURAL & STRUCTURAL REVIEW

PROJECT NAME AND ADDRESS:

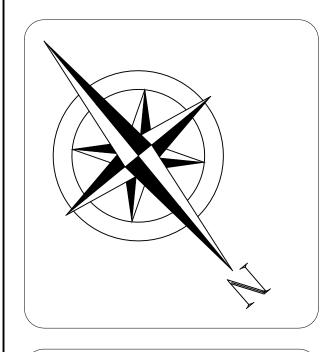TOWNHOUSE DEVELOPMENT

78-80-82 TRAFALGAR RD. OAKVILLE, ON. (PROPOSED 78, 80 & 82 TRAFALGAR RD.)

SCOPE OF WORKS:

THE STRUCTURE HAS BEEN DESIGNED

OF THE 2012 ONTARIO BUILDING CODE

LATEST EDITION. CONSTRUCTION

IN ACCORDANCE WITH THE REQUIREMENTS

PRACTICES SHALL BE ACCORDING TO THE SAME

SEAL:

NEW BUILD CONSTRUCTION

RAWINGS TITLE	SHEET NO.
EAST ELEVATION	A-2.1
DATE	
MAY 30 2022	
ESIGNED BY:	SCALE
RAWN BY:	NOTED



EAST ELEVATION (TRAFALGAR ROAD) 1

1/4"=-1'0"

A2.1



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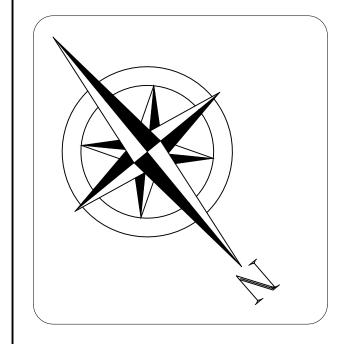
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NO.	REVISION	DATE
01	ISSUED FOR CONSULTANTS	JUNE 7 2022
02	ISSUED FOR BP	AUG 03 2022
03	AS PER EXAMINERS COMMENTS	SEP 28 2022
04	METER BANK LOCATION	JAN 31 2023
05	RE-ISSUED TO CONSULTANTS	APR 19 2023
06	ISSUED FOR CLIENT REVIEW	DEC 20 2023
07	ISSUED FOR STL. SUPPLIER	JAN 29 2024
08	ISSUED FOR CLIENT REVIEW REVISED ELEVATIONS	FEB 0I 2024
09	ISSUED FOR CONSTRUCTION	FEB 09 2024



SEAL:

FOR ARCHITECTURAL & STRUCTURAL REVIEW

PROJECT NAME AND ADDRESS:

# TOWNHOUSE DEVELOPMENT

78-80-82 TRAFALGAR RD. OAKVILLE, ON. (PROPOSED 78, 80 & 82 TRAFALGAR RD.)

SCOPE OF WORKS:

THE STRUCTURE HAS BEEN DESIGNED

OF THE 2012 ONTARIO BUILDING CODE


LATEST EDITION. CONSTRUCTION

IN ACCORDANCE WITH THE REQUIREMENTS

PRACTICES SHALL BE ACCORDING TO THE SAME

NEW BUILD CONSTRUCTION

DRAWINGS TITLE	SHEET NO.
NORTH ELEVATION	A-2.2
DATE	
MAY 30 2022	
DESIGNED BY:	SCALE
DRAWN BY:	NOTED

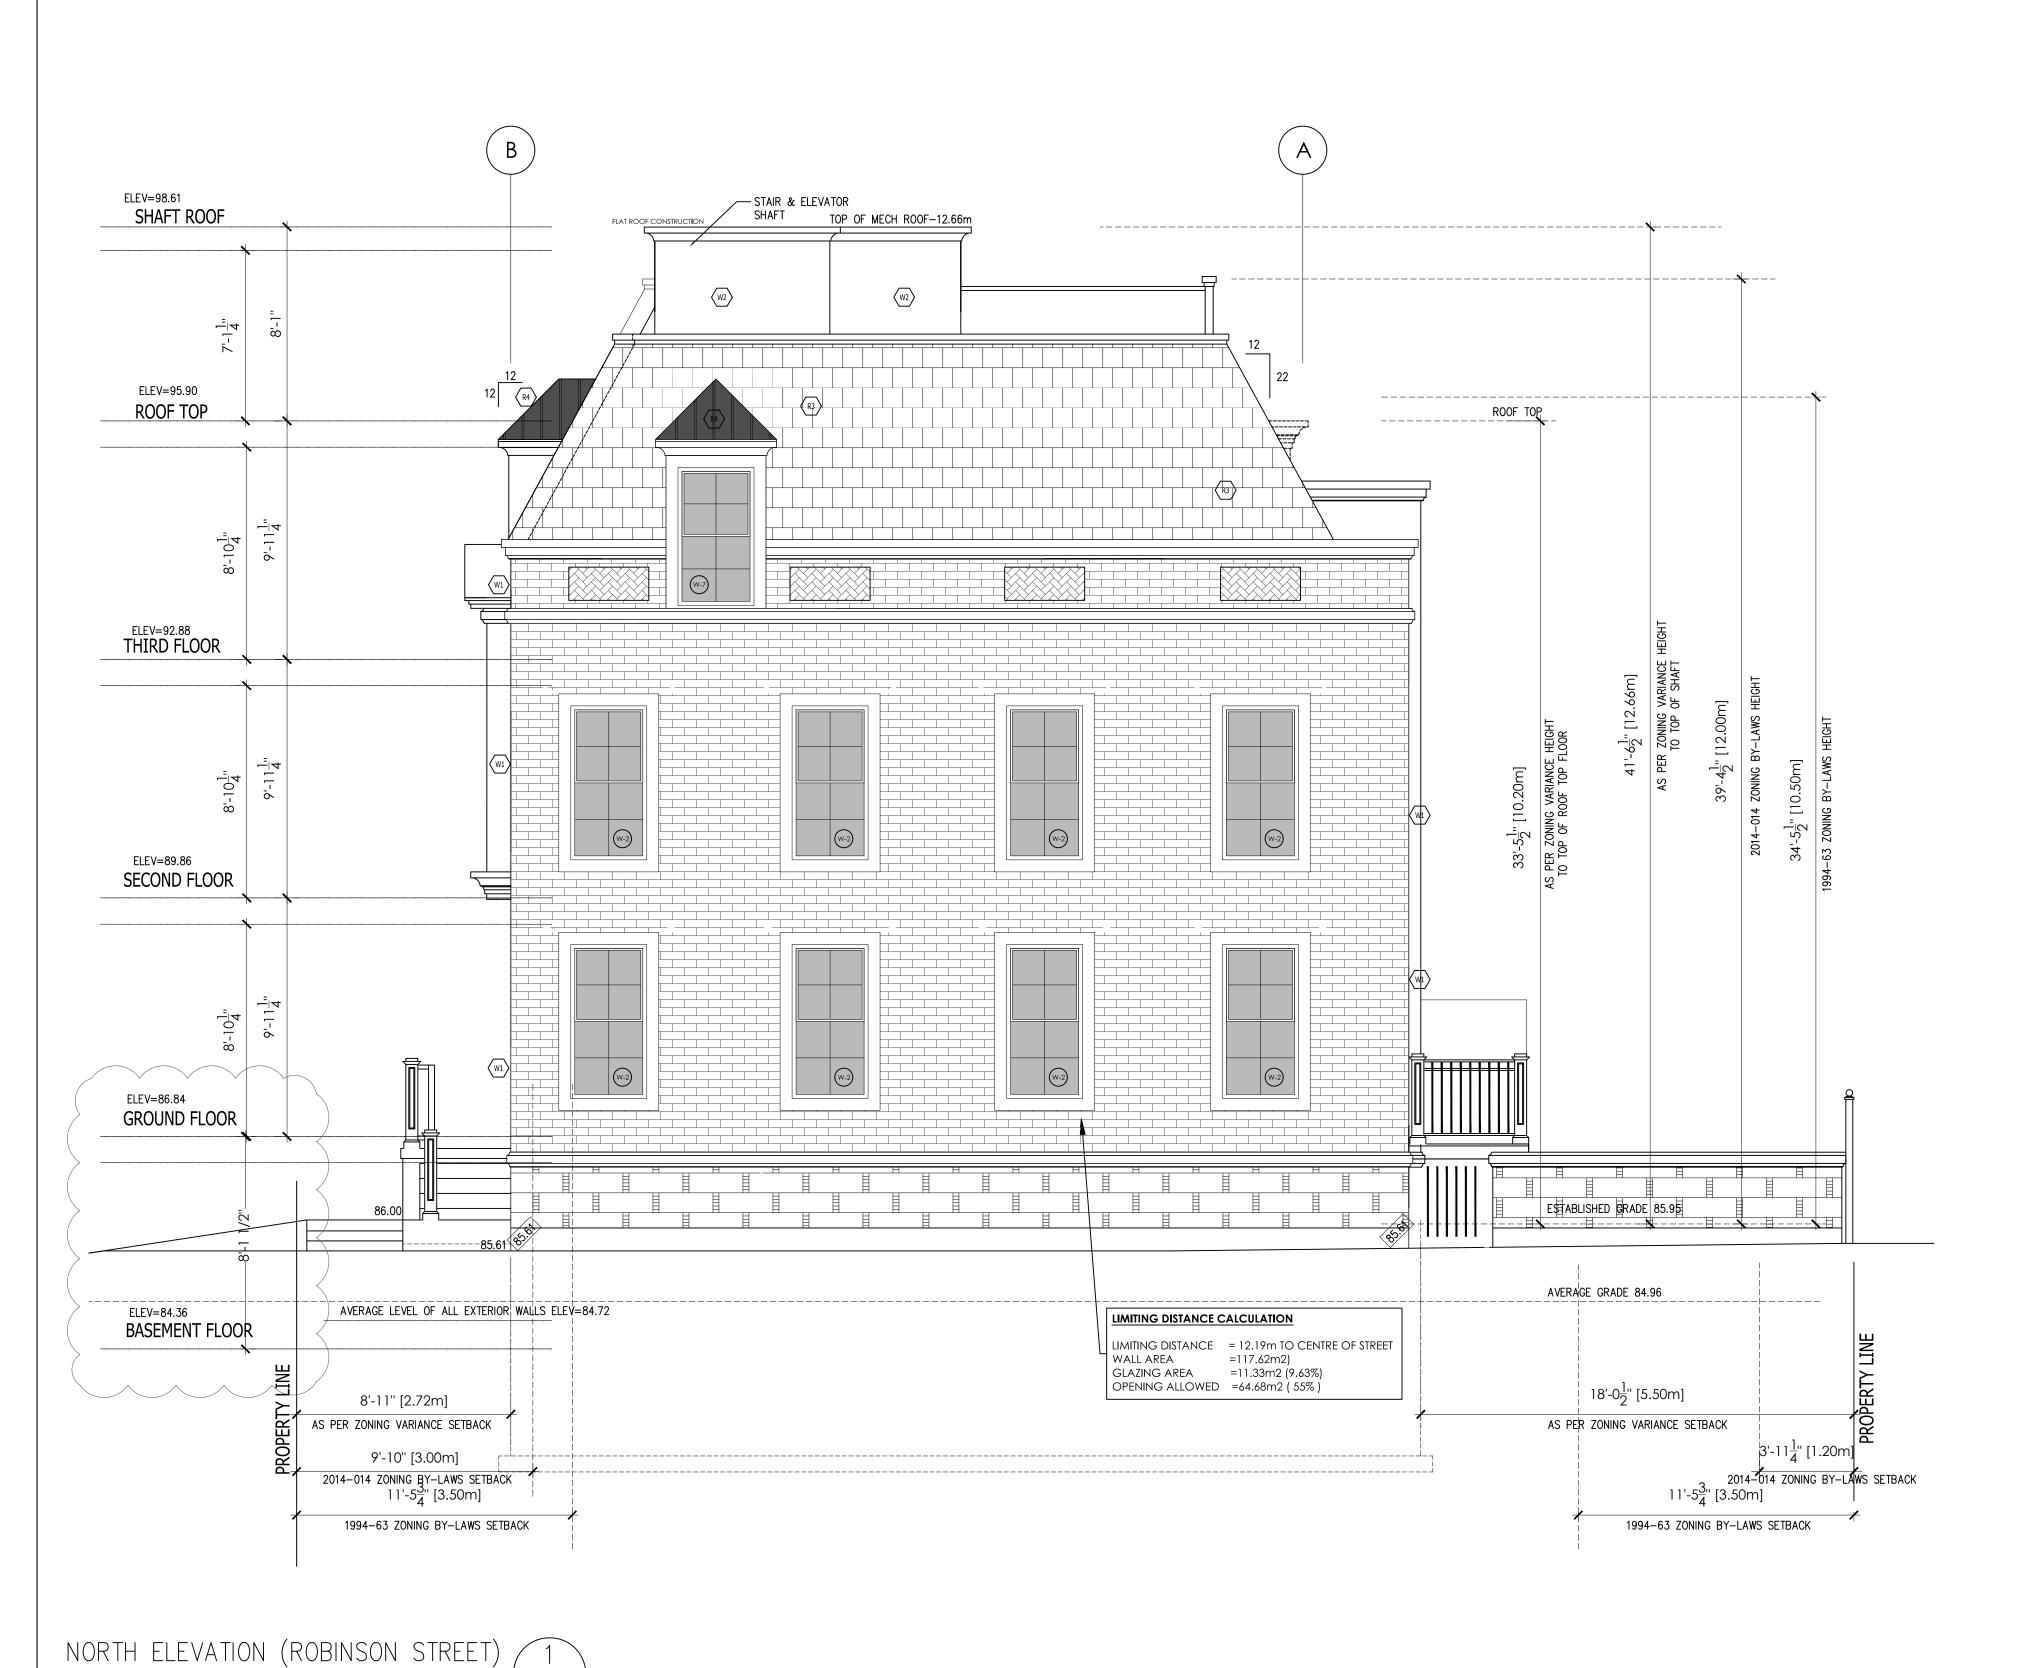

1/4"=-1'0"



BLOOR STREET, MISSISSAUGA, ONTARIO (416) 655-0245 email: jrcpdesigns@yahoo.ca www. jrcpdesigns.com

### GENERAL NOTES:

THE DESIGNER IS NOT RESPONSIBLE FOR THE ACCURACY OF SURVEY, STRUCTURAL, MECHANICAL, ELECTRICAL OR ANY ENGINEERING INFORMATION SHOWN ON THE DRAWING. REFER TO THE APPROPRIATE ENGINEERING DRAWINGS BEFORE PROCEEDING WITH THE WORK. REPORT ANY DISCREPANCIES BETWEEN ARCHITECTURAL AND ENGINEERING DRAWINGS TO THE DESIGNER BEFORE PROCEEDING WITH THE WORK.

GENERAL CONTRACTOR SHALL CHECK AND VERIFY ALL DIMENSIONS AND REPORT ALL ERRORS AND OMISSIONS TO THE DESIGNER.

CONSTRUCTION MUST CONFORM TO ALL APPLICABLE CODES AND REQUIREMENTS OF

## THIS DRAWING IS NOT TO BE SCALED.


AUTHORITIES HAVING JURISDICTION.

ALL CONSTRUCTION TO ADHERE TO THESE PLANS
AND SPEC'S AND TO CONFORM TO THE ONTARIO
BUILDING CODE AND ALL OTHER APPLICABLE CODES
AND AUTHORITIES HAVING JURISDICTION. THESE
REQUIREMENTS ARE TO BE TAKEN AS MINIMUM
SPECIFICATIONS. ONT. REG. 332/12

ALL LUMBER SHALL BE SPRUCE NO.2 GRADE OR BETTER, UNLESS NOTED OTHERWISE.

ASSUME SOIL BEARING CAPACITY OF 75 KPA

ISSUE DATE AND REVISION LOG		
NO.	REVISION	DATE
01	ISSUED FOR CONSULTANTS	JUNE 7 2022
02	ISSUED FOR BP	AUG 03 2022
03	AS PER EXAMINERS COMMENTS	SEP 28 2022
04	RE-ISSUED TO CONSULTANTS	APR 19 2023
05	ISSUED FOR CLIENT REVIEW	DEC 20 2023
06	ISSUED FOR STL. SUPPLIER	JAN 29 2024
07	ISSUED FOR CLIENT REVIEW REVISED ELEVATIONS	FEB 0I 2024
08	ISSUED FOR CONSTRUCTION	FEB 09 2024

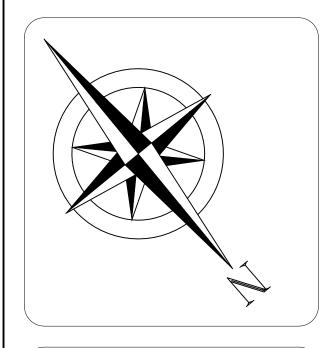

SEAL:

FOR ARCHITECTURAL & STRUCTURAL REVIEW

PROJECT NAME AND ADDRESS:


TOWNHOUSE DEVELOPMENT

78-80-82 TRAFALGAR RD. OAKVILLE, ON. (PROPOSED 78, 80 & 82 TRAFALGAR RD.)

SCOPE OF WORKS:

NEW BUILD CONSTRUCTION

DRAWINGS TITLE	SHEET NO.
WEST ELEVATION	A-2.3
DATE MAY 30 2022	7 2.0
DESIGNED BY:	SCALE
DRAWN BY:	NOTED

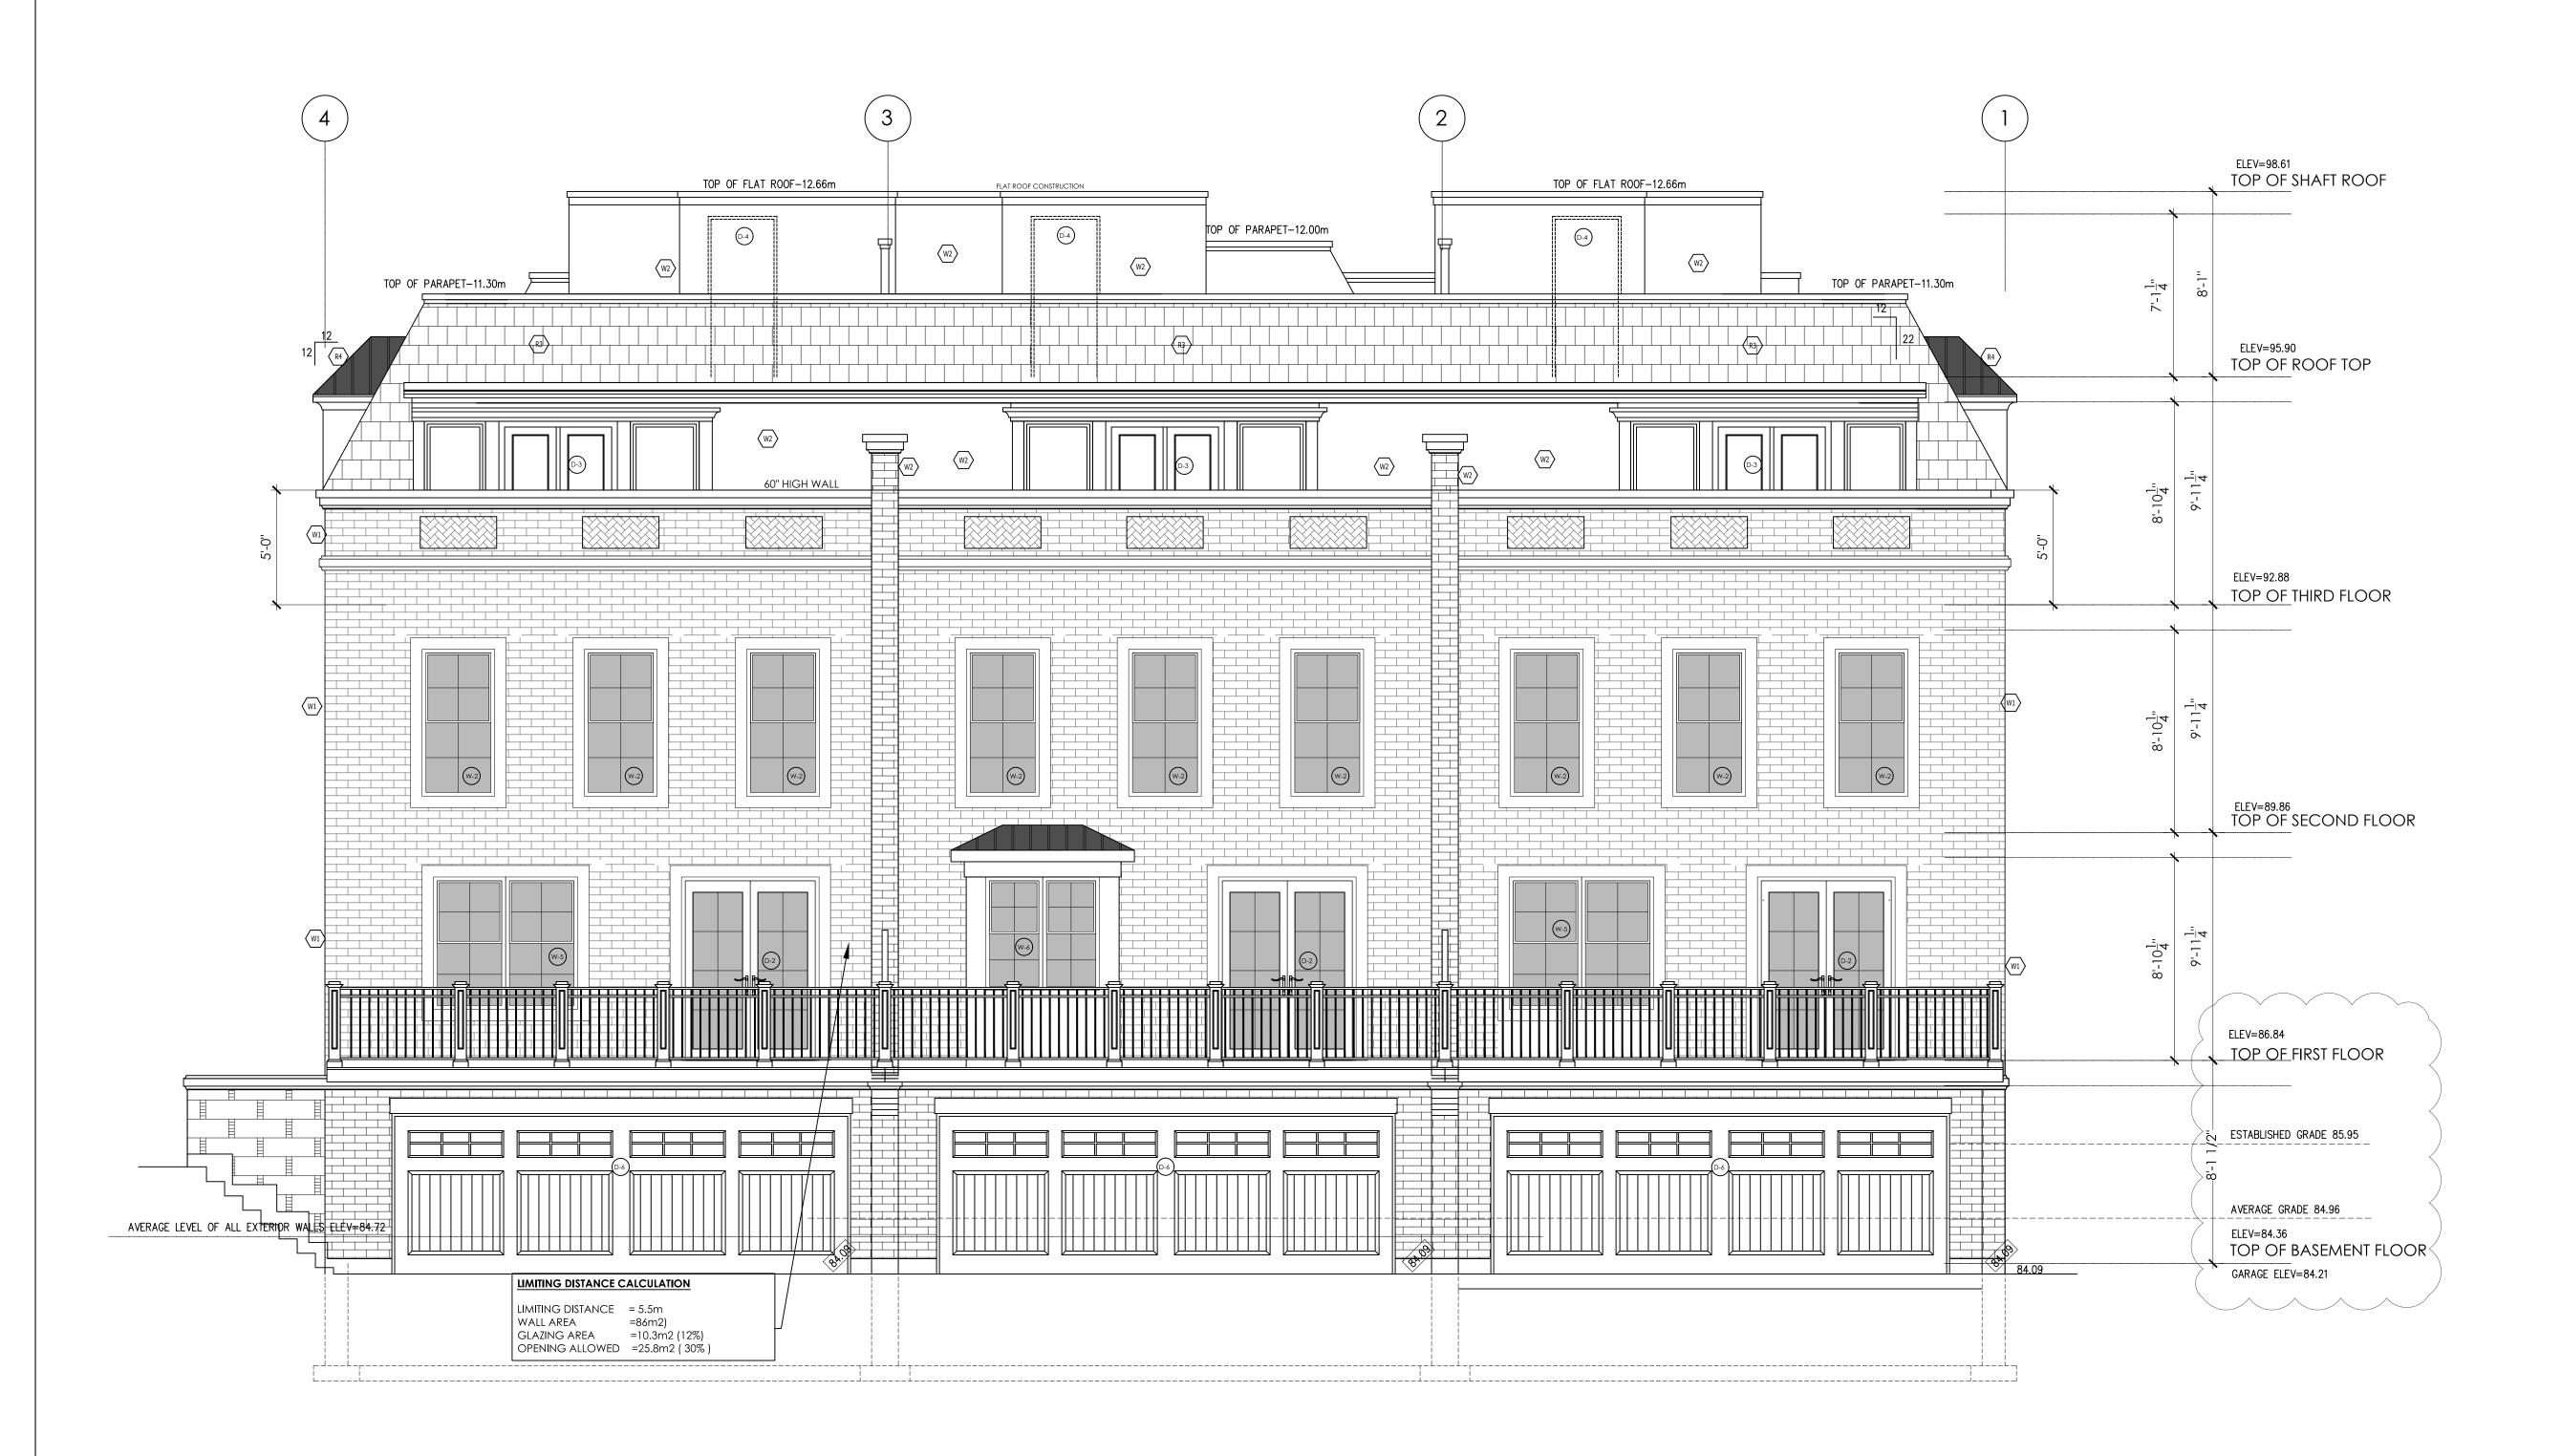

WEST ELEVATION (REAR)

1/4"=-1'0"

2.3

THE STRUCTURE HAS BEEN DESIGNED
IN ACCORDANCE WITH THE REQUIREMENTS
OF THE 2012 ONTARIO BUILDING CODE
LATEST EDITION. CONSTRUCTION
PRACTICES SHALL BE ACCORDING TO THE SAME



BLOOR STREET, MISSISSAUGA, ONTARIO (416) 655-0245 email: jrcpdesigns@yahoo.ca www. jrcpdesigns.com

### GENERAL NOTES:

THE DESIGNER IS NOT RESPONSIBLE FOR THE ACCURACY OF SURVEY, STRUCTURAL, MECHANICAL, ELECTRICAL OR ANY ENGINEERING INFORMATION SHOWN ON THE DRAWING. REFER TO THE APPROPRIATE ENGINEERING DRAWINGS BEFORE PROCEEDING WITH THE WORK. REPORT ANY DISCREPANCIES BETWEEN ARCHITECTURAL AND ENGINEERING DRAWINGS TO THE DESIGNER BEFORE PROCEEDING WITH THE WORK.

GENERAL CONTRACTOR SHALL CHECK AND VERIFY ALL DIMENSIONS AND REPORT ALL ERRORS AND OMISSIONS TO THE DESIGNER.

CONSTRUCTION MUST CONFORM TO ALL

APPLICABLE CODES AND REQUIREMENTS OF AUTHORITIES HAVING JURISDICTION.

THIS DRAWING IS NOT TO BE SCALED.


ALL CONSTRUCTION TO ADHERE TO THESE PLANS
AND SPEC'S AND TO CONFORM TO THE ONTARIO
BUILDING CODE AND ALL OTHER APPLICABLE CODES
AND AUTHORITIES HAVING JURISDICTION. THESE
REQUIREMENTS ARE TO BE TAKEN AS MINIMUM

SPECIFICATIONS. ONT. REG. 332/I2

ALL LUMBER SHALL BE SPRUCE NO.2 GRADE OR BETTER, UNLESS NOTED OTHERWISE.

ASSUME SOIL BEARING CAPACITY OF 75 KPA

02 ISSUED FOR BP  AUG 03 2  03 AS PER EXAMINERS COMMENTS SEP 28 2  04 RE-ISSUED TO CONSULTANTS APR 19 2  05 ISSUED FOR CLIENT REVIEW DEC 20 2  06 ISSUED FOR STL. SUPPLIER JAN 29 2  07 ISSUED FOR CLIENT REVIEW FEB 01 20	_		
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03 AS PER EXAMINERS COMMENTS SEP 28 2  04 RE-ISSUED TO CONSULTANTS APR 19 20  05 ISSUED FOR CLIENT REVIEW DEC 20 20  06 ISSUED FOR STL. SUPPLIER JAN 29 20  07 ISSUED FOR CLIENT REVIEW FEB 01 20	01	ISSUED FOR CONSULTANTS	JUNE 7 2
04 RE-ISSUED TO CONSULTANTS APR 19 20 05 ISSUED FOR CLIENT REVIEW DEC 20 20 06 ISSUED FOR STL. SUPPLIER JAN 29 20 07 ISSUED FOR CLIENT REVIEW REVISED ELEVATIONS FEB 01 20	02	ISSUED FOR BP	AUG 03 20
05 ISSUED FOR CLIENT REVIEW DEC 20 20 06 ISSUED FOR STL. SUPPLIER JAN 29 20 07 ISSUED FOR CLIENT REVIEW REVISED ELEVATIONS FEB 01 20	03	AS PER EXAMINERS COMMENTS	SEP 28 2
06 ISSUED FOR STL. SUPPLIER  07 ISSUED FOR CLIENT REVIEW REVISED ELEVATIONS  FEB 01 20	04	RE-ISSUED TO CONSULTANTS	APR 19 2
07 ISSUED FOR CLIENT REVIEW REVISED ELEVATIONS FEB 0I 20	05	ISSUED FOR CLIENT REVIEW	DEC 20 20
REVISED ELEVATIONS FEB 01 20	06	ISSUED FOR STL. SUPPLIER	JAN 29 2
08 ISSUED FOR CONSTRUCTION FEB 09 20	07		FEB 0I 20
	08	ISSUED FOR CONSTRUCTION	FEB 09 20

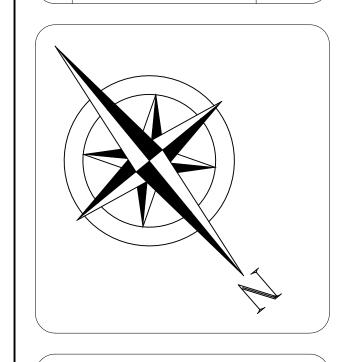

SEAL:

FOR ARCHITECTURAL & STRUCTURAL REVIEW

PROJECT NAME AND ADDRESS:

TOWNHOUSE DEVELOPMENT

78-80-82 TRAFALGAR RD. OAKVILLE, ON. (PROPOSED 78, 80 & 82 TRAFALGAR RD.)

SCOPE OF WORKS:

NEW BUILD CONSTRUCTION

THE STRUCTURE HAS BEEN DESIGNED


OF THE 2012 ONTARIO BUILDING CODE

LATEST EDITION. CONSTRUCTION

IN ACCORDANCE WITH THE REQUIREMENTS


PRACTICES SHALL BE ACCORDING TO THE SAME

DRAWINGS TITLE	SHEET NO.
SOUTH ELEVATION	A-2.4
DATE MAY 30 2022	<b>/                                    </b>
DESIGNED BY:	SCALE
DRAWN BY:	NOTED

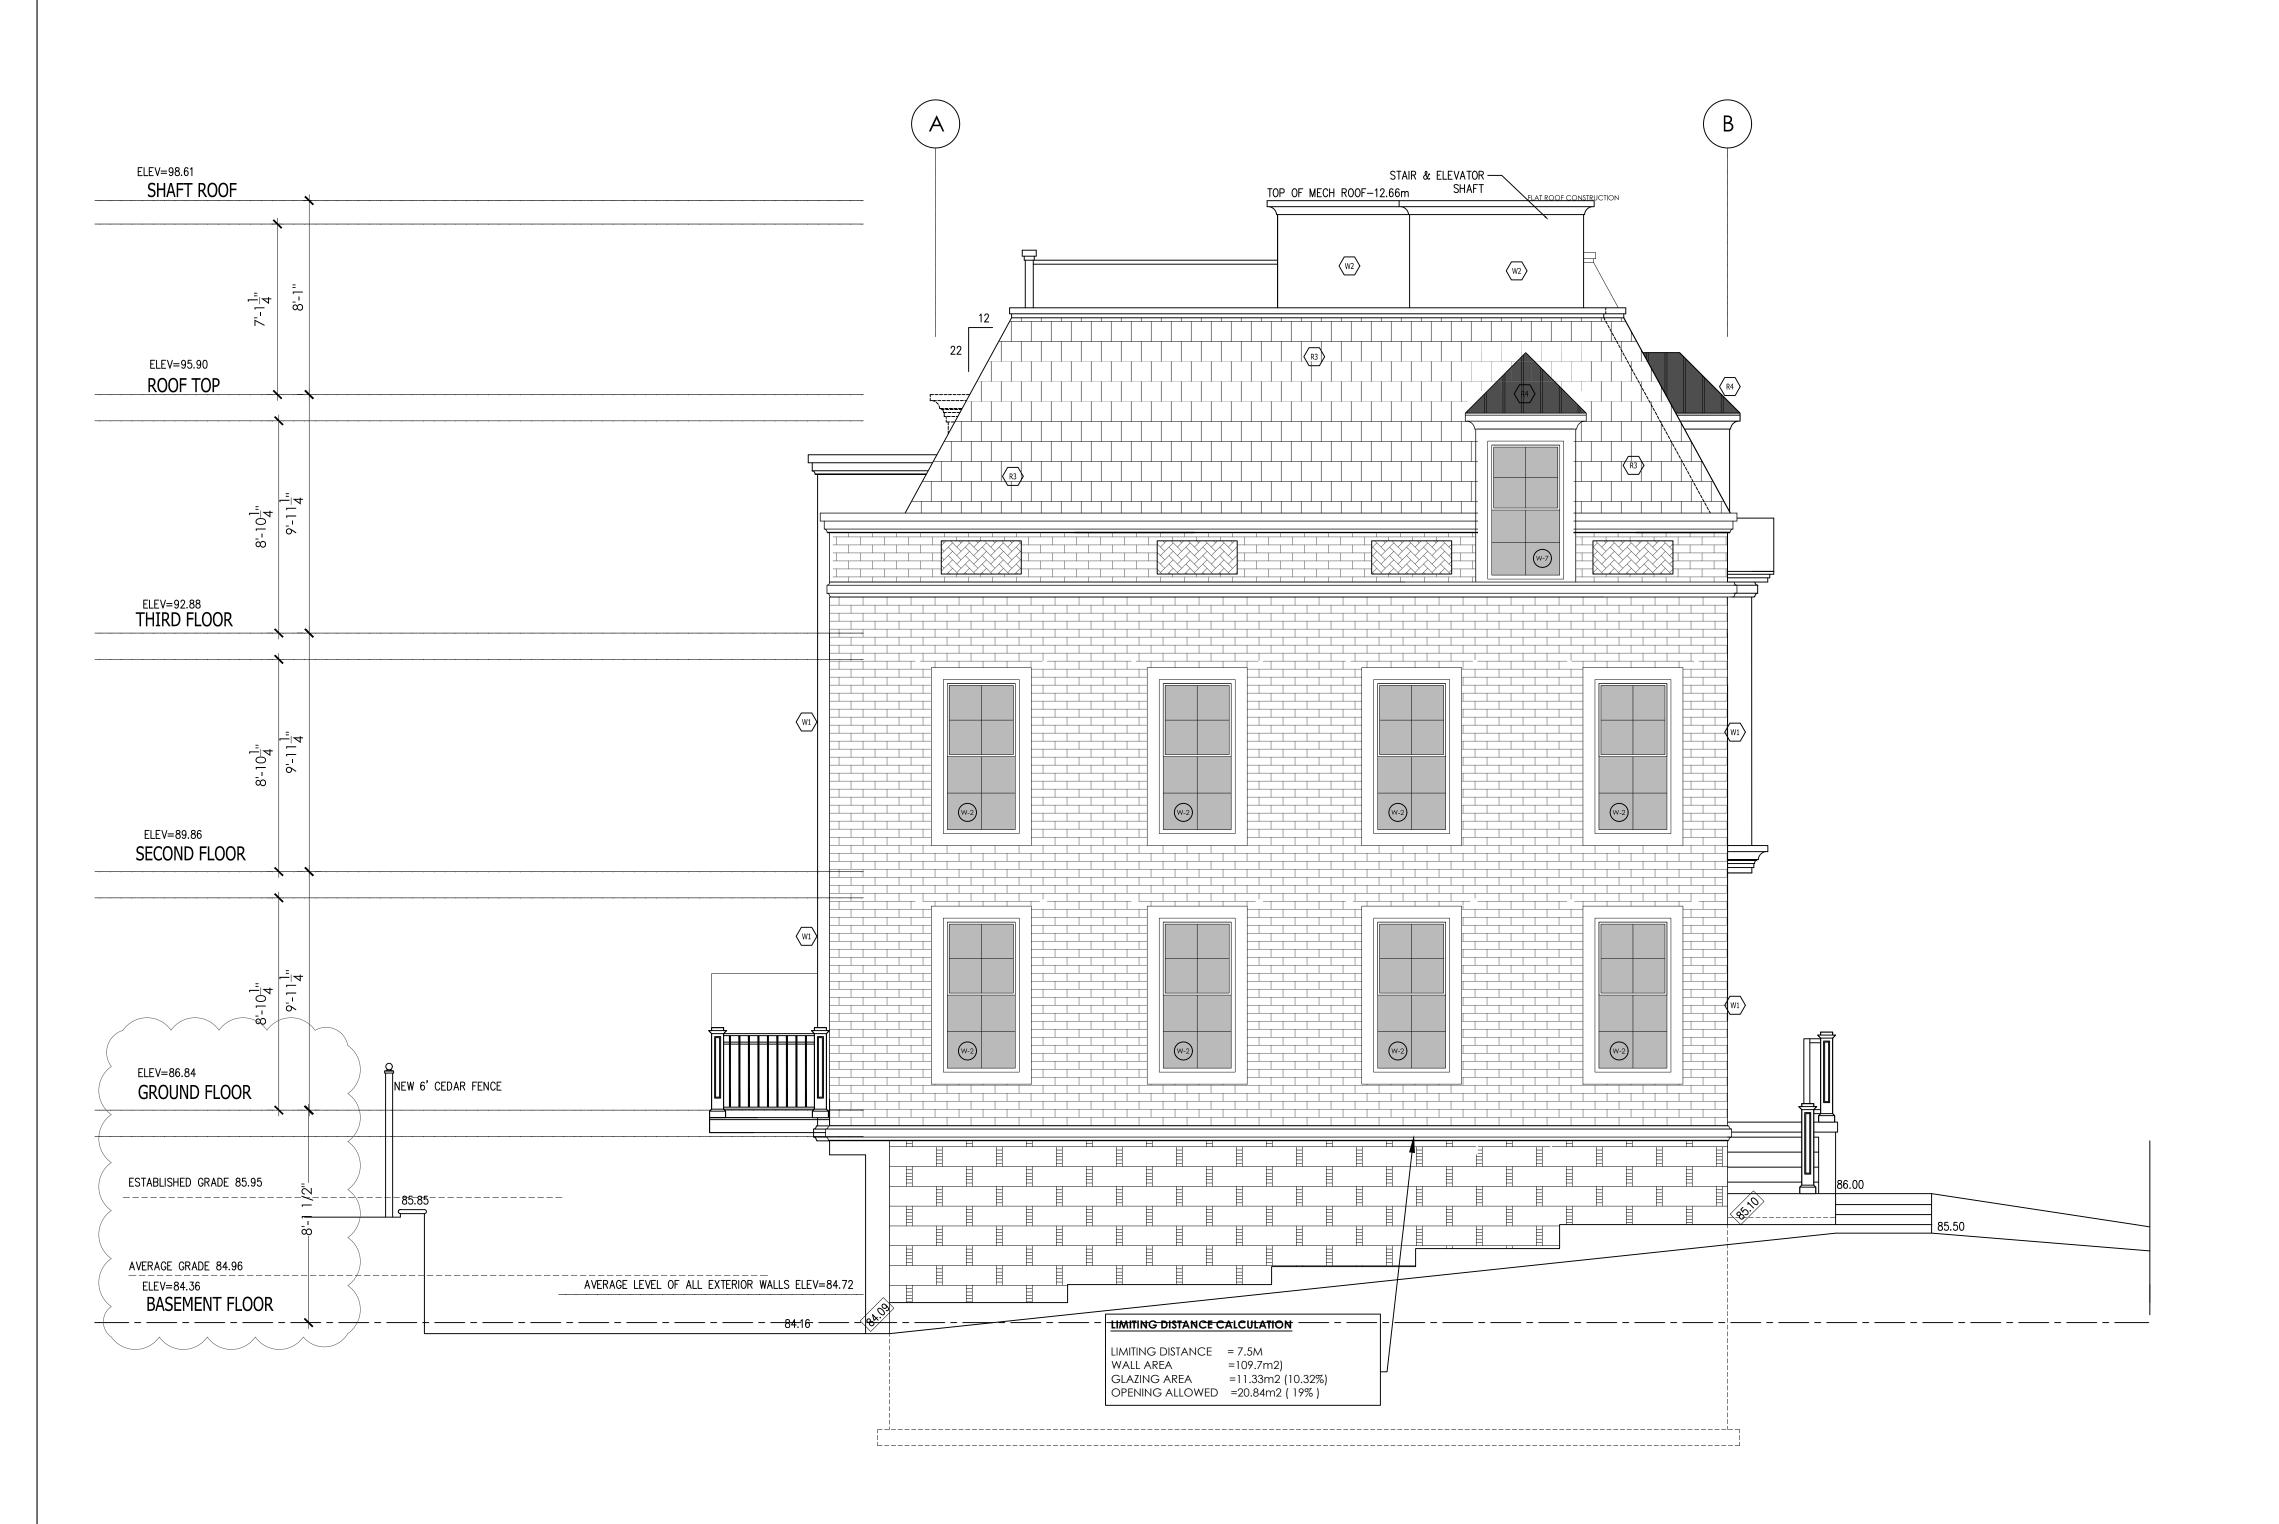


SOUTH ELEVATION (INTERIOR SIDE) 1

1/4"=-1'0"

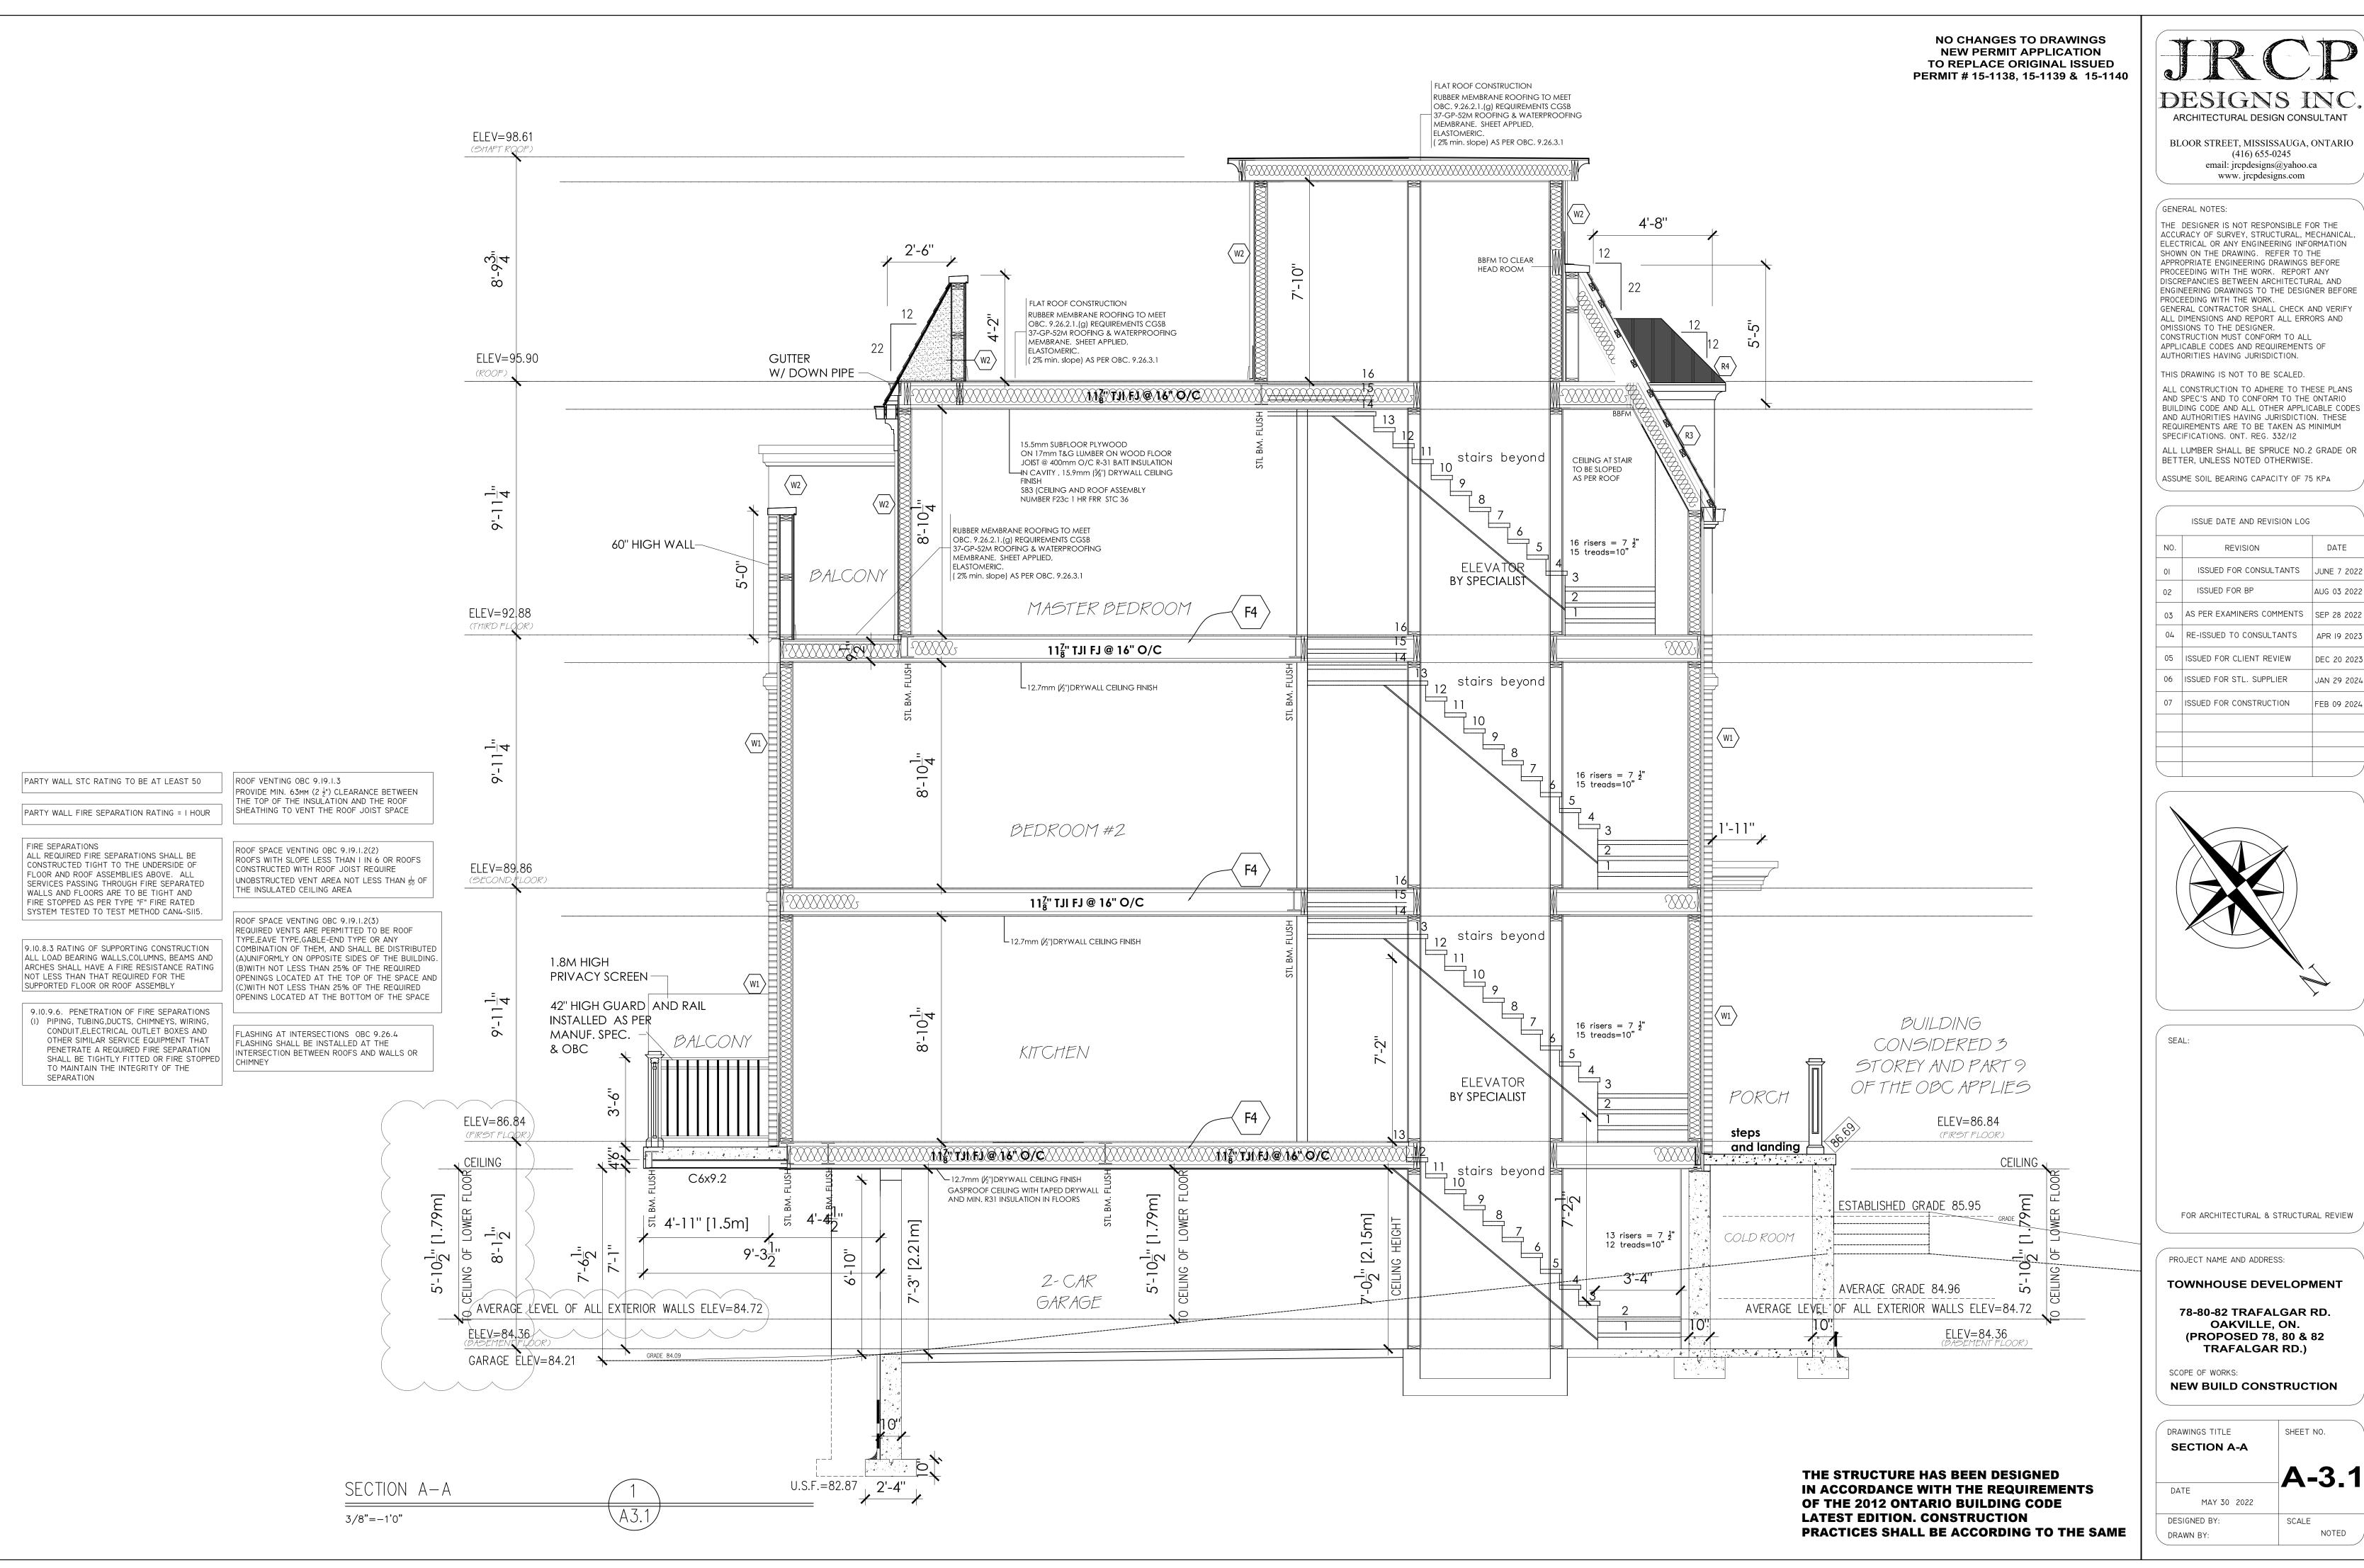


ISSUED FOR CONSULTANTS JUNE 7 2022 AUG 03 2022 03 AS PER EXAMINERS COMMENTS | SEP 28 2022 APR 19 2023 DEC 20 2023 JAN 29 2024 FEB 09 2024


A-3.1

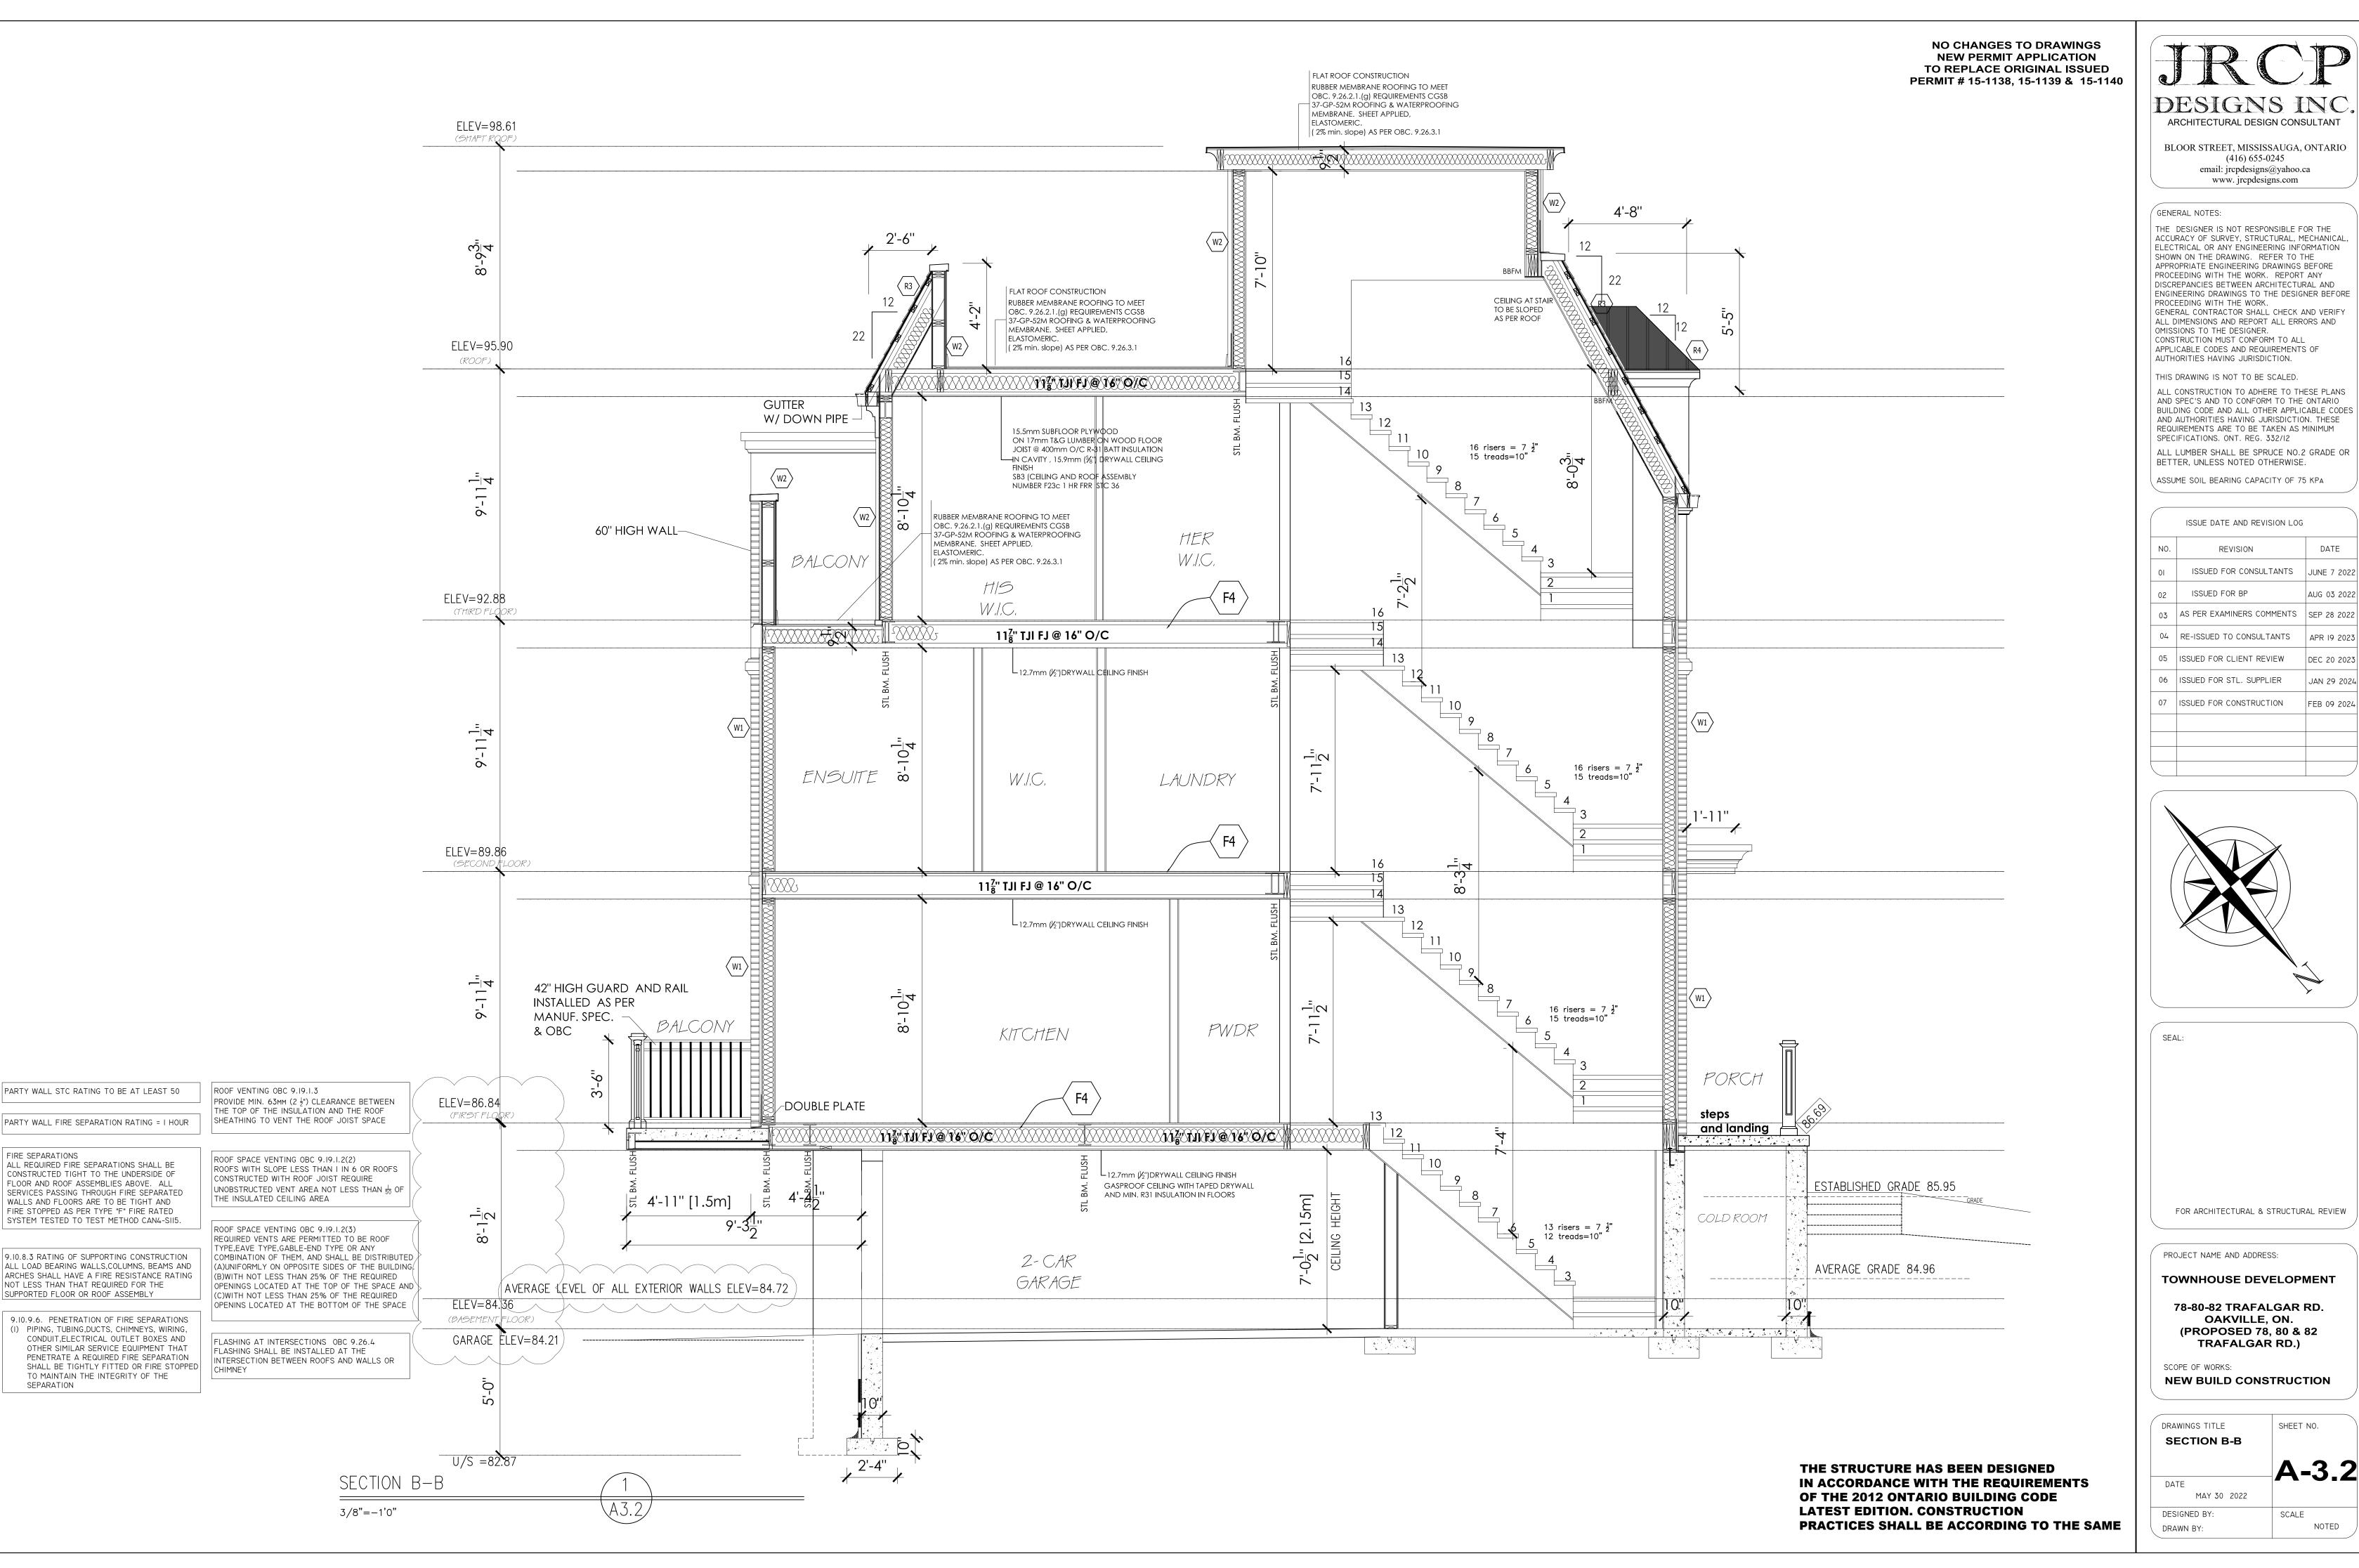

	ISSUE DATE AND REVISION LOG	
NO.	REVISION	DATE
01	ISSUED FOR CONSULTANTS	JUNE 7 202
02	ISSUED FOR BP	AUG 03 202
03	AS PER EXAMINERS COMMENTS	SEP 28 202
04	RE-ISSUED TO CONSULTANTS	APR 19 202
05	ISSUED FOR CLIENT REVIEW	DEC 20 202
06	ISSUED FOR STL. SUPPLIER	JAN 29 202
07	ISSUED FOR CONSTRUCTION	FEB 09 202

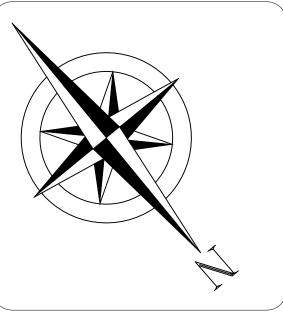

A-3.2

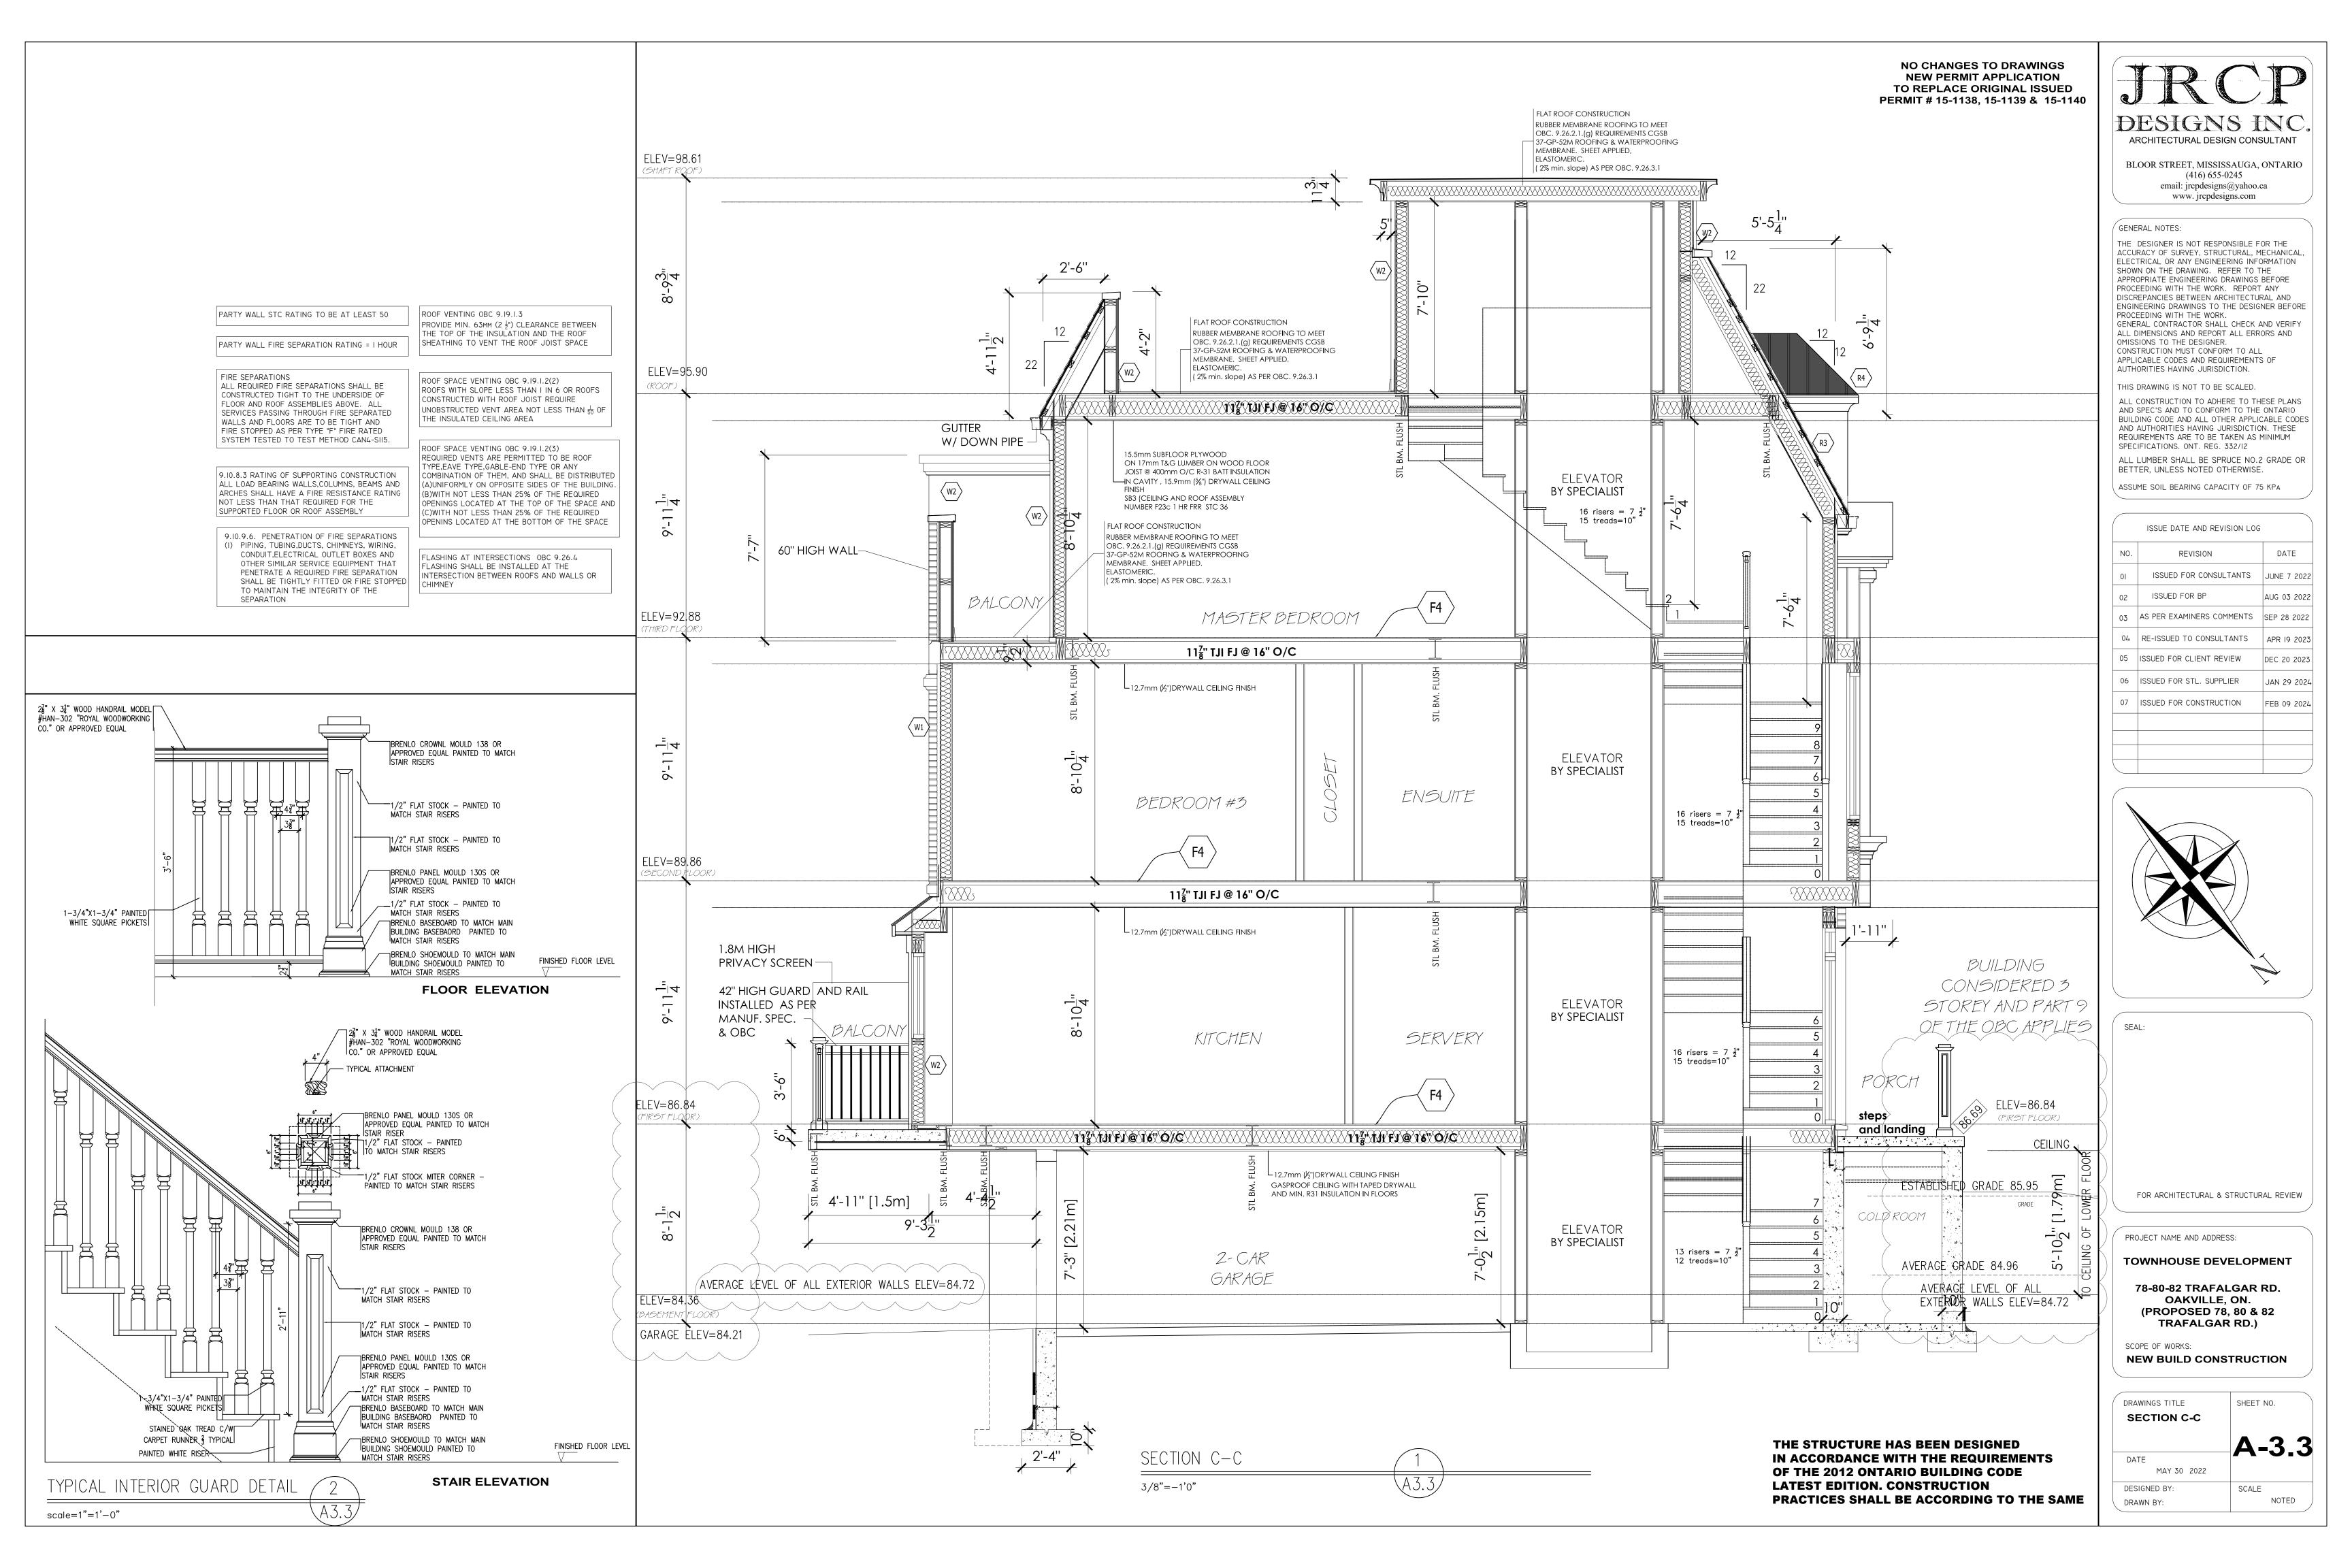



Partners:
Glen Broll, MCIP, RPP
Colin Chung, MCIP, RPP
Jim Levac, MCIP, RPP
Jason Afonso, MCIP, RPP
Karen Bennett, MCIP, RPP

In Memoriam, Founding Partner: Glen Schnarr

October 21, 2024 GSAI File: 1424-001

Town of Oakville Planning Services 1225 Trafalgar Road Oakville, Ontario, L6H 0H3

**Attention:** Brandon Hassan, MCIP, RPP

Senior Planner

Planning & Development

**Re:** Minor Variance Application

2848327 Ontario Limited

78-82 Trafalgar Road, Oakville, ON

Related File: SP.1713.040/03 & 24CDM-24008/1713

Glen Schnarr & Associates Inc. ("GSAI") are the planning consultants for 2848327 Ontario Limited, owner of the lands municipally addressed as 78, 80, 82 Trafalgar Road (herein referred to as the "subject lands" or the "site"). On behalf of the owner, we are pleased to submit this Minor Variance Application to seek relief in the Town of Oakville Zoning By-law 2014-014 to facilitate the development of three (3) townhouse units (the "proposed development").

#### **Site Description and Surrounding Land Uses**

The subject lands are generally located south of Robinson Street and west of Trafalgar Road in the Town of Oakville. The site is rectangular in shape with an approximate area of 0.06 hectares (0.15 acres), and it is legally described as "Part of Lot C, Block 16, Plan 1, designated as Part 1 on Plan 20R-20256; Oakville".

The lands surrounding the subject property generally consist of residential and commercial uses. A four-storey residential apartment building is located directly north of the site, while single detached residences are located to the east, west and south. A commercial plaza is located to the northeast of the site.

The site is currently under construction.



#### **Proposed Development**

The development can be generally described as three townhouse units facing Trafalgar Road with heights of three storeys and a total lot area of approximately 624.57 sq. metres. The proposed units have a depth of 11.4 metre and a width of 22.33 metres with a gross floor area of approximately 711.35 sq. metres, respectively.

The proposal is accessible through continuous walkways off of Robinson Street and Trafalgar Road. Vehicular access is provided from the Trafalgar Road right of away, providing access to the garages of the residents which are situated beneath the units.

The Minor Variance request before the Committee is based on the drawings associated with the previously approved Site Plan application and Note to File. These processes are briefly described below.

#### **Background and Ongoing/Future Planning Processes**

While not in the purview of the Committee, we provide the following discussion regarding the Background and Ongoing/Future Planning processes associated with or tied to the subject lands.

Firstly, we note that previously, the Committee of Adjustment approved a series of minor variances (CAV.A/040/2014) to permit relief of various zoning provisions under the Town's Zoning Bylaw. These approvals remain in place for the subject lands.

In 2023, our client obtained formal Site Plan Approval (File: SP.1713.040/03) and most recently on July 23, 2024, obtained approval for a Note to File which ultimately amended the approved site plan drawings (however minimally).

GSAI is also advancing a Plan of Condominium application (File: 24CDM-24008/1713) to facilitate approval for a Common Element Condominium ("CEC") on the subject lands. Ultimately, the CEC will create three distinct lots and common elements. This application proceeded to the Town's Planning and Development Council ("PDC") on October 15, 2024 where staff recommended conditions of approval. At the meeting, the PDC approved the staff's recommendation for the proposed Plan of Condominium application.

Additionally, GSAI is presently preparing to file an application for Part Lot Control Exemption ("PLCE") under a separate cover to facilitate the creation of the three lots. We confirm the lands exist as a part of a Registered Plan of Subdivision (Part of Lot C, Block 16, Plan 1, designated as Part 1 on Plan 20R-20256).

Of relevance to the application before Committee today, we confirm that our Client had various discussions with Planning, legal and zoning staff (as appropriate) as part of the Site Plan Approval process regarding the appropriateness of the CEC application, given the development proposal characteristics. Ultimately, it was agreed upon that while a CEC application could be filed, alongside a PLCE (at the appropriate time), a Minor Variance application would be required to address the zoning deficiencies resultant of the formal creation of the 3 lots. To confirm the mutual



understanding of the parties, our Client (2848327 ONTARIO LIMITED) entered into an Agreement (known as the "letter agreement") with the Town of Oakville (THE CORPORATION OF THE TOWN OF OAKVILLE) which included "Schedule D Form of Common Element Minor Variance".

#### Schedule D provides:

Zoning By-law Regulation	Variance Request
Section 6.10 c) - For a common element condominium, the applicable zoning	To permit the applicable zoning regulations to apply to the entirety of the lot for a common
regulations shall apply to the proposed lots or	element condominium.
blocks to be parcels of tied land until the lots	
or blocks are formally established.	

Therefore, in accordance with the letter agreement, specifically Schedule D, we are pleased to advance this formal application for Minor Variance.

#### **Proposed Variance**

As agreed upon through the letter agreement, the owner is proposing relief of *Section 6.10c*) regarding separation of dwelling units under the Town's Zoning By-law 2014-014, which states the following:

"For a common element condominium, the applicable zoning regulations shall apply to the proposed lots or blocks to be parcels of tied land until the lots or blocks are formally established."

Relief from *Section 6.10c*) will enable the dwelling units, following formal lot creation, to comply with the applicable zoning regulations, and ultimately, that the three lots continue to be treated as one lot <u>for the purposes of zoning compliance</u>. This variance request can be seen as a 'blanket' variance request to address the zoning compliance issues that would result from the lot creation (forthcoming). This variance is largely technical in nature and does not alter/change the approved development plans through the Site Plan approval process. This is simply a housekeeping matter to address the zoning deficiencies that would arise through formal lot creation (through the CEC/PLCE process).

#### Planning Rationale for Proposed Variances

Section 45(1) of the Planning Act, as amended, identifies the four tests which must be satisfied in order for the Committee of Adjustment to approve this application. The following section provides an analysis demonstrating how the variances satisfy these tests.



#### 1. The variance maintains the general intent and purpose of the Official Plan.

The subject property is designated as 'Medium Density Residential' in the Town's Official Plan, which permits a range of density housing types including multiple-attached dwelling units. Section 11.1.8 of the Official Plan permits development of underutilized lands which are designated as Medium Density in stable residential communities. The proposed development contemplates three townhouse units and creates more efficient use of the subject lands in a stable residential neighbourhood. It is our opinion that the proposed variance maintains the general intent and purpose of the Official Plan.

#### 2. The variance maintains the general intent and purpose of the Zoning By-law.

The subject property is zoned 'Residential Medium Special Exception 50 (RM1-SP50)' in the Town's Zoning By-law 2014-014. The variance maintains the general intent and purpose of the Zoning By-law, as the use for townhouse units will be maintained as permitted in the 'Residential Medium Special Exception 50 (RM1-SP50)' zone. The proposal seeks relief from the zoning by-law to rectify any issues of compliance resulting from the CEC and lot creation.

In short, relief from the relevant zoning standard as described in the variance request would not change the proposal (as approved through Site Plan) and maintains the building configuration, however it simply prescribes that the zoning would apply as if the site were one lot (for zoning purposes), rather than 3 lots in the ultimate scenario, as being pursued through the CEC and PLCE applications. Therefore, on the basis that the configuration of the site and building is maintained, which cleared Zoning for the purposes of Site Plan Approval, meaning that this variance is technical in nature and does not frustrate the intent of the Zoning By-law, it is our opinion that the proposed variance maintains the general intent and purpose of the Town's Zoning By-law.

#### 3. The variance is desirable for the appropriate development or use of the land.

The variance is desirable for the appropriate development or use of the land as it is largely technical and continues to provide for a proposal that was otherwise approved and deemed appropriate by staff. The variance does not change the approved or intended use of the lands.

#### 4. The variance is minor in nature.

The variance is minor in nature as the site plan approved (and therefore zoning compliant) building or structure itself remains unchanged. This variance is technical in nature and responds to the forthcoming creation of lots through the associated processes. The actual development therefore, continues to satisfy the applicable zoning by-law, when the site is viewed as one lot for zoning purposes (rather than reviewing zoning compliance for 3 separate lots).

#### **Conclusion**

It is our opinion that the proposal satisfies Section 45(1) of the Planning Act, as the requested zoning relief is in keeping with the Town's approval for Minor Variance under CAV.A/040/2014,



Site Plan Application under SP.1713.040/03 and Plan of Condominium Application under 24CDM-24008/1713.

#### **Submission Deliverables**

In support of the pre-consultation submission, please find the following materials enclosed herein:

- Architectural Drawings as prepared by JRCP Architects dated July 5, 2024;
- Survey plan as prepared by J.H. Gelbloom Surveying Limited dated May 16, 2024;
- Landscape plan as prepared by Uncommon Ground dated July 4, 2024;
- Email correspondence with Zoning Staff, dated June 6, 2024.


We trust that the enclosed materials are satisfactory for the purposes of a Minor Variance Application. Please contact the undersigned should you have any questions.

Respectfully submitted,

GLEN SCHNARR & ASSOCIATES INC.

Sebastian Alzamora, MCIP, RPP

Planner

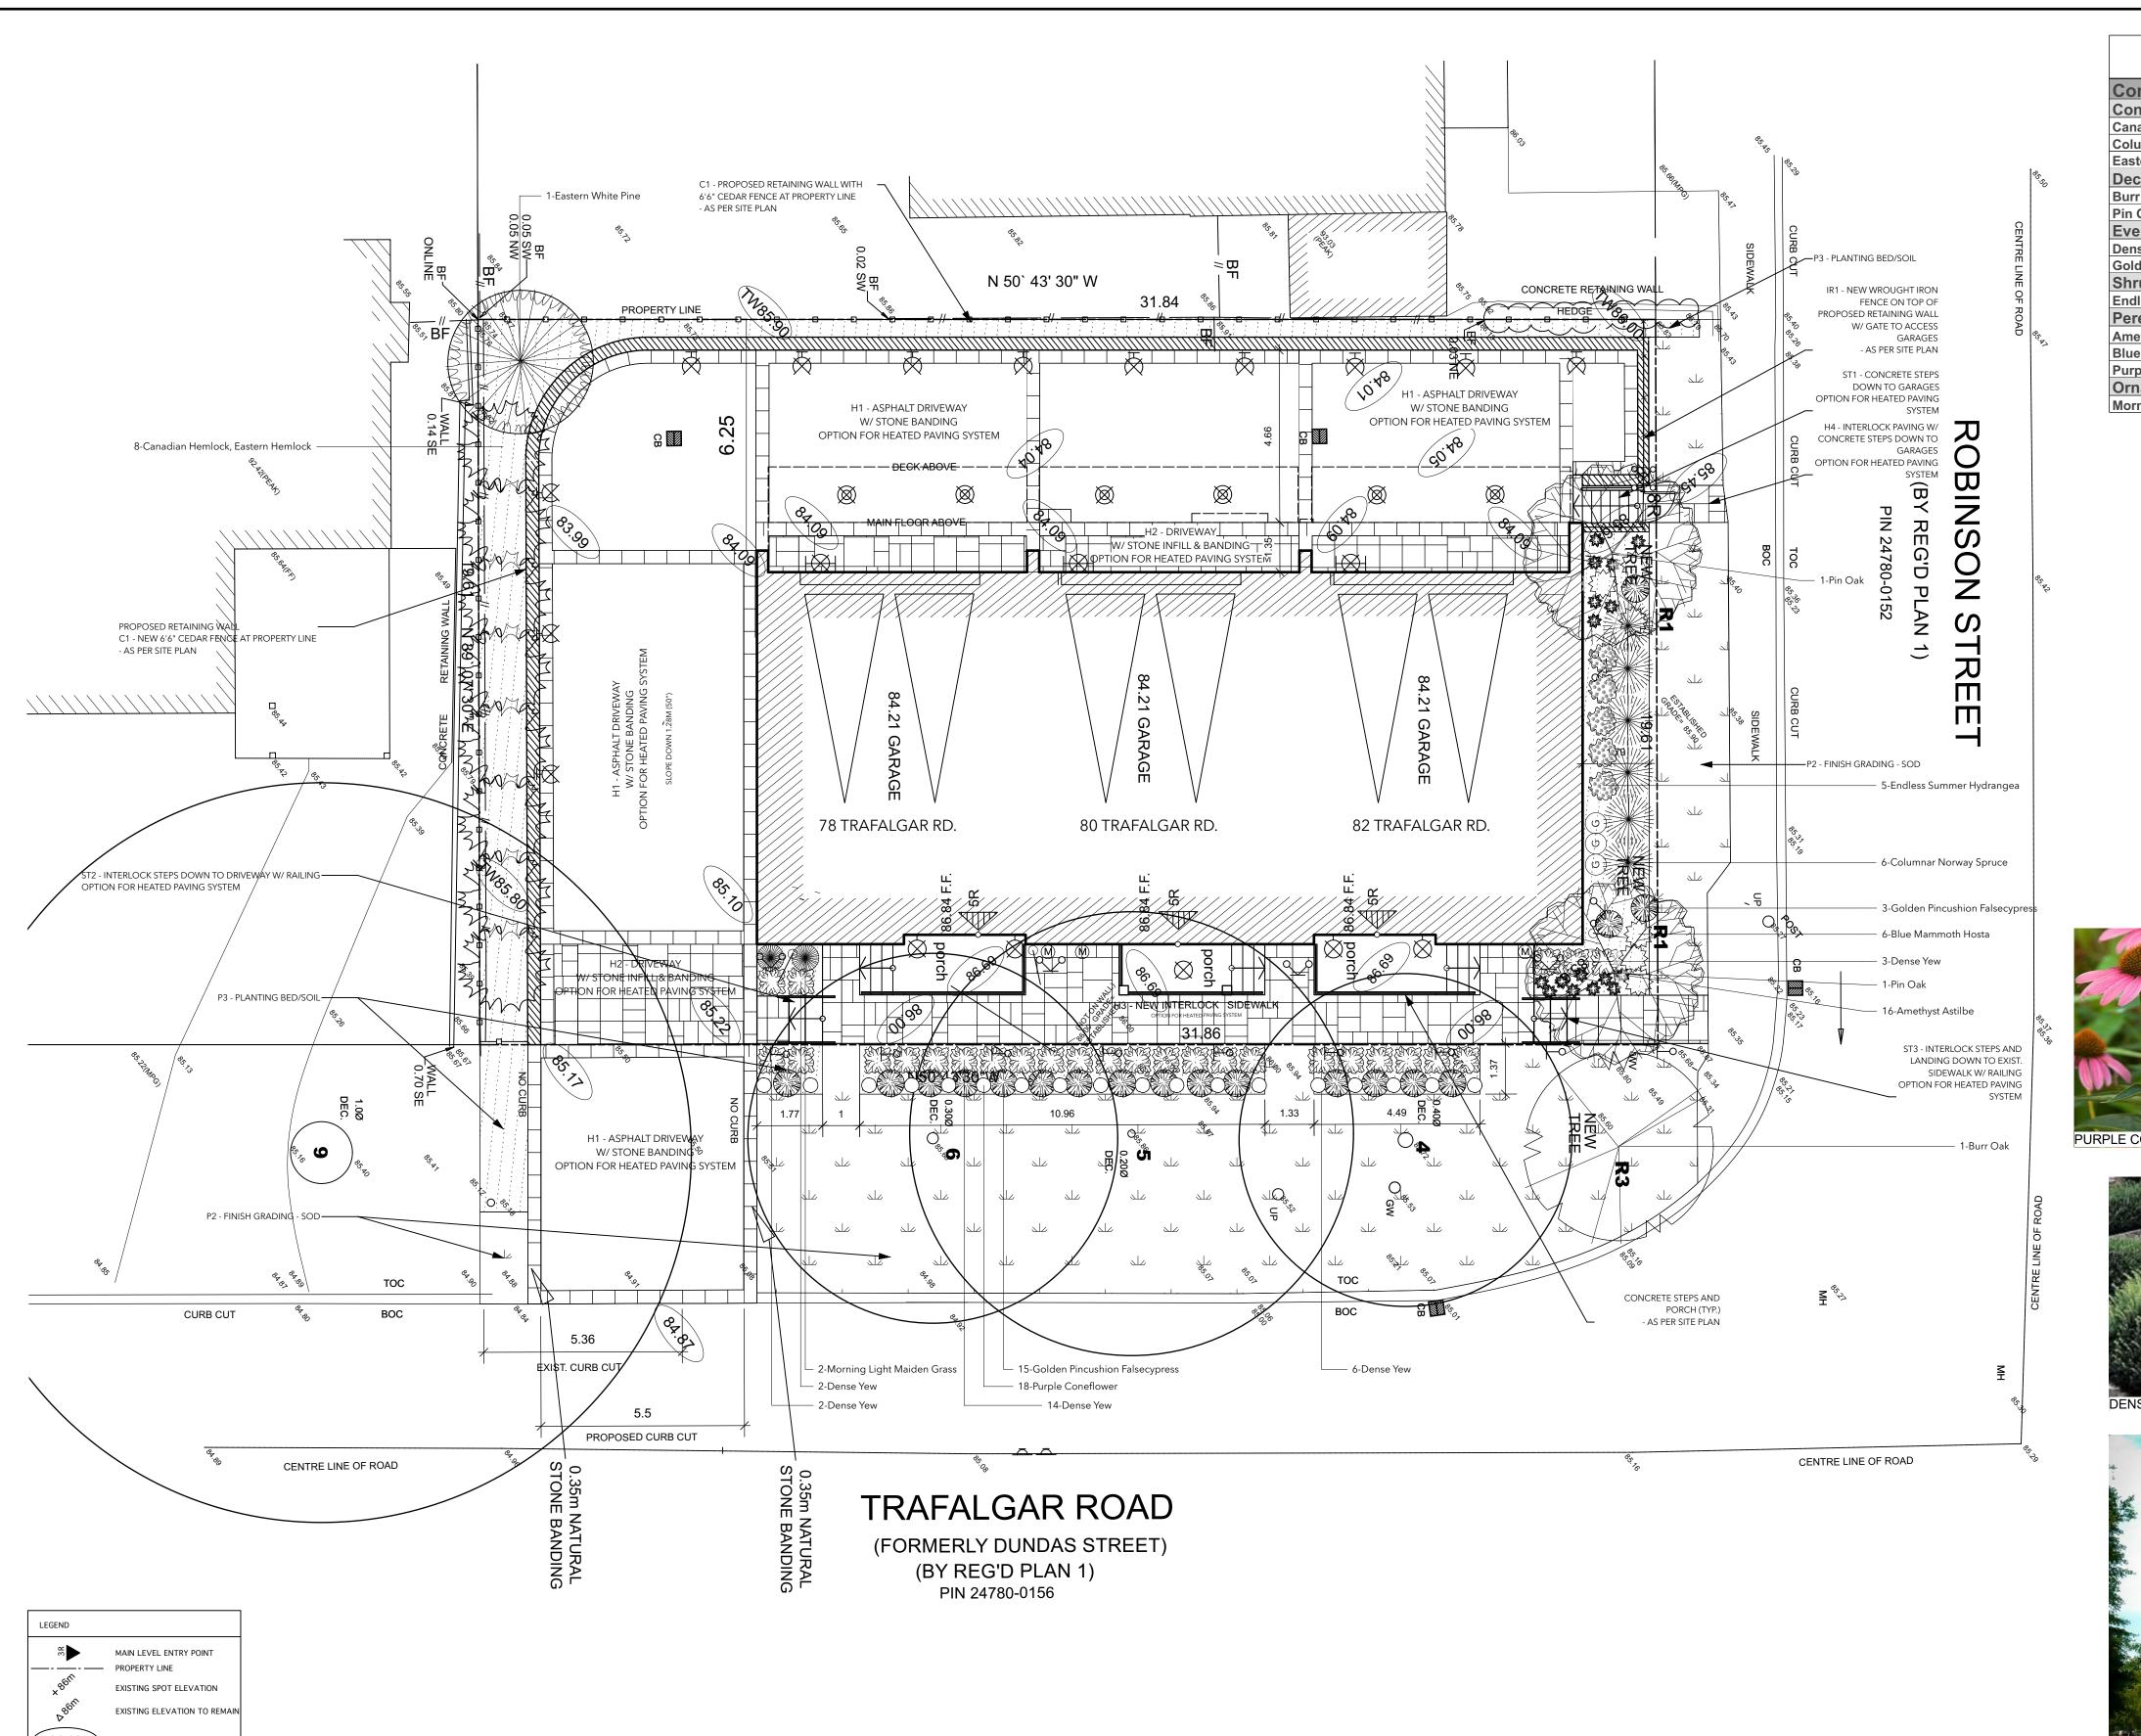

Plant List				
Common Name	<b>Botanical Name</b>	Qty	Scheduled Size	
Coniferous Trees				
Canadian Hemlock, Eastern Hemloc	Tsuga canadensis	8	150cm WB	
Columnar Norway Spruce	Picea abies 'Cupressina'	6	250cm WB	
Eastern White Pine	Pinus strobus	1	200cm WB	
<b>Deciduous Trees</b>				
Burr Oak	Quercus macrocarpa	1	60mm WB	
Pin Oak	Quercus palustris	2	60mm WB	
Evergreen Shrubs				
Dense Yew	Taxus x Media 'Densiformis'	27	30cm 3gal	
Golden Pincushion Falsecypress	Chamaecyparis pisifera 'Golden Pincushion'	18	40cm 3gal	
Shrubs				
Endless Summer Hydrangea	Hydrangea macrophylla 'Endless Summer'	5	2gal	
Perennials				
Amethyst Astilbe	Astilbe arendsii 'Amethyst'	16	1gal	
Blue Mammoth Hosta	Hosta 'Blue Mammoth'	6	1gal	
Purple Coneflower	Echinacea purpurea	18	1gal	
Ornamental Grasses				
Morning Light Maiden Grass	Miscanthus sinensis 'Morning Light'	2	2gal	






















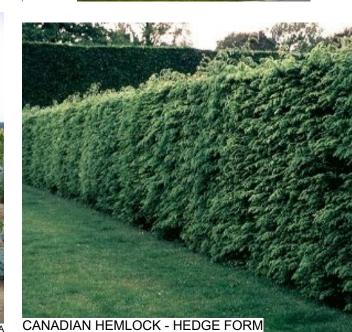





REVISIONS				
1	2022-09-28	TREE REVISION - CONIFER REPLACED W/ DECIDUOUS (AS PER SITE PLAN APPROVAL SECOND SUBMISSION)	EN	
2	2022-10-27	REVISED FRONT STEPS & FFE BASED ON ARCH REVISIONS - ADDED NOTATIONS FOR SOW	EN	
3	2022-11-04	CEDAR FENCE LAYOUT & NOTATIONS	EN	
5	2023-02-03	RETAINING WALL REMOVED FROM UCG SCOPE OF WORK & QTYS	EN	
6	2024-07-04	COORDINATE DRAWING TO MATCH LATEST ARCH. (APRIL 19,2023)	EN	
		RELOCATED GAS METER & UPDATED BUILDING FOOTPRINT	EN	
No.	Date	DESCRIPTION	BY	

NOTES:

- Please check and verify all dimensions and conditions on the project and immediately report any discrepancies to the designer before proceeding with the work.

- Do not scale drawings.

- The contractor is to be aware of all existing and proposed services and utilities. The contractor shall check all underground services and utilities staked by each appropriate agency having jurisdiction prior to

check all underground services and utilities. The contractor shall check all underground services and utilities staked by each appropriate agency having jurisdiction prior to commencing with the work.

- All planting is to meet horticultural standards of the CNTA Guide Specification for nursery stock. All plants material is to be No. 1 Grade.

- No plant substitutions will be permitted without the approval of the designer.

- Planting soil mixture will consist of 5 parts sandy loam topsoil; 1 part well rotted cattle manure; and 1 part peat

moss.
All shrubs to be planted in continuous beds.
Sod shall be No. 1 cultivated turf grass, grown in accordance with the classifications of the Nursery Sod Growers Association of Ontario.
All excavations shall be kept away from the drip line of

- Slopes with grass do not exceed 3:1
- This drawing is an instrument of services only and shall remain the property of the designer at all times. Any persons using these drawings for the purposes of construction without the expressed written consent of the designer, shall be prosecuted to the fullest extent of the law.

PREPARED BY:



2189 Hixon St., Oakville, Ont. Canada Telephone 416.898.5965 gary@uncommonground.ca www.uncommonground.ca

PREPARED FOR:

NORTH:



PROJECT TITLE:

DATE:

78-80-82 TRAFALGAR RD.
SHEET DESCRIPTION:


LANDSCAPE PLAN

2022-08-04	2024-07-04
PROJECT NUMBER: 13-0010C	DRAWN BY: EN
SCALE: 1:100	CHECKED BY: GV

ISSUED:

SHEET NUMBER

R6-13-0010C\_78-80-82 TrafalgarRd.\_04.07.24\_EN.vwx

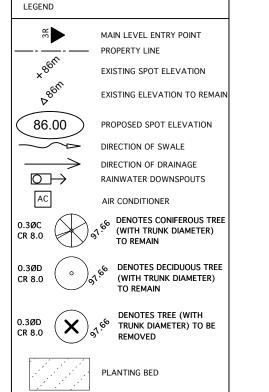

312 S12

자 자 자 가 가 SOD

PROPOSED 6'6" CEDAR FENCE

WATER METER

GAS METER
(AS PER APRIL 19, 2023 ARCHITECTURAL)

EXTERIOR LIGHTING SCHEDULE

POT LIGHT (GARAGE)

WALL MOUNTED LANTERN

CANISTER WALL MOUNTED LIGHT
UP & DOWN

CEILING MOUNTED LANTERN

LANDSCAPE ADJUSTABLE FLOOD LIGHT
(UP TO THE BUILDING)

LANDSCAPE BALLARD 360

LANTERN ON METAL POST

WALL MOUNTED CANISTER
(DOWN)

EXTERIOR LIGHTING NOTE:

"ALL LIGHTING DEVICES SHALL BE
FULL CUT OFF AND NIGHT SKY
FRIENDLY, AND SHALL BE MITIGATED
AT THE SOURCE SO THAT NO LIGHT
(0.0 fc) WILL BE DIRECTLY PROJECTED
ONTO ADJACENT PROPERTIES"

SUBMITTED FOR APPROVAL

T DUGHT

DUGHT


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LEGEND TREE PROTECTION PLAN Hoarding denotes high visibility snow Mid Point Grade fence installed as per Town Standard. F.F. Finished Floor GWGuy Wire X Denotes tree to be removed Utility Pole DEC. Deciduous Removals Diameter TOC 3 Globe Maples 24 cm DBH BOCBottom of Curb 1 Norway Maple 20 cm. DBH 1 Silver Maple 70.38 cm DBH Board Fence CBCatch Basin Pruning Maintenance Hole Over head Wire 1 Norway Maple 33 cm DBH 1 Locust 28.34 cm DBH Water Valve 1 Norway Maple 35.03 cm DBH Protect Water meter 1 Red Oak 100cm DBH

REFERENCE BEARING

Bearings are Astronomic and are Referred to the Southwesterly limit of Robinson Street being N 39' 05' 00" E as shown on Reg'd Plan 1.

Distance shown on this plan are in metric and can be converted to feet by dividing by 0.3048. **BENCHMARK** 

Elevations are Geodetic and are Referred to the Town of Oakville Benchmark 88.537 m. No. 85 having an Elevation of

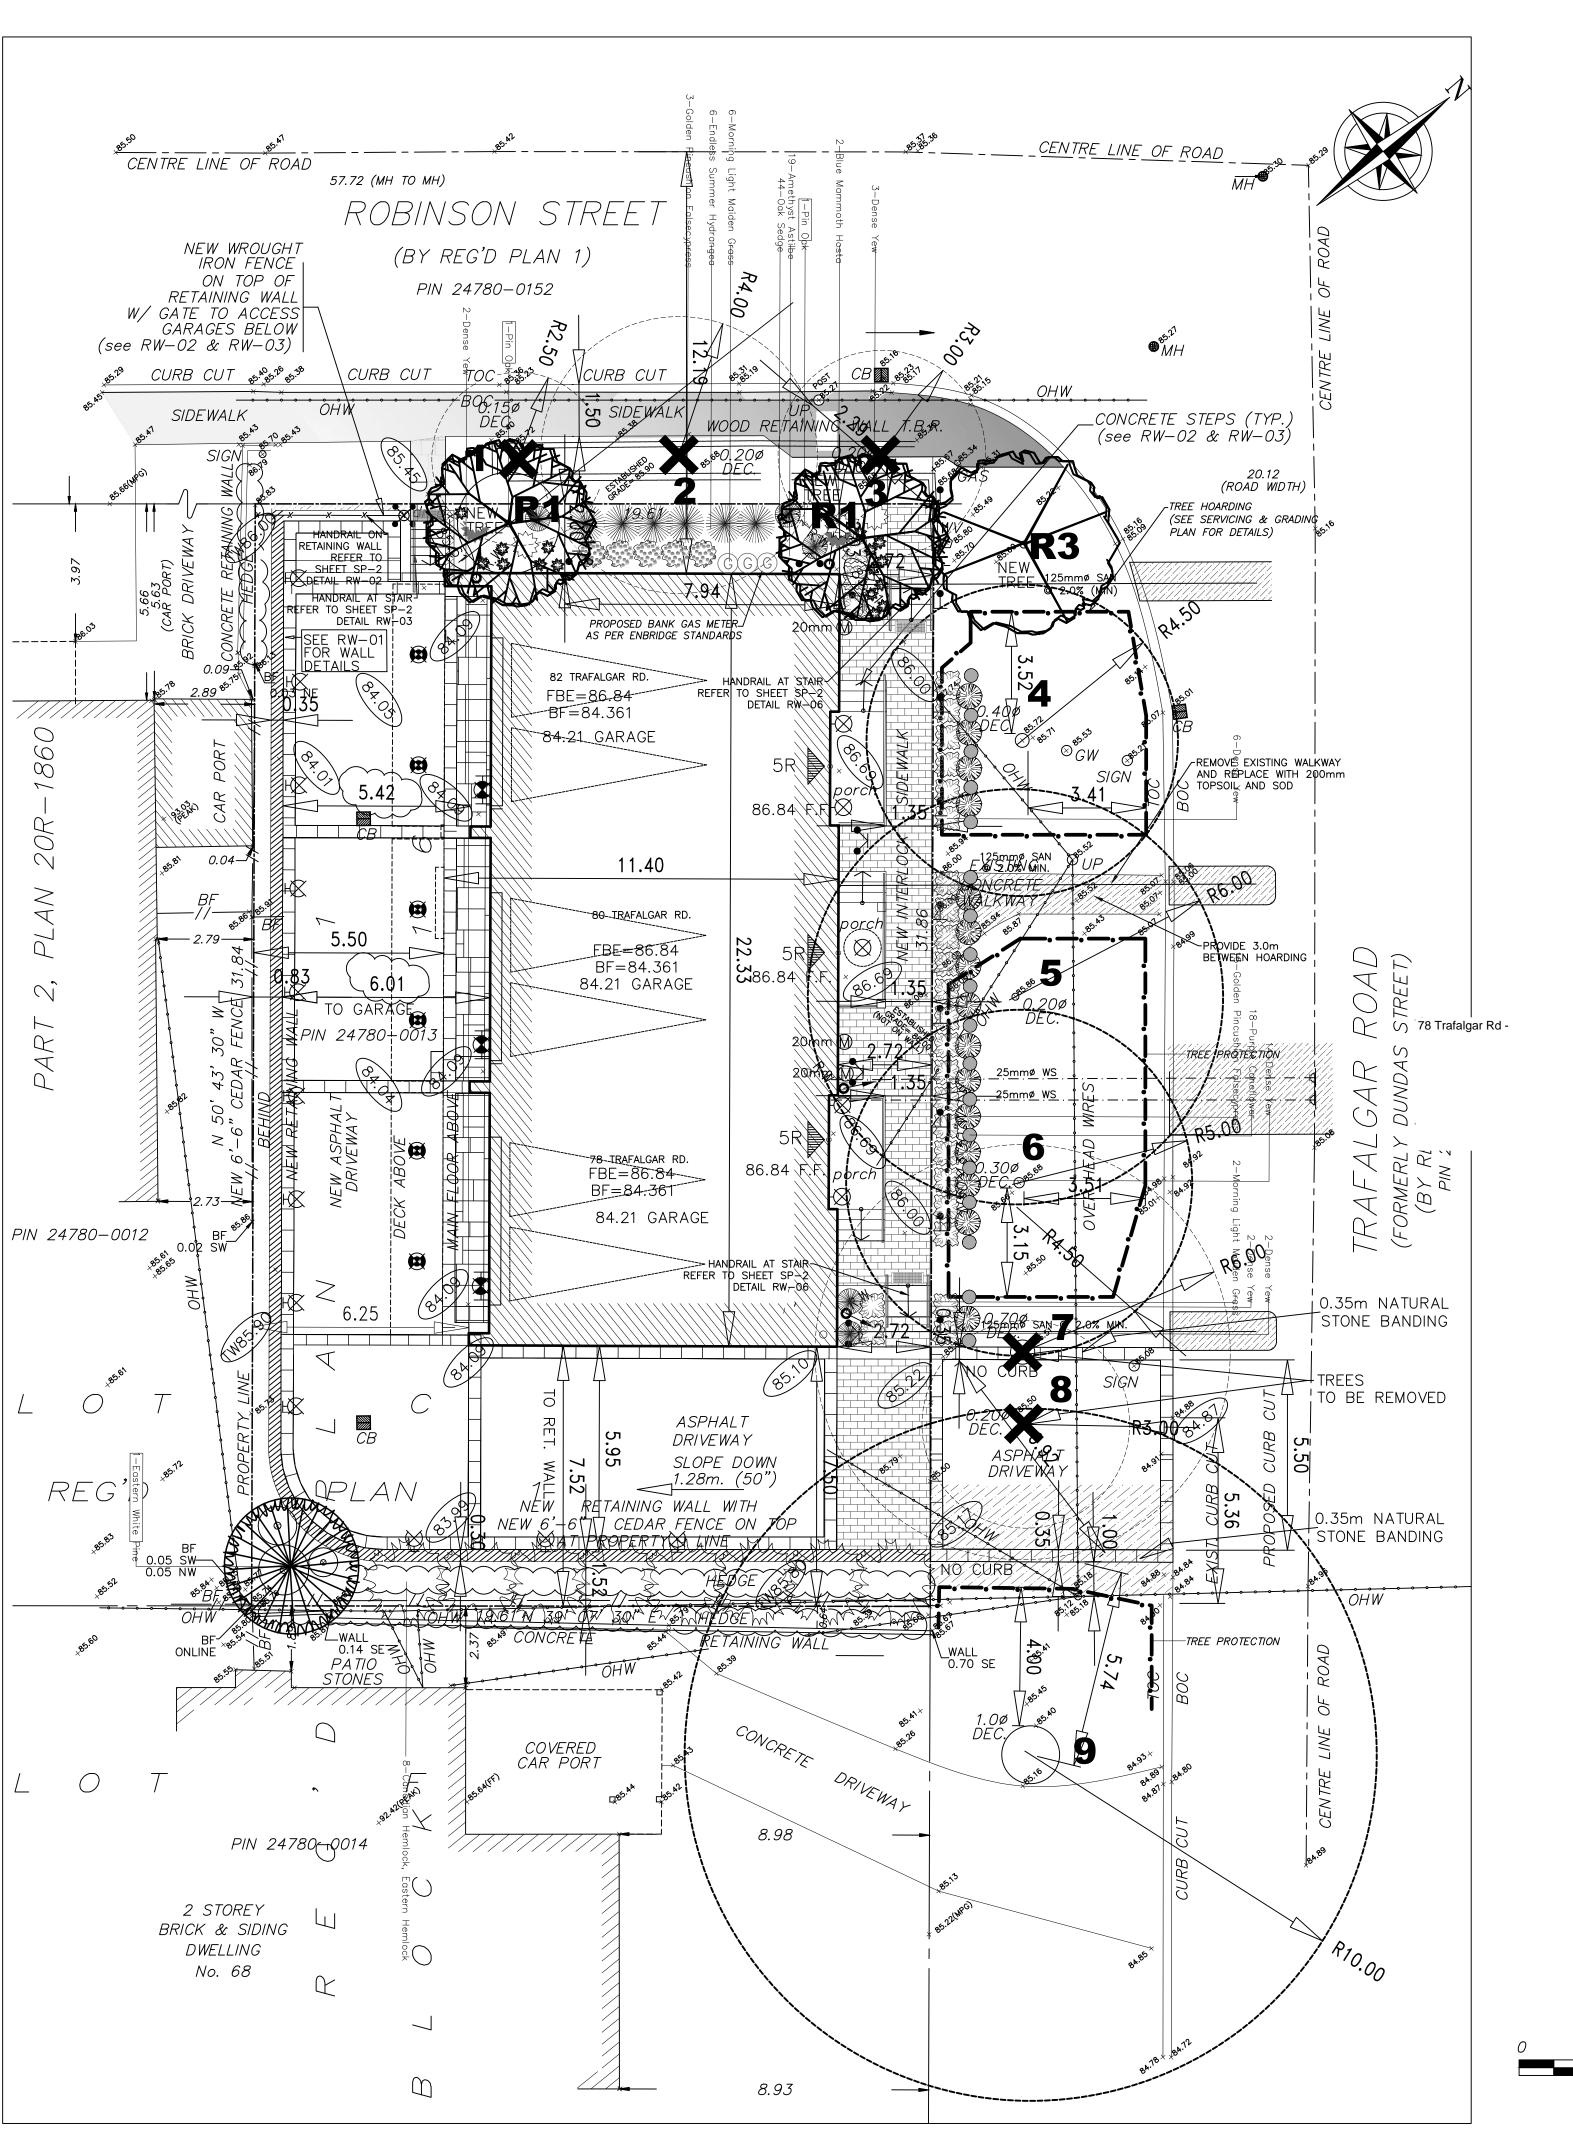Topographic Survey completed on the 25th day of June, 2009.

Topographic Survey up-dated on October 21, 2010. Updated Topographic Survey on June 6, 2013.

NOTE: RETAINING WALL DETAIL REFER TO SHEET SP-2 DETAIL RW-01

HANDRAIL ON RETAINING WALL REFER TO SHEET SP-2 DETAIL RW-02

NOTE: HANDRAIL AT STAIR REFER TO SHEET SP-2 DETAIL RW-03

NOTE: CEDAR FENCE DETAIL REFER TO SHEET SP-2 DETAIL RW-05

THIS DRAWING TO BE READ IN CONJUCTION WITH UNCOMMON GROUND LANDSCAPE DESIGN & OUTDOOR LIVING

NOTE: OAKVILLE HYDRO ANY RESULTING CONFLICTS WITH EXISTING HYDRO FACILITIES DUE TO CONSTRUCTION ARE TO BE REFLECTED AT THE OWNERS EXPENSE

NOTE: FOR TREE #9 NO CURB TO BE INSTALLED & ALL EXCAVATION IN THIS AREA SHALL BE AIR-SPADE OR SIMILAR UNDER DIRECTION OF THE OF THE PROJECT ARBORIST

NOTE: FOR TREE #4 & 6 EXCAVATION WITHIN THE TPZ SHALL BE COMPLETED USING USING AIR-SPADE/DRY-VAC TECHNOLOGY, UNDER SUPERVISION OF THE PROJECT ARBORIST

THIS DRAWING TO BE READ IN CONJUCTION WITH TRAFALGAR ENGINEERING LTD. SERVICING & GRADING PLAN

NOTE: MUNICIPAL BOULEVARD WILL BE RESTORED TO THE SATISFACTION OF TOWN OF OAKVILLE ENGINEERING & TRANSPORTATION

TOWN OF OAKVILLE (REGIONAL MUNICIPALITY OF HALTON) INFORMATION TAKEN FROM A SURVEY PREPARED BY: J.H. GELBLOOM SURVEYING LTD. ONTARIO LAND SURVEYORS DISTANCES SHOWN ON THIS PLAN ARE IN METRES AND CAN BE CONVERTED TO FEET BY DIVIDING BY SITE LEGEND:

20 | 05.07.24 | LANDSCAPE LAYOUT 19 | 18.06.24 | GAS METERS RELOCATED 18 | 09.06.23 | HEATED DRIVEWAY REMOVED

EXTERIOR LIGHTING SCHEDULE

No. Date Revision/Issue

POT LIGHT (GARAGE) WALL MOUNTED LANTERN CANISTER WALL MOUNTED LIGHT UP & DOWN ( 🚫 ) CEILING MOUNTED LANTERN

LANDSCAPE ADJUSTABLE FLOOD LIGHT (UP TO THE BUILDING)

LANDSCAPE BALLARD 360 LANTERN ON METAL POST

**EXTERIOR LIGHTING NOTE:** 

WALL MOUNTED CANISTER (DOWN)

"ALL LIGHTING DEVICES SHALL BE FULL CUT OFF AND NIGHT SKY FRIENDLY, AND SHALL BE MITIGATED AT THE SOURCE SO THAT NO LIGHT (0.0 fc) WILL BE DIRECTLY PROJECTED ONTO ADJACENT PROPERTIES"

PROPERTY LINE EXISTING GRADE FINISHED GRADE FINISHED FLOOR ELEVATION FINISHED BASEMENT ELEVATION TOP OF FOUNDATION WALL T.F.W. F.P.E. FINISHED PORCH ELEVATION MAIN ENTRANCE SECONDARY ENTRANCE EXISTING BUILDING OUTLINE OF EXISTING STRUCTURES TREE HOARDING EXISTING TREE TO REMAIN EXISTING TREE TO BE REMOVED 17 | 19.04.23 | BANK METER LOCATION 16 | 03.30.23 | BANK METER LOCATION 15 | 01.31.23 | BANK METER LOCATION 14 | 10.09.22 | AS PER CITY COMMENTS 13 | 09.28.22 | AS PER CITY COMMENTS 2 | 09.03.15 | AS PER CITY COMMENTS 05.0315 | REVISED DRIVEWAY WIDTH 0 | 10.0215 | REVISED DRIVEWAY WIDTH 28.05.14 REVISED 8 | 14.05.14 | REVISED FOR SPA 05.03.14 REVISED FOR SPA 6 03.02.14 REVISED FOR SPA 5 | 10.01.14 | REVISED FOR SPA 4 | 11.11.13 | REVISED FOR SPA 24.09.13 REVISED FOR SPA 10.08.13 REVISED FOR SPA 25.06.13 ISSUED FOR SPA APPLICATION Revision/Issue

THE ARCHITECT / DESIGNER IS NOT RESPONSIBLE

MECHANICAL, ELECTRICAL OR ANY ENGINEERING INFORMATION SHOWN ON THE DRAWING. REFER TO

FOR THE ACCURACY OF SURVEY, STRUCTURAL,

THE APPROPRIATE ENGINEERING DRAWINGS

BEFORE PROCEEDING WITH THE WORK.

CONSTRUCTION MUST CONFORM TO ALL APPLICABLE CODES AND REQUIREMENTS OF

**AUTHORITIES HAVING JURISDICTION.** 

THIS DRAWING IS NOT TO BE SCALED.

SITE ACCREDITATION:

PART OF LOT C, BLOCK 16

OMISSIONS TO THE ARCHITECT.

REGISTERED PLAN 1

PLAN OF TOPOGRAPHY OF

BEFORE PROCEEDING WITH THE WORK, REPORT

ANY DISCREPANCIES BETWEEN ARCHITECTURAL

AND ENGINEERING DRAWINGS TO THE ARCHITECT

**GENERAL CONTRACTOR SHALL CHECK AND VERIFY** 

ALL DIMENSIONS AND REPORT ALL ERRORS AND

# SITE STATISTICS -ZONE RM1sp:50

1. LOT AREA = 135.0 m2/UNIT (624.57 m2 TOTAL)

2. LOT FRONTAGE = 31.86m (30.50m Minimum). 3. AREAS FOR COVERAGE = 247.3 m2. (A) EX. MAIN DWELLING = 247.3 m2;

- 4. LOT COVERAGE = 40% (40.0% Maximum).
- 5. ESTABLISHED GRADE = 85.95m. 6. BUILDING HEIGHTS:
- ROOF RIDGE = 12.97m (12.0m Maximum); 7. SETBACKS:
- FRONT = 1.35m (4.50m Minimum); - FLANKAGE = 2.72m (3.00m Minimum);
- REAR = 5.50m (6.00m Minimum); SIDES: 7.50m (1.20m Minimum);
- 8. FLOOR AREA = 711.35 m2.
- UNIT-1 FLOOR AREA = 238.20 m2. UNIT-2 FLOOR AREA = 241.08 m2. UNIT-3 FLOOR AREA =232.07 m2.
- 9. FA/LOT RATIO =114.8% (42% Maximum)

Project Name and Address

78-80-82 TRAFALGAR RD. OAKVILLE, ON. (PROPOSED 78, 80 & 82 TRAFALGAR RD.)

DESIGNS INC.


ARCHITECTURAL DESIGN CONSULTANT

BLOOR STREET, MISSISSAUGA, ONTARIO

(416) 655-0245 email: jrcpdesigns@yahoo.ca www. jrcpdesigns.com

DRAWING TITLE

SITE PLAN & TREE PROTECTION PLAN S.P.1713.040/02

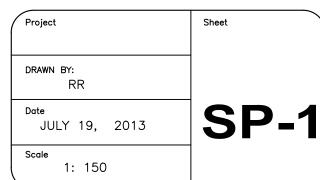

15Metres SCALE 1 : 150

#### **Sebastian Alzamora**

From: Kelly Lanaus <kelly.lanaus@oakville.ca>

**Sent:** June 6, 2024 1:06 PM

**To:** Sebastian Alzamora; Brandon Hassan; Timothy Lee

**Cc:** Sarah Clark; Leigh Musson

Subject:RE: 78 Trafalgar - Minor VarianceAttachments:03\_CondoPlan\_v1\_2024-02-26.pdf

Hello Sebastian

Thank you for your patients as we discussed this with our legal department.


In these discussions, and considering the property in question, along with the Final CAV decision, we are now recommending that you would actually need to seek relief from section 6.10 c) of bylaw 2014 and applying section 6.10 b)

Seeking relief of the bylaw would rectify any issues with frontage and thus relief would not be required from section 4.13.

The decks are currently shown as part of the condo plan, that is of course why we were asking about them. If it is exclusive to each owner then you need to change the lines on the condo plan to something similar to the red line below.

Next steps would be to submit your application so we can do a full review and identify any further issues.

Thank you, Kelly

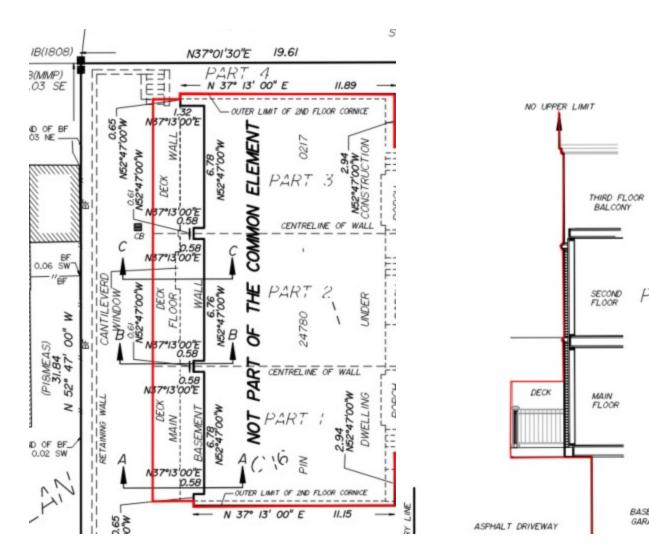

Kelly Lanaus, CPT Senior Zoning Plans Examiner Building Services

Town of Oakville | 905-845-6601, ext. 3036 | f: 905-338-4230 | www.oakville.ca

#### Vision: A vibrant and livable community for all

Please consider the environment before printing this email. http://www.oakville.ca/privacy.html

From: Sebastian Alzamora <SebastianA@gsai.ca>

Sent: Thursday, June 6, 2024 12:49 PM

To: Brandon Hassan <bra> brandon.hassan@oakville.ca>; Kelly Lanaus <kelly.lanaus@oakville.ca>; Timothy Lee

<timothy.lee@oakville.ca>

Cc: Sarah Clark <sarahc@gsai.ca>; Leigh Musson <leigh.musson@oakville.ca>

Subject: RE: 78 Trafalgar - Minor Variance

Thanks Brandon.

@Kelly Lanaus @Timothy Lee - can you please advise?

Sebastian Alzamora, MCIP, RPP | Planner

700 - 10 Kingsbridge Garden Circle Mississauga, ON L5R 3K6 C: 416 419-8862

C: 416 419-886 www.gsai.ca