

1 SITE PLAN A-000 3/32" = 1'-0"

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1	ISSUED FOR COMMITTEE OF	2024-0
	ADJUSTMENT	
2	ISSUED FOR PRICING	2024-0
3	REISSUED FOR COMMITTEE OF	2024-0
	ADJUSTMENT	

## PRIVATE RESIDENCE

216 Forestwood Drive, Oakville, ON



95 St. Clair Avenue West, Suite 306, Toronto, ON, CANADA, M4V 1N7

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Professional Seals

Original is 36" x 24" Do not scale contents of this drawing. Sheet Number

A-400

ID-1

**CABANA PLANS** 


CABANA ELEVATIONS

INTERIOR RENDERING

**Date** 2024-07-19 12:29:01 PM Sheet Title

SITE PLAN & DRAWING LIST

Dwg. File Name **Scale** 3/32" = 1'-0" Drawn Checked

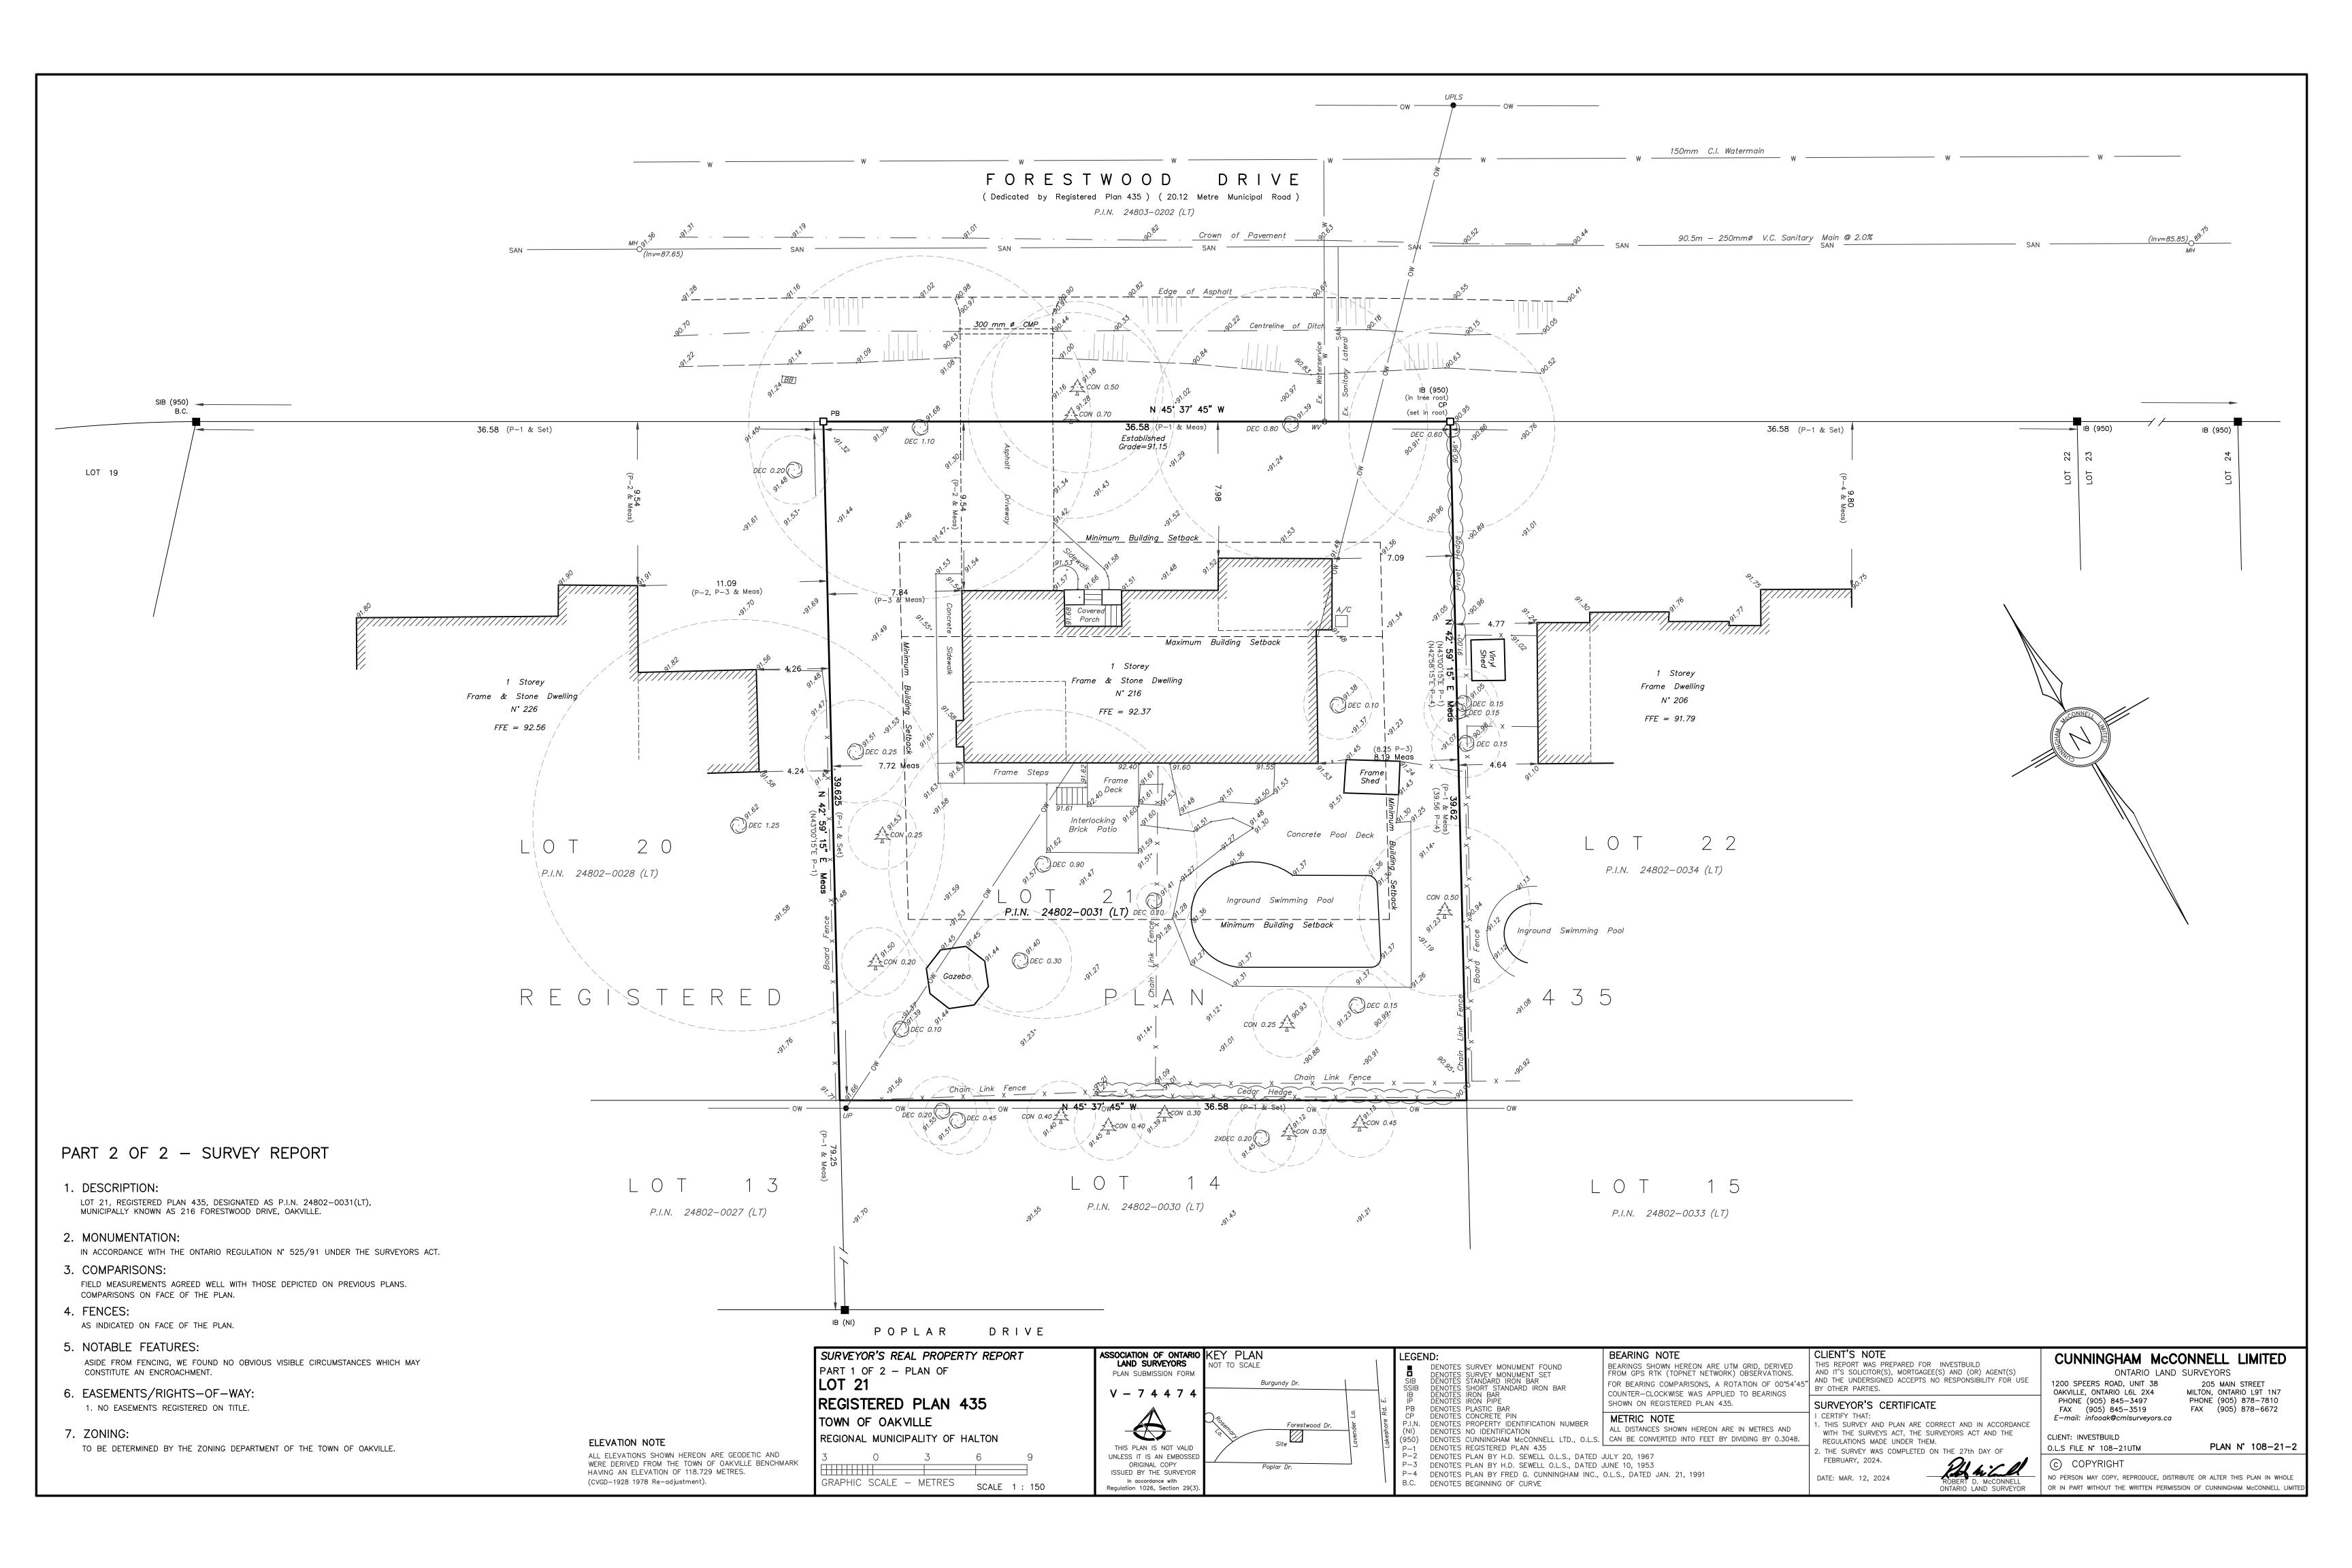



1 ISSUED FOR COMMITTEE OF ADJUSTMENT

2024-03-26

2	ISSUED FOR PRICING	2024-05-1
3	REISSUED FOR COMMITTEE OF ADJUSTMENT	2024-07-1

Project
PRIVATE RESIDENCE

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Professional Seals

Date 2024-07-19 11:59:34 AM
Sheet Title

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REAR ELEVATION

Dwg. File Name

\\MAKOWDC\Company Data\Makow\Drawings\Active\216
Forest Wood\A-A\Revit\216 Forestwood Drive 5 - Reduced
Size\_no dormers.rvt

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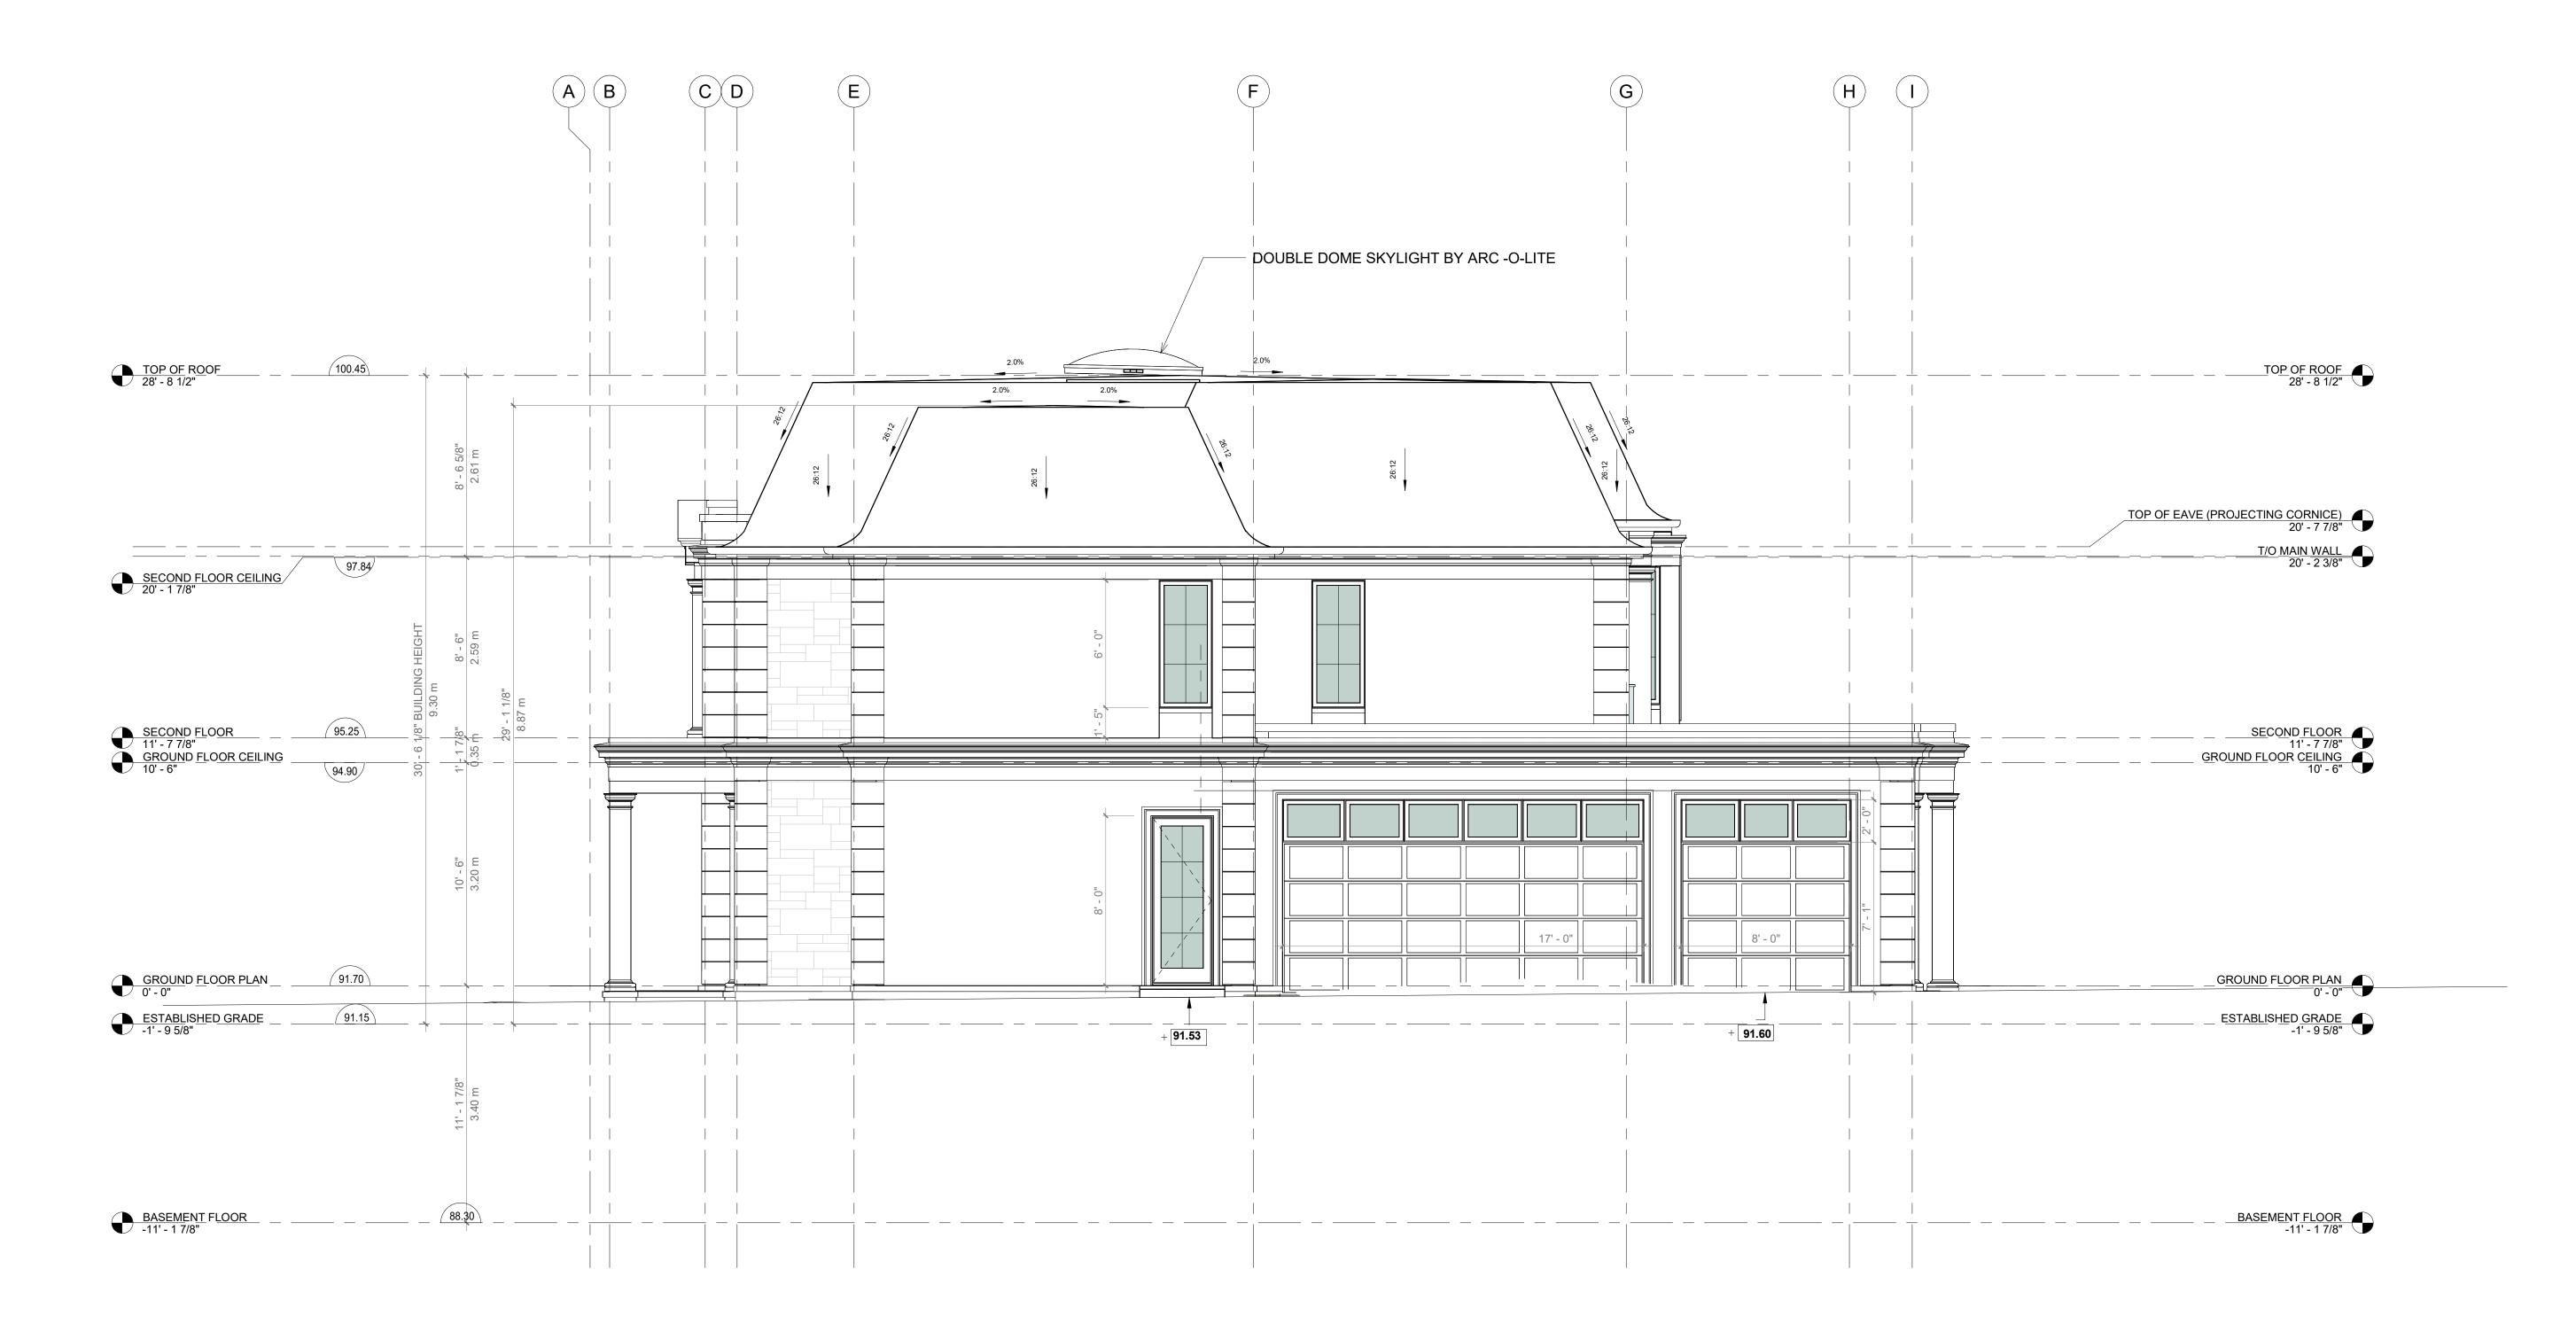
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Original is 36" x 24"
Do not scale contents of this drawing.

Author Checker

Sheet Number

A-201



ADJUSTMENT 2 ISSUED FOR PRICING 2	ADJUSTMENT	20
3 REISSUED FOR COMMITTEE OF 2		
3 REISSUED FOR COMMITTEE OF 2 ADJUSTMENT	ISSUED FOR PRICING	20
	REISSUED FOR COMMITTEE OF ADJUSTMENT	20

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**Date** 2024-07-19 11:59:36 AM

SIDE NORTH WEST **ELEVATION** 

Dwg. File Name
\\MAKOWDC\Company Data\Makow\Drawings\Active\216
Forest Wood\A-A\Revit\216 Forestwood Drive 5 - Reduced
Size\_no dormers.rvt Scale 1/4" = 1'-0"

Original is 36" x 24"

Do not scale contents of this drawing. Sheet Number

Author Checker



1	ISSUED FOR COMMITTEE OF	2024-03-2
	ADJUSTMENT	
2	ISSUED FOR PRICING	2024-05-
3	REISSUED FOR COMMITTEE OF	2024-07-
	ADJUSTMENT	
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# PRIVATE RESIDENCE

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**Date** 2024-07-19 11:59:37 AM Sheet Title

### SIDE SOUTH EAST **ELEVATION**

Dwg. File Name
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Forest Wood\A-A\Revit\216 Forestwood Drive 5 - Reduced
Size\_no dormers.rvt Scale 1/4" = 1'-0" Drawn Checked Original is 36" x 24"
Do not scale contents of this drawing.

Sheet Number



1	ISSUED FOR COMMITTEE OF ADJUSTMENT	2024-03-2
2	ISSUED FOR PRICING	2024-05-1
3		2024-07-1
_	ADJUSTMENT	

2024-03-26

## PRIVATE RESIDENCE

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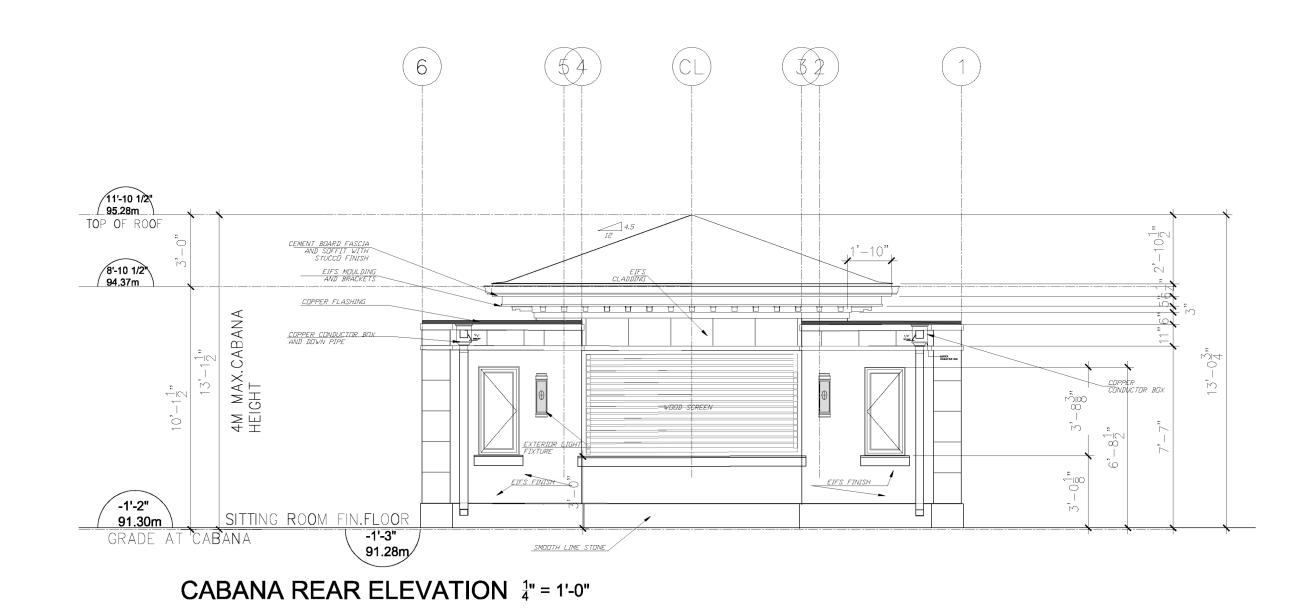
Professional Seals


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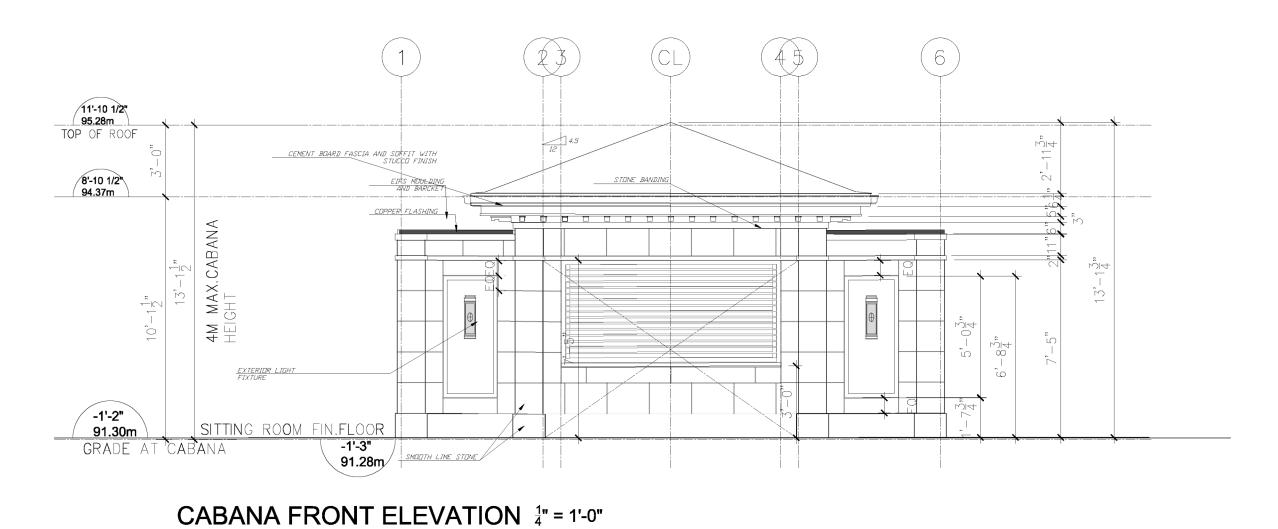
FRONT ELEVATION


Dwg. File Name
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Forest Wood\A-A\Revit\216 Forestwood Drive 5 - Reduced
Size\_no dormers.rvt Scale 1/4" = 1'-0"

Original is 36" x 24"
Do not scale contents of this drawing. Sheet Number





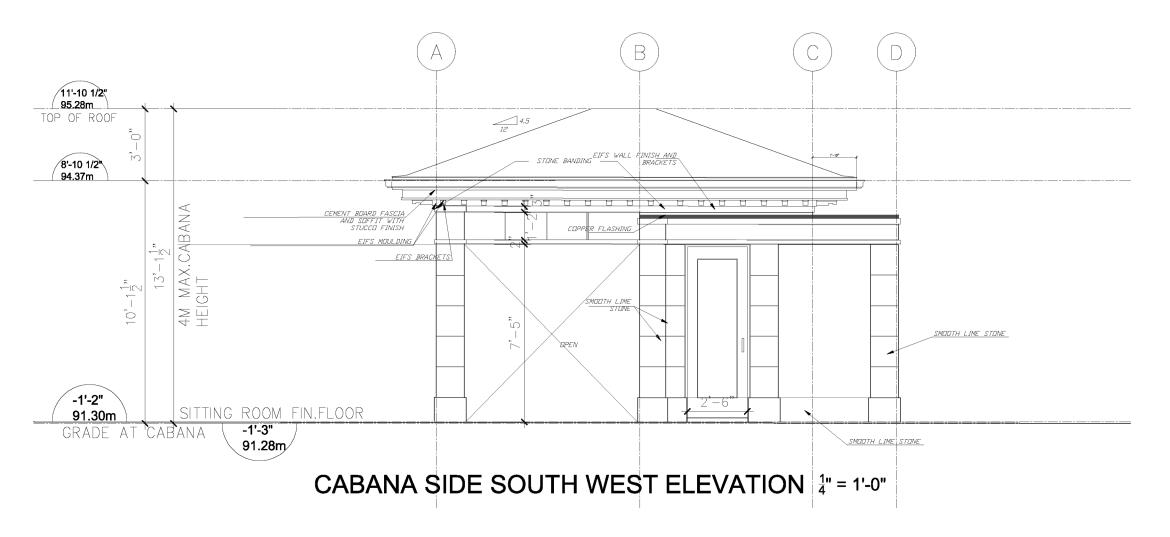

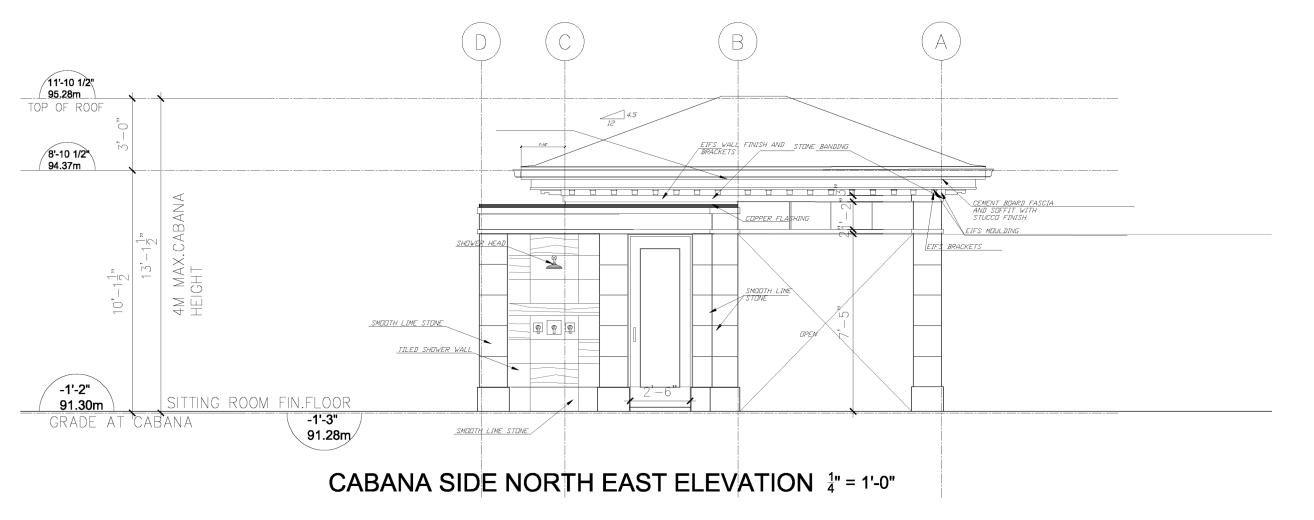

ADJUSTMENT 2 ISSUED FOR PRICING 2024-05-1 3 REISSUED FOR COMMITTEE OF 2024-07-1 ADJUSTMENT	1	ISSUED FOR COMMITTEE OF ADJUSTMENT	2024-03-26
3 REISSUED FOR COMMITTEE OF 2024-07-1			
	3		2024-07-19
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Project
PRIVATE RESIDENCE

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Project No.

Professional Seals

 Date
 2024-07-19 11:59:39 AM

 Sheet Title

CABANA ELEVATIONS

Dwg. File Name


\\MAKOWDC\Company Data\\Makow\Drawings\Active\216
Forest Wood\A-A\Revit\216 Forestwood Drive 5 - Reduced
Size\_no dormers.rvt
Scale 1/4" = 1'-0" Drawn Checked

Original is 36" x 24"
Do not scale contents of this drawing.

Sheet Number

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Author Checker

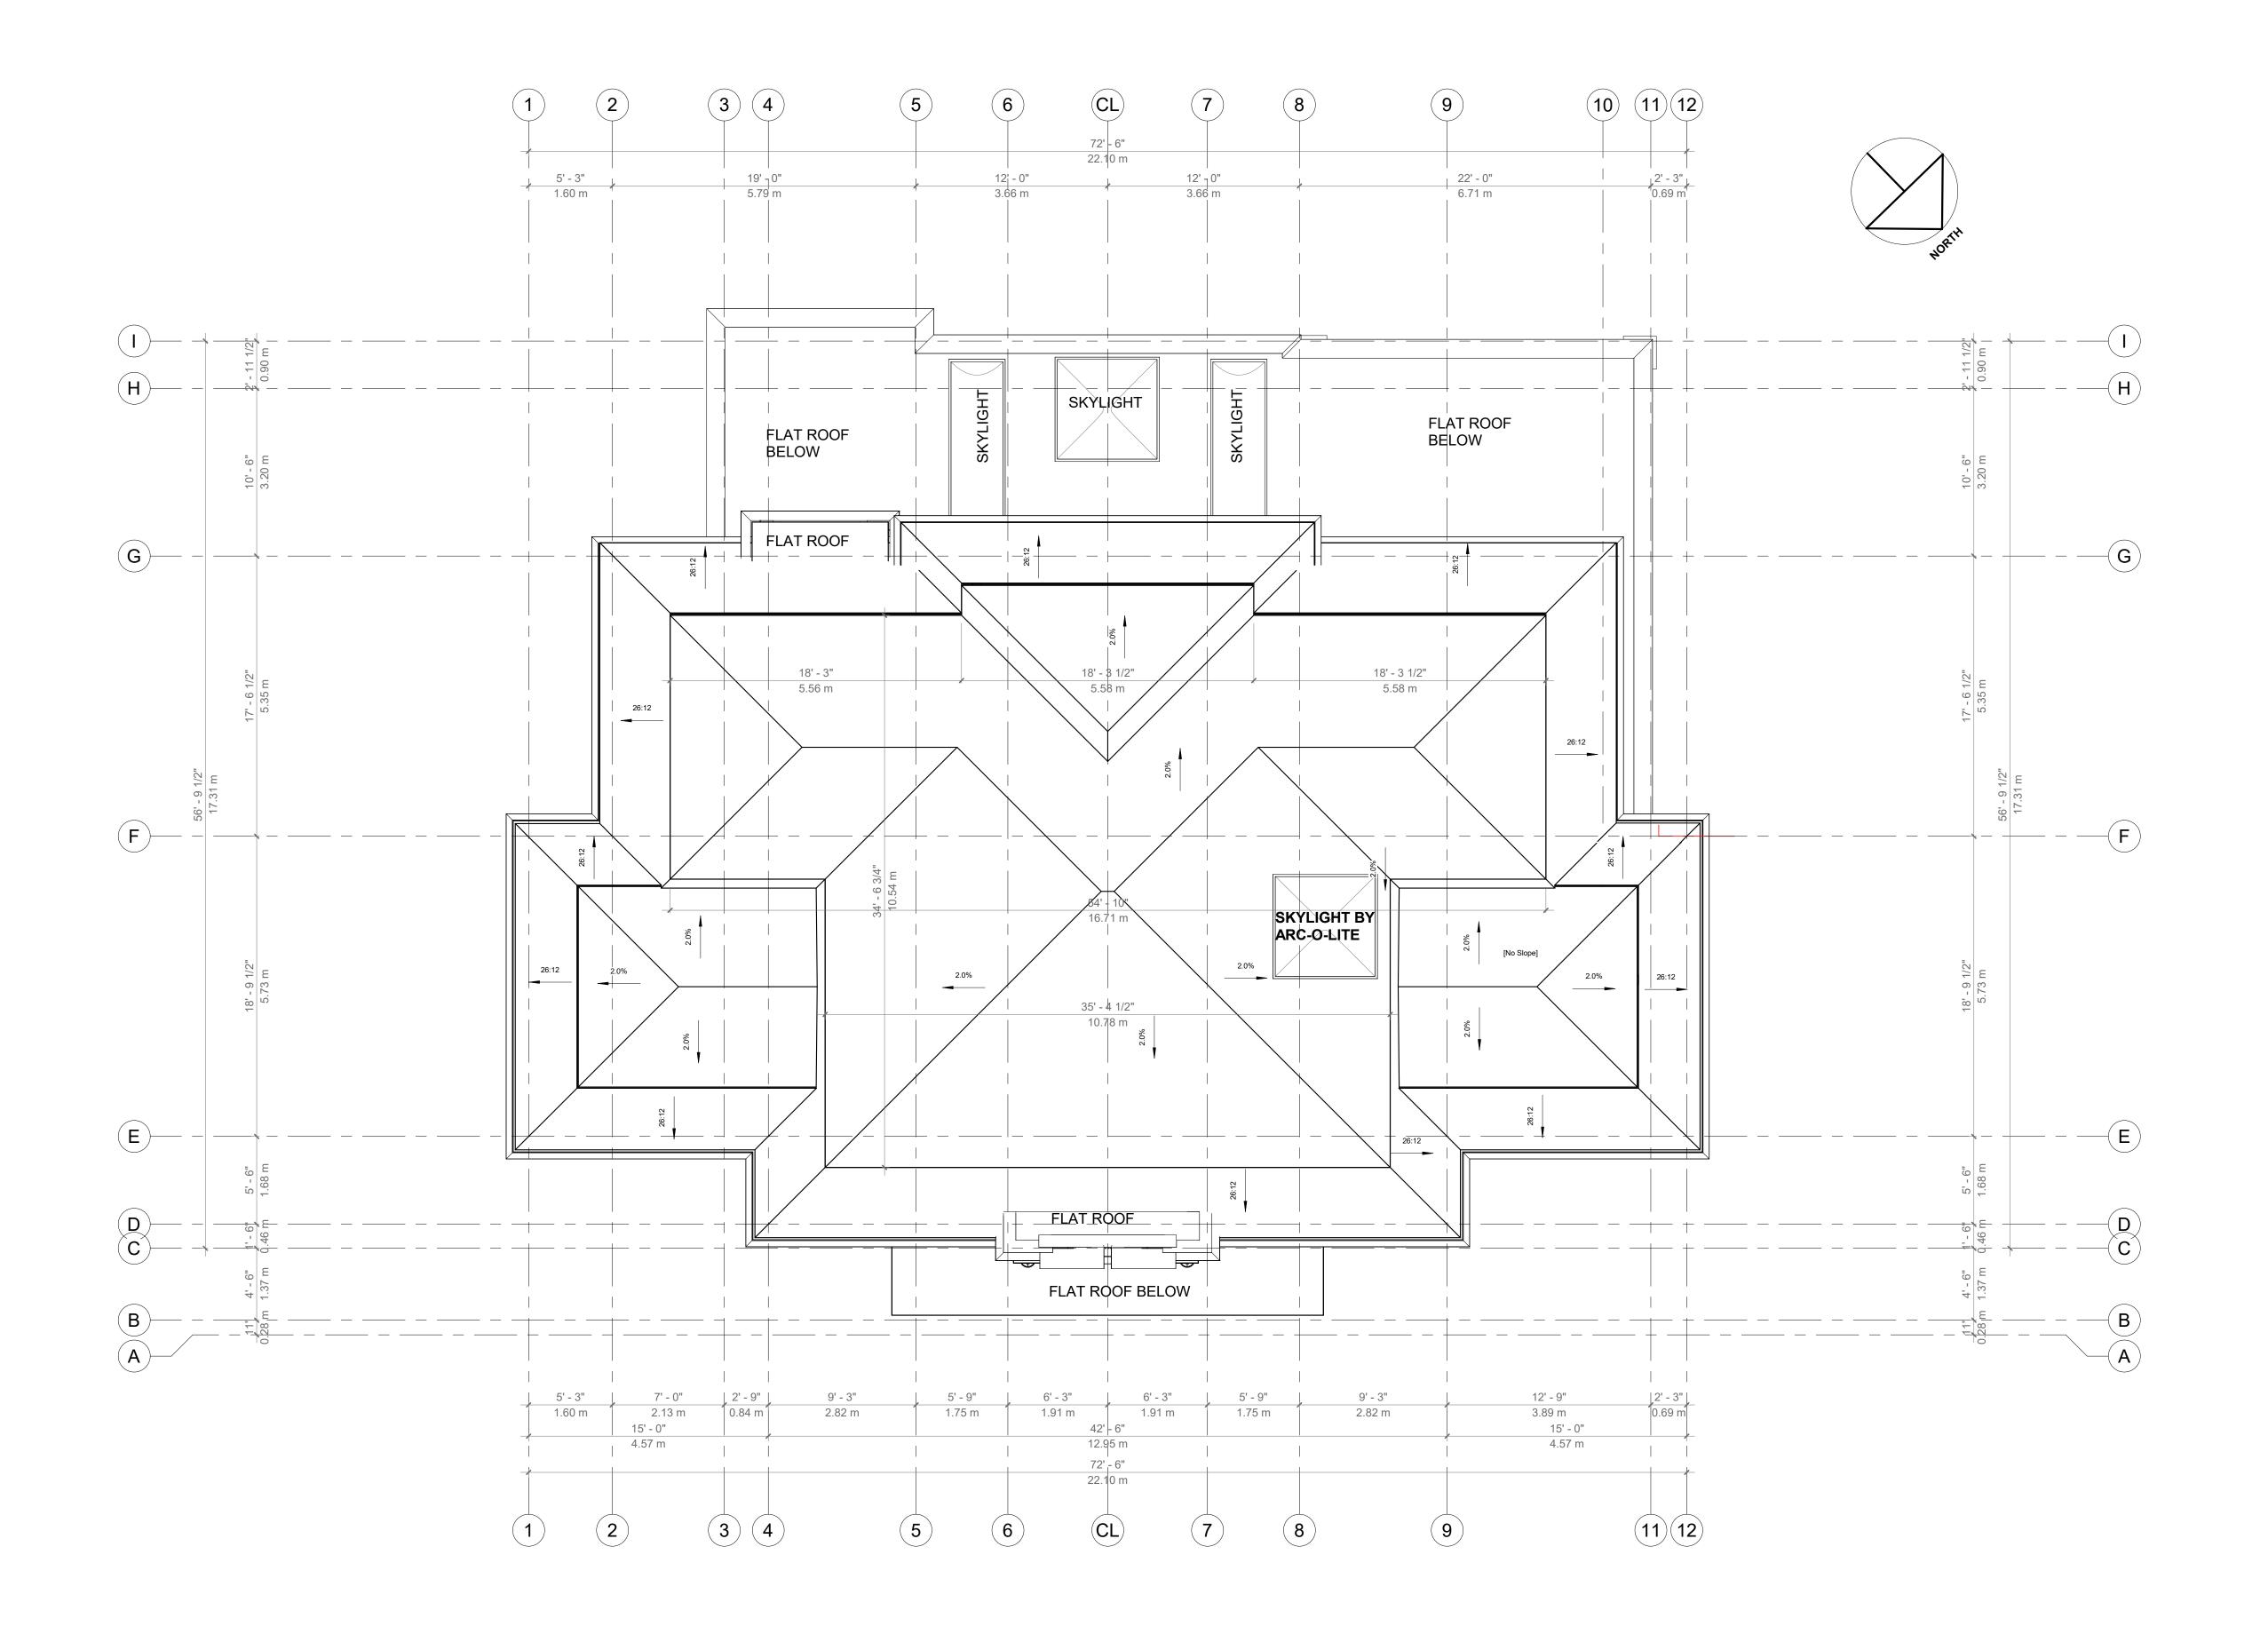

1	ISSUED FOR COMMITTEE OF ADJUSTMENT	2024-03-2
2	ISSUED FOR PRICING	2024-05-1
3	REISSUED FOR COMMITTEE OF ADJUSTMENT	2024-07-1
	ADJUSTMENT	

Project
PRIVATE RESIDENCE

216 Forestwood Drive, Oakville, ON



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Professional Seals

Date 2024-07-19 11:59:32 AM
Sheet Title

206

**ROOF PLAN** 

Dwg. File Name

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\MAKOWDC\Company Data\Makow\Drawings\Active\216
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Forest Wood\A-A\Revit\216 Forestwood Drive 5 - Reduced
Size\_no dormers.rvt

Scale 3/16" = 1'-0" Drawn Checked

Original is 36" x 24"
Do not scale contents of this drawing.

Sheet Number

A-104

July 02, 2024

Committee of Adjustment Town of Oakville 1225 Trafalgar Road Oakville, ON L6H 0H3

via email: coarequests@oakville.ca

Re: 216 Forestwood Drive, Minor Variance Application

According to our analysis, the variances requested area:

#### 6.4.6 c)

Whereas, the maximum height shall be 9.0 meters. The height of the proposed house is 9.30 meters.

#### 6.4.1. d)

Whereas, for a detached dwelling on a lot with an area between 1,301m<sup>2</sup> or greater the maximum Residential Floor Area Ratio shall be 29.0% (419.7m<sup>2</sup>), the Floor area ratio of the proposed house is 32.70% (473.18m<sup>2</sup>)

#### 4.3 and Table 4.3 Row 7

Whereas window wells with a maximum width of 1.8 meters are allowed to project up to 0.6m into a minimum yard, the proposed window well on the South side of the house is 5.78m wide and projects 2.4m into the minimum side yard.

#### 4.3 and Table 4.3 Row 18

Whereas uncovered stairs below grade are not allowed to project into a minimum yard, and only may project 1.5m beyond the main wall, the proposed stairs on the South side of the house is 4.0m beyond the main wall and projects 2.4 m into the minimum side yard.

Please feel free to contact me at 647-291-5335 or via email at <a href="mailto:jim@makowarchtiects.com">jim@makowarchtiects.com</a> if you have any questions about the above.

Thank you,

Jim Pfeffer, OAA

95 St Clair Avenue West Suite 306 Toronto, Ontario Canada M4V 1N7

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- w makowarchitectscom

July 24, 2024

Committee of Adjustment Town of Oakville 1225 Trafalgar Road Oakville, ON L6H 0H3

via email: coarequests@oakville.ca

Re: 261 Forestwood Drive, Minor Variance Application

Good Day -

A proposal for this lot was approved by the Committee of Adjustment in July of 2022, approving an RGFA of 31.49%, Lot Coverage of 26.08%, a height of 9.3m and a accessory building (garage) height of 4.98m. Subsequently, as new architects for the owners, we presented a wholly revised plan to the Committee in May of this year. That proposal, which was refused by the committee, was for an RGFA of 33.7%, a height of 9.59m, two rear balconies, and for the projection of a below grade window well, walk out and stairs into a side yard.

We have prepared a revised proposal which addresses <u>all</u> of the concerns raised by staff and members of the committee at the prior hearing. This includes removing the request for balconies.

The remaining variances for the proposed home, some reduced, are minor in nature, desirable for the appropriate development of this lot, and in keeping with the intent of the zoning by-law and the official Plan.

#### **Side Yard Projections, Encroachments**

Three of the variances are for the projection into the rear yard of entirely below ground elements — a window well, and a walk out stairwell. Being below the level of the ground, these have no impact on the streetscape or neighbouring properties, and they still have a 1.8m setback from an otherwise soft landscaped side yard, a more than adequate amount for drainage, privacy and access. Staff noted in their report:

The intent of regulating window well encroachment, stair encroachment, and stair projection are to allow for adequate drainage and passage through a yard so that they do not impede access and to allow for adequate open space and landscaping. The window well and access stairs are located in the interior side yard, and a minimum interior side yard setback of 1.84m will be maintained. In this case, the window well and stairs lead below grade, allowing for adequate open space and landscaping to be maintained on site. Furthermore, Staff are of the opinion that the window well and stairs along the south elevation will not impede access. It is noted that drainage will continue to be reviewed as part of the building permit submission of detailed engineering plans.

MAKOW ASSOCIATES ARCHITECT INC.

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A neighbour had expressed concerns that the window well would contain a separate seating area. This is not the case, and, as can be seen in the plans, the window and walk out well are not suited to contain a seating area.

#### Height

The prior approval for a height of 9.3m was for a gable roof with a continuous ridge across the main part of the house, and a significant side gable.

This revised proposal only asks for the 9.3m height in the central part of the house, and the sides of the façade step down to the permitted 9.0m height. The proposed roof is a hip roof, sloped from all sides, and is as a whole much less massive and is less imposing than the roof that the committee approved prior. The reason for requesting the height variance is our belief as architects that the roof is an important part of the composition of the façade, and that the requested height has a pleasing proportion to the dwelling.

We reduced the height from the prior application by reducing the height of the entire house, lowering the eave line.

The height is mitigated as well by the generous side yard setbacks. In particular, whereas the proposal previously approved had a substantial westerly gable along the entire side façade, this proposal increases the side yard setback to over 6.0m after a <6m section of wall at the minimum 4.2m side yard setback.

Committee member Hardcastle also expressed concern about the 'three storey presentation of the house' specifically calling attention to the dormers, which we have removed. The removal of these dormers, combined with the stepping of the roof, eliminates any three storey reading of the home.



The proposal has a hip roof sloping away from all sides and has a as-of-right roof height at the side closest to the neighbouring property, and greater setbacks where the roof is higher. The proposal previously approved has large, wide gable at the 9.3m height along the entire side, as well as having a garage on the other property line with a 5.0m height variance.

#### **Floor Space Index**

The prior request was for an FSI of 33.7%, which has been reduced to 32.07%.

We are now seeking an FSI lower than that approved on this street, almost directly across the street at 233 Forest Wood, and lower than that approved at 258 Elton Park, also nearby.

Of 233 Forestwood, city planning said that "The proposed dwelling maintains a similar massing and scale to the existing dwelling and what exists in the neighbourhood... the dwelling provides greater than required side yard setbacks, and does not project into the established rear yards of abutting properties". This proposal has greater side yard setbacks than required except for the first 5.94m of the east side which is at the required setback, and respects the existing rear yard lines of neighbouring homes – certainly more so than the approved proposal for this lot with the 5.0m high garage on the west property line. And our proposed massing and scale is less than the approved design for this lot – and similar to that of many homes in the area.

This home, unlike many homes, does not have a double height space or large void areas, which can increase the volume of a home without increasing the floor area.

The strategies adopted in the massing of this home:

- Projections and recesses in the wall planes of the façade
- Variation in roof form, cascading down towards the side of the home.
- Horizontal Detailing to de-emphasise the massing
- Prominent, horizontal porch of human scale to reduces the verticality of the dwelling and brings focus to the main entrance
- Façade articulation and varied materials, including the horizontal midband, minimize the appearance of height.

are those strategies recommend in the Design Guidelines for Stable Residential Communities for achieving compatible new infill homes.

I trust that reading the above you will agree that the requested variances are minor and compatible with the intent of the official plan and zoning by-law, and that the proposed new home is desirable and appropriate for this property.

Anyone reading the above who has questions can reach me at jim@makowarchitects.com, or on my cell phone, 647-291-5335.

James Pfeffer, OAA for

Makow Associates Architect, Inc