

### GENERAL NOTES:

DRAWINGS ARE TO BE READ NOT SCALED.
CONTRACTOR MUST VERIFY ALL
DIMENSIONS AND BE RESPONSIBLE FOR THE SAME.
REPORT ANY DISCREPANCIES TO THE DESIGN AND SET OF THE EXCLUSIVE PROPERTY OF THE DOCUMENTS PROVIDED IS PROHIBITED WITHOUT THE CONSENT OF THE DESIGN AND CONSTRUCTION OF THE DESIGN AND CONSTRUCTION DOCUMENTATION ARE FINAL UNLESS REVISED BY THE DESIGNER. IF ANY DISCREPANCIES ARE DISCOVERED HERE WITHIN, THE DESIGNER SHALL BE NOTIFIED.



3	REVISION	MAY 24 202					
2	REVISION	MAY 8 2024					
1	ISSUED FOR BUILDING PERMIT	APR 24 202					
NO.	DESCRIPTION	DATE					

#### ENGINEER:



### CONSULTANT:

### PROJECT:

1328 AYMOND CRESCENT DAKVILLE, DN

### SHEET TITLE:

SITE PLAN

CHECKED: MSS DRAWN: MSA SCALE: 1: 100 DATE: APR 24 2024

DRAWING:

A 0.1

SURVEYOR'S REAL PROPERTY REPORT PART 1 PLAN OF LOTS 14, 15, 16, 17 AND 18 PLAN 20M-1253 TOWN OF OAKVILLE REGIONAL MUNICIPALITY OF HALTON

SCALE 1: 300

20metres

R-PE SURVEYING LTD., O.L.S.

METRIC

DISTANCES SHOWN ON THIS PLAN ARE IN METRES AND CAN BE CONVERTED TO FEET BY DIVIDING BY 0.3048.

NOTES

DENOTES MONUMENT FOUND

DENOTES PLASTIC BAR
DENOTES PROPERTY IDENTIFIER NUMBER DENOTES DWELLING UNDER CONSTRUCTION DENOTES PORCH

DENOTES TOP OF WALL ELEVATION

ALL FOUND MONUMENTS BY R-PE SURVEYING LTD., O.L.S. ALL TIES TO CONCRETE FOUNDATION.

BEARINGS ARE GRID AND ARE REFERRED TO THE SOUTHWEST LIMIT OF AYMOND CRESCENT AS SHOWN ON PLAN 20M-1253 HAVING A BEARING OF N5514'05"W. PART 2 (SURVEY REPORT)

REGISTERED EASEMENTS AND/OR RIGHT-OF-WAYS: PART OF LOTS 14, 16 AND 17 DESIGNATED AS PARTS 12, 13 AND 14, PLAN 20R-22276 ARE SUBJECT TO AN EASEMENT IN GROSS AS SET OUT IN INST. No. HR1928342 THIS PLAN DOES NOT CERTIFY COMPLIANCE WITH ZONING BY-LAWS

# SURVEYOR'S CERTIFICATE

I CERTIFY THAT:


- 1. THIS SURVEY AND PLAN ARE CORRECT AND IN ACCORDANCE WITH THE SURVEYS ACT, THE SURVEYORS ACT AND THE LAND TITLES ACT AND THE REGULATIONS MADE UNDER THEM.
- 2. THE SURVEY WAS COMPLETED ON THE 14 DAY OF JANUARY ,2023.

DATE JANUARY 27 , 2023.

J. A. ABRAHAM ONTARIO LAND SURVEYOR



(BY PLAN 20M-1253)

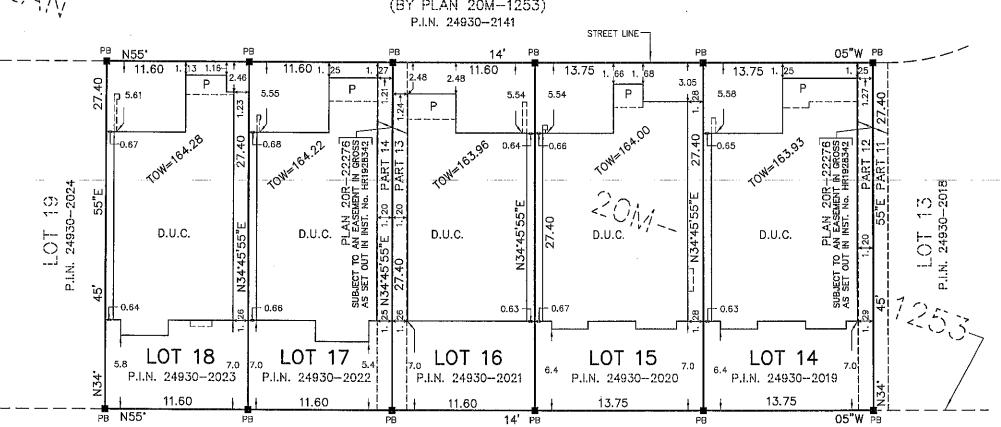

ASSOCIATION OF ONTARIO LAND SURVEYORS PLAN SUBMISSION FORM 2205411

THIS PLAN IS NOT VALID UNLESS IT IS AN EMBOSSED ORIGINAL COPY ISSUED BY THE SURVEYOR In accordance with Regulation 1026, Section 29(3).

20R CONCESSION 1. NORTH OF DUNDAS STREET

PLAN

PART 4,

P.I.N. 24930-2001

22091

R-PE SURVEYING LTD. ONTARIO LAND SURVEYORS

643 Chrislea Road, Suite 7 Woodbridge, Ontario, L4L 8A3 Tel.(416)635-5000 Fax (416)635-5001

Tel.(905)264-0881 Fax (905)264-2099

Website: www.r-pe.ca

DRAWN: V.K. CAD FILE No. 1253-14 CHECKED: I.A.A./T.S. JOB No. 22-312

THIS REPORT WAS PREPARED FOR MATTAMY HOMES AND THE UNDERSIGNED ACCEPTS NO RESPONSIBILITY FOR USE BY OTHER PARTIES

(C)R-PE SURVEYING LTD., O.L.S. 2023.



ROOM FINISHED SCHEDULE - BASEMENT											
	FLOOR		WALL		CEILING						
ROOM NAME	MATERIAL	FINISH	MATERIAL	FINISH	MATERIAL	FINISH	HEIGHT	REMARKS			
LIVING, DINING, & KITCHEN	WOOD		DRYWALL	PAINT	GYPSUM BD.	PAINT	2641				
BEDROOM	WOOD		DRYWALL	PAINT	GYPSUM BD.	PAINT	2641				
RECREATION ROOM	WOOD		DRYWALL	PAINT	GYPSUM BD.	PAINT	2641				
WASHROOM	CERAMIC		DRYWALL	PAINT	GYPSUM BD.	PAINT	2641				
COLD ROOM	CONCRETE		CONCRETE		CONCRETE						
UTILITY ROOM	CONCRETE		DRYWALL		GYPSUM BD.		2641				

# DOOR SCHEDULE

- 1. ALL INTERIOR DOORS ARE SLAB DOOR 1-3/8 TH. HOLLOW CORE. THE SIZES ARE MENTIONED ON THE FLOOR PLAN. THE HEIGHT OF ALL DOORS ARE 80"
- EGRESS DOOR PROP. BELOW GRADE EXTERIOR TYPE STEEL DOOR PROVIDES ACCESS TO THE

# WINDOW SCHEDULE

ONE WINDOW PER FLOOR TO HAVE AN UNOBSTRUCTED OPEN PORTION W/A MIN. AREA OF 0.35m<sup>2</sup> W/ NO DIMENSION LESS THAN 380mm & MAXIMUM SILL HEIGHT OF 1m ABOVE FLOOR WINDOW SIZES HAVE BEEN PROVIDED ON THE FLOOR PLANS

# **CONSTRUCTION NOTES**

- FOUNDATION WALL INSULATION
- FOUNDATION WALL, MOISTURE BARRIER, 2x4 STUDS @ 16" O.C., WITH R20CI INSULATION, 1/2" GYPSUM DRYWALL JOINTS TAPED AND SEALED AND PAINTED
- INTERNAL WALLS
  - EXISTING WOOD FRAMED WALL CONSISTING OF 2x4 WOOD STUDS @ 16" O.C. WITH 1/2" DRY WALL ON **BOTH SIDES**
- PROP. CEILING
- PROVIDE 45 MIN. F.R.R AND 50 STC FOR THE CEILING WITH FOLLOWING SPECIFICATIONS TABEL - 2 AS PER SB-3 (F9h) ABSORPTIVE MATERIAL BETWEEN EXISTING JOISTS, RESELIENT METAL CHANNELS SPACED 610 mm O.C. TWO LAYERS OF 12.7 mm TYPE X GYPSUM BOARD ON CEILING SIDE
- 20 MIN. FIRE RESISTANCE RATED DOOR FOR COMMON AREA AND BETWEEN BASEMENT APARTMENT AND PRINCIPAL RESIDENCE WITH SELF CLOSING DEVICE
- EXISTING DUCT WORK LOCATED IN THE CEILING AND WALL HAS THE DIRECTION OF THE HEAT FLOW TOWARDS THE FLOOR
- MECHANICAL VENTILATION
- 50 CFM EXHAUST FANS IN KITCHEN AND WASHROOM
- IN COMPLIANCE WITH C152(b) SMOKE ALARMS ARE INSTALLED IN EVERY DWELLING UNIT AND COMMON AREAS IN CONFORMANCE WITH OBC 9.10.19. SMOKE ALARM SHALL BE WIRED AND INTERCONNECTED FOR THE ENTIRE BUILDING
- PROVIDE CARBON MONOXIDE ALARM CONFIRMING TO CAN/CSA-6.19 "RESIDENTIAL CARBON MONOXIDE ALARMING DEVICES" ADJACENT TO EACH SLEEPING AREA WITHIN EACH DWELLING UNIT. CARBON MONOXIDE ALARMS MAY BE HARDWIRED, BATTERY OPERATED OR THE TYPE THAT CAN BE PLUGGED INTO ELECTRICAL OUTLET
- (9) FOR ALL ELECTRICAL WORK AND PERMIT CONTACT ELECTRICAL SAFETY AUTHORITY

# **GENERAL NOTES**

- THE CONTRACTOR SHALL VERIFY ALL DIMENSIONS, SITE CONDITIONS AND ELEVATIONS WITH ARCHITECTURAL DRAWINGS AND RESOLVE ANY DISCREPANCIES WITH THE ENGINEER PRIOR TO START OF WORK
- ALL CONSTRUCTION SHALL BE IN ACCORDANCE WITH PART 9 AND 4 OF ONTARIO BUILDING CODE 2012 AND CITY BY-LAWS AND STANDARDS
- IT IS ASSUMED THAT THE WORK DEPICTED WILL BE PERFORMED BY AN EXPERIENCED CONTRACTOR AND/OR WORKMEN HAVING WORKING KNOWLEDGE OF THE APPLICABLE CODE, STANDARDS, INSURANCES AND REQUIREMENTS OF INDUSTRY ACCEPTED STANDARD, AS NOT EVERY CONDITION OR ELEMENT IS (OR CAN BE) EXPLICITLY SHOWN ON THESE DRAWINGS.
- BY COMMENCING CONSTRUCTION OF A BUILDING FROM THESE DRAWINGS, THE OWNER AND/OR BUILDER ACKNOWLEDGES THAT THE GENERAL NOTES HAVE BEEN READ AND UNDERSTOOD
- · THE DRAWINGS PREPARED BY THE DESIGNER IS FOR THE PERMIT IN COMPLIANCE WITH OBC AND CITY BY-LAWS.
- THE DESIGNER IS NOT LIABLE FOR COST INCURRED FOR RE-WORK, ALTERATION, DISCREPANCIES OR ANY KIND OF CONSTRUCTION RELATED WORK
- ALL WOOD USED IN THE CONSTRUCTION SHALL BE SPF NO.1 OR NO 2
- MINIMUM BEARING OF STEEL LINTELS 150 MM.
- MINIMUM BEARING OF WOOD BEAM / LINTELS 90 MM
- MINIMUM BEARING OF WOOD JOISTS 40MM
- VERIFY EXISTING SUPPORT SYSTEM, INCLUDING FOUNDATIONS, FOR LOADS IMPOSED BY THE PROPOSED CONSTRUCTION
- PROVIDE ALL BRACING, SHORING AND NEEDLING NECESSARY FOR THE SAFE EXECUTION OF THIS WORK
- INFORM CITY OF ALL INSPECTION AHEAD OF TIME AND AT EACH STAGE OF CONSTRUCTION
- · ANY DISCREPANCIES SHALL BE BROUGHT TO THE NOTICE OF ENGINEER PRIOR TO START OF WORK
- CONTRACTOR TO PROVIDE THE DESIGNED WINDOW / DOOR OR ANY EQUIVALENT STANDARD SIZE AVAILABLE IN MARKET


- **SWITCH**
- 3 WAY SWITCH INSTALL AT 3'-3" AFF 3 DENOTES 3-WAY SWITCH SPECIFICATION GRADE WHITE, WITH WHITE COVER PLATE SHALL BE INSTALLED AT THE **ENDS OF EACH STAIRWAYS**
- 15A, 120V DUPLEX RECEPTACLE SPECIFICATION GRADE WHITE, C/W WHITE COVER PLATE GFI - GROUND FAULT TYPE WP -WEATHERPROOF COVER
  - С - ABOVE COUNTER
- RECEPTACLE 50A, 208V. STOVE OR DRIER OUTLET.
- $\Rightarrow$ **RECEPTACLE**
- LIGHT
- Ø **SPOT LIGHT**
- **EMERGENCY LIGHT**
- $\circ$ FD: FLOOR DRAIN
- **SPRINKLER**
- $\otimes$ DUCT TYPE SMOKE DETECTOR
- SMOKE ALARM
- CARBON MONOXIDE DETECTOR
  - **EXHAUST FAN**

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PROFESSIONAL



ENGINEER:

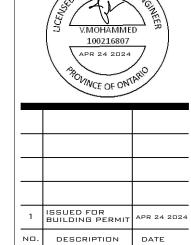

EMAIL : INFO@MECHWAYS.COM

CONSULTANT:

PROJECT:

1328 ALMOND CRESCENT OAKVILLE, ON


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GENERAL NOTES

CHECKED: MSS DRAWN: MSA SCALE: N.T.S DATE: APR 24 2024


DRAWING:

A 4.1

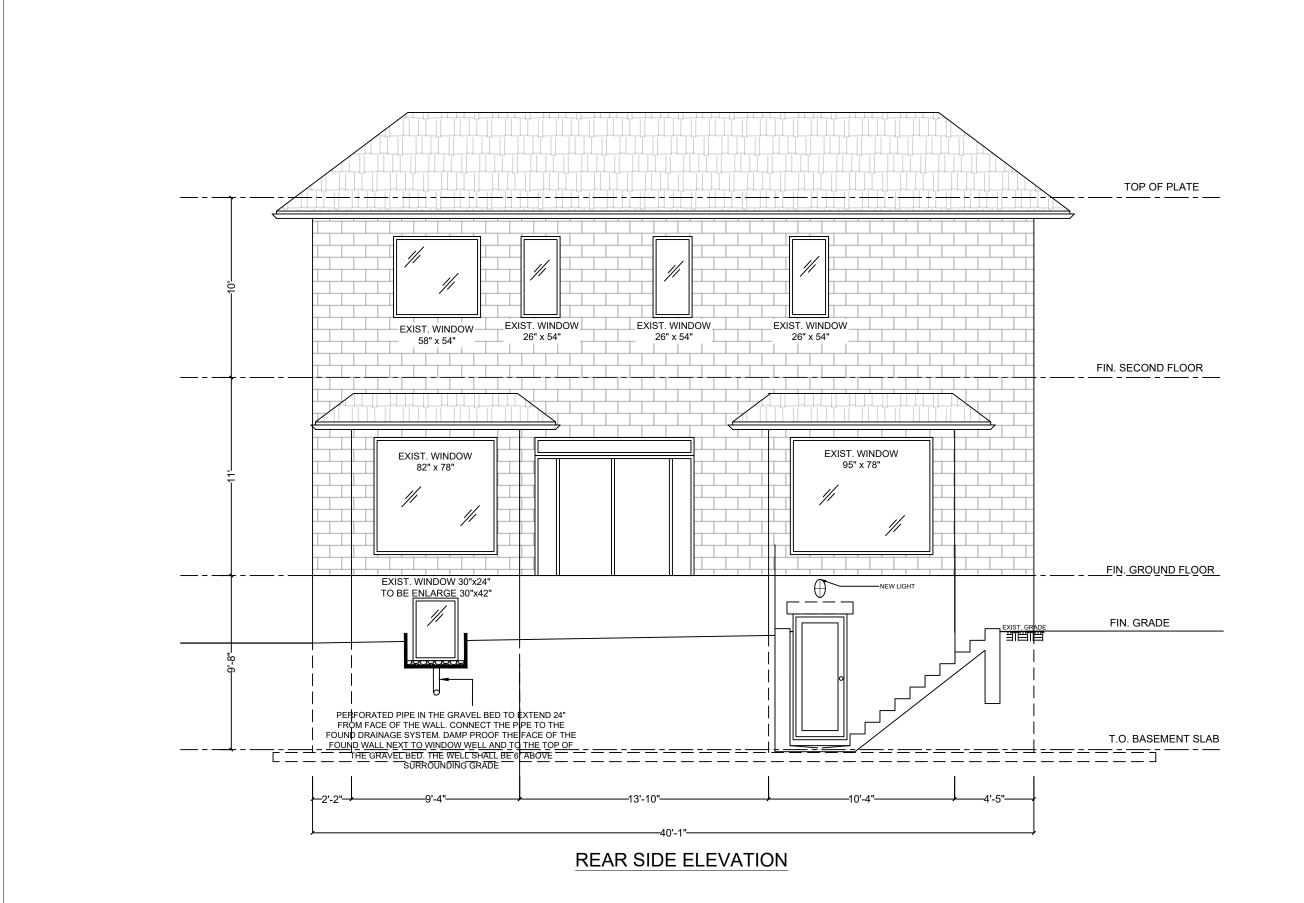

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# ENGINEER:

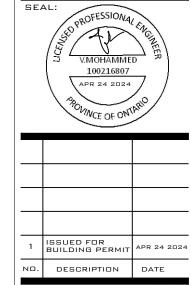

EMAIL : INFO@MECHWAYS.COM WEBSITE : WWW.MECHWAYS.COM

# CONSULTANT:

# PROJECT:

1328 AYMOND CRESCENT OAKVILLE, ON


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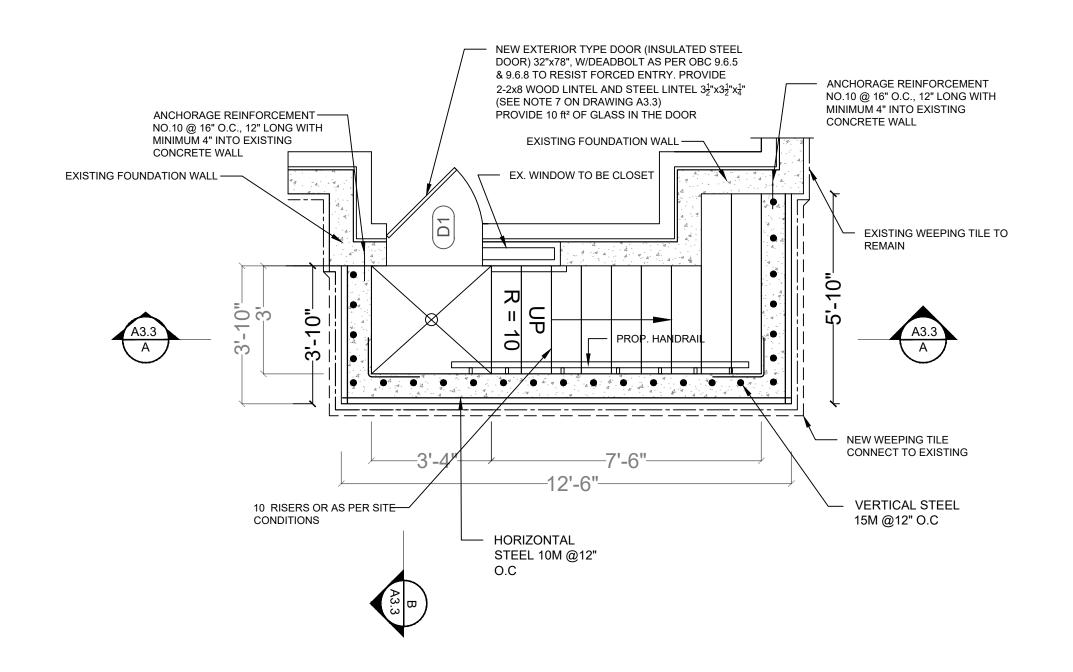
REAR ELEVATION PLAN

CHECKED: MSS
DRAWN: MSA
SCALE: 3 / 16" = 1' - 0"
DATE: JUNE/25/ 2021

DRAWING:


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### ENGINEER:

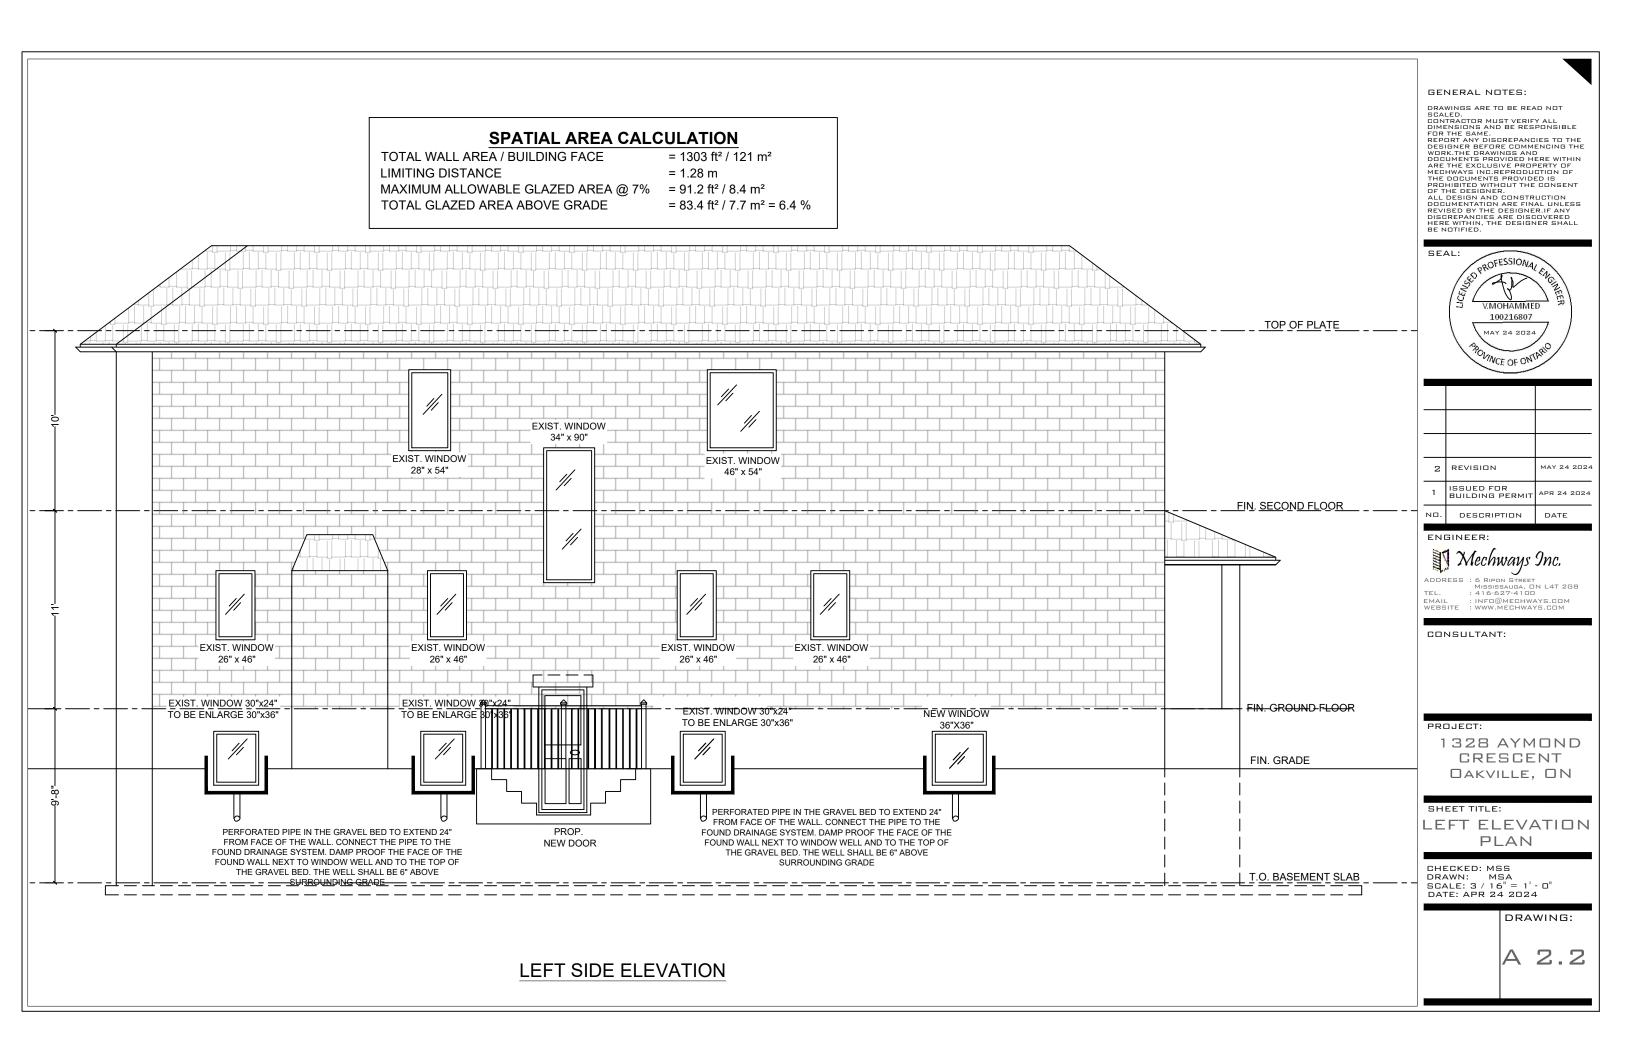

# CONSULTANT:

### PROJECT:

1328 AYMOND CRESCENT OAKVILLE, ON
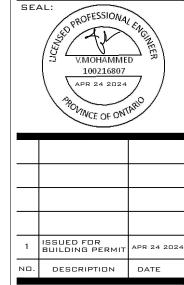
# SHEET TITLE:

WALK-OUT PLAN

CHECKED: MSS
DRAWN: MSA
SCALE: 3 / 8" = 1' - 0"
DATE: APR 24 2024

DRAWING:

A 3.1