

KEY PLAN (NOT TO SCALE)

SITE, GRADING & SERVICING PLAN REGISTERED PLAN 1060

REGIONAL MUNICIPALITY OF HALTON SCALE 1 : 150 J.H. Gelbloom Surveying Limited

Distances shown on this plan are in metres and can be converted to feet dividing by 0.3048.

(METERS) 2014-014 RL2-0 836.50 SQ.M. 261,29 SQ.M. 242.82 SQ.N OT COVERAGE % (MAXIMUM) 25.0% 23.23% 401.31 SQ.M. 386.71 SQ.M. FRONT YARD SETBACK (MINIMUM) 10.00 SIDE YARD SETBACK (MINIMUM) 1.21 & 2.40 REAR YARD SETBACK (MINIMUM) 19.97 8.98

Invert Elevation

EG Established Grade

92.56 Proposed Elevation

*SUBJECT TO COMMITTEE OF ADJUSTMENTS FILE NO.

CLF Chain Link Fence TFW Top of Foundation Wall Maintenance Hole Deciduous Tree Coniferous Tree

T.B.R. To Be Removed TOS Top of Slope BOS Bottom of Slope CSP Corrugated Steel Pipe WV Water Valve — Hoarding S Existing Elevation **→** Rain Water Leader TRW Top of Retaining Wall TTTT Embankment BRW Bottom of Retaining Wall

SITE ADDRESS *326 SANDLEWOOD ROAD* OAKVILLE, ONTARIO

AUG. 25, 2023 SITE & GRADING APRIL 4, 2024 REVISED BUILDING PLAN M.S. APRIL 15, 2024 REVISED SITE PLAN R.H. 4 JUNE 17, 2024 REVISED BUILDING PLAN M.K. Description REVISIONS

INFORMATION TAKEN FROM A SURVEY PREPARED BY J.H. GELBLOOM SURVEYING LTD., O.L.S.

Elevations are Referred to the Town of Oakville Benchmark No. 36

June 20, 2024

Andrew Musil, SO.L.S. Checked By: А.М.

21-121 Drawn By: Party Chief:



- 1. A DRAINAGE LAYER IS REQUIRED FOR FOUNDATION WALLS. WHERE THE INTERIOR INSULATION EXTENDS MORE THAN 2'-11" BELOW EXTERIOR
- 2. 2 COATS OF BITUMINOUS DAMPPROOFING ON 10" REINFORCED POURED CONCRETE WALLS.
- PROVIDE 1/4" PARGING COVED OVER POURED CONCRETE FOOTING. 4. PROVIDE 2" x 3" WOOD STRAPPING @ 16" O.C. ON INTERIOR FACE OF CONCRETE FOUNDATION WALL, R-20 INSULATION W/ INTEGRAL VAPOUR BARRIER, FULL HEIGHT 1/2" GYPSUM BOARD TAPED, SANDED & PRIMED
- READY FOR PAINT. 5. CONT. 2" x 6" WOOD SILL PLATE FASTENED W/ 1/2" DIAMETER x 12" LONG ANCHOR BOLTS EMBEDDED 6" IN CONCRETE @ 6'-0" O.C. MAX. & PROVIDE A FLEXIBLE SILL GASKET BETWEEN PLATE AND FOUNDATION.

CUT STONE VENEER CONSTRUCTION

4" CUT STONE VENEER FACE WITH HAIR LINE JOINT BETWEEN STONE MODULES , 1" AIR SPACE, TYVEK HOUSE WRAP (AIR BARRIER/ MOISTURE BARRIER) , LAYERS TO OVERLAP, JOINTS TAPED & SEALED ON 1/2" DENSE GLASS GOLD SHEATHING ON 2" x 6" @ 16" O.C. SPR STUD WALLS W/ R-24 BATT INSULATION W/ VAPOUR BARRIER (WARM SIDE). DOUBLE TOP PLATE & SINGLE SOLE PLATE, 1/2" GYPSUM BOARD TAPED, SANDED & PRIMED, READY FOR PAINT FINISH.USE METAL WALL TIES FOR LARGE CUT STONE ANCHORAGE.

PROVIDE 0.03 THICK x 7/8" WIDE GALVANIZED METAL VENEER TIES @ 32" O.C. HORIZONTALLY AND 16" O.C. VERTICALLY FASTENED WITH CORROSION RESISTANT 0.125" DIAMETER SCREWS OR SPIRAL NAILS WHICH PENETRATE A MINIMUM OF 1-3/16" INTO STUD.

AT FOUNDATION WALLS PROVIDE 20 MIL POLY FLASHING MIN. 6" UP BEHIND SHEATHING PAPER WEEP HOLES, MINIMUM 2'-7" APART AT BOTTOM COURSE OF VENEER AND ABOVE ALL OPENINGS.

BRICK VENEER CONSTRUCTION

4" BRICK FACE, 1" AIR SPACE, TYVEK HOUSE WRAP (AIR BARRIER/ MOISTURE BARRIER), LAYERS TO OVERLAP, JOINTS TAPED & SEALED ON 1/2" EXTERIOR GRADE PLYWOOD SHEATHING ON 2" x 6" @ 16" O.C. SPR STUD WALLS W/ R-20 BATT INSULATION W/ VAPOUR BARRIER (WARM SIDE). DOUBLE TOP PLATE & SINGLE SOLE PLATE, 1/2" GYPSUM BOARD TAPED, SANDED & PRIMED, READY FOR PAINT FINISH.

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PROVIDE STICK FRAME ROOF SADDLE CONSTRUCTION OVER PRE-FABRICATED ROOF TRUSS SYSTEM TO ENSURE POSITIVE DRAINAGE TO PERIMETER EAVES DRAINAGE

CONCRETE PORCH

1. ALLOW 4" BEARING FOR CONCRETE SLAB. PROVIDE DEEP POCKETS TO SUPPORT CONCRETE SLAB BY REMOVING EVERY 2ND PAIR OF FACE BRICKS WHEN BRICK FACING IS USED.

SLOPED ROOF CONSTRUCTION:

ASPHALT SHINGLES ON 15 LB. BUILDING PAPER ON ½" EXTERIOR GRADE

PLYWOOD SHEATHING ON PRE-ENGINEERED ROOF TRUSSES AS NOTED ON

DRAWINGS. PROVIDE APPROVED EAVES PROTECTION TO MIN. 12" BEYOND

INNER FACE OF EXTERIOR WALL. PROVIDE MIN. R40 BATT INSULATION W/ 6 MIL.

POLY VAPOUR BARRIER (WARM SIDE- ABOVE CEILING) W/ 5/8" GYPSUM BOARD.


PROVIDE MIN. 1 SQ.FT. OF ROOF VENT AREA FOR EVERY 300 SQ.F.T OF

INSULATED CEILING EVENLY DISTRIBUTED W/ MIN. 50% @EAVES.

GYPSUM BOARD TO BE TAPED, SANDED AND PRIMED READY FOR PAINT FINISH.

- 2. WHEN FACE BRICK IS USED ABOVE GRADE LEVEL, PROVIDE 3/16" DIAMETER CORROSION RESISTANT METAL TIES@ 36" HORIZONTALLY, 8"
- 3. MINIMUM 3/4" CLEAR CONCRETE TO COVER RE-BAR. STAIRS AND HANDRAILS TO CONFORM TO NOTES 29. & 30.
- 34 PRECAST STONE SURROUND

ANY UNAUTHORIZED ALTERATION, PUBLICATION, COPYING OR USE OF THE DRAWING WITH THE WRITTEN CONSENT FROM SG&M ARCHITECTS IS STRICTLY PROHIBITED AND SHALL BE DEEMED AN INFRINGEMENT UNDER THE COPYRIGHT ACT. SG&M ARCHITECTS RESERVES ALL PROPERTY RIGHTS IN AND TO THE DIGITAL DATA INCLUDING COPYRIGHT.

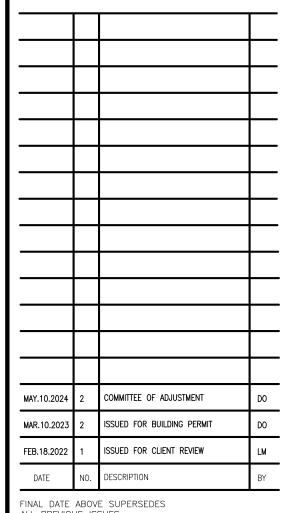

FINAL DATE ABOVE SUPERSEDES ALL PREVIOUS ISSUES

KEY TO DETAIL LOCATION DETAIL NOTATION DRAWING NUMBER

AND CONDITIONS ON THE JOB AND REPORT ANY DISCREPANCIES TO THE ARCHITECTS BEFORE PROCEEDING WITH THE WORK DRAWINGS ARE NOT TO BE SCALED.



Architects


Toronto, ON M5M 2J1 Tel: (416) 781-6125 Web: WWW.SGM-ARCH.COM

326 SANDLEWOOD RD OAKVILLE, ON

CUSTOM HOME

FRONT ELEVATION

	1/4" = 1'-0"	SCALE
	RS/DO	DRAWN
A O	LM	CHECKED
A3-	FEB.18.2022	DATE
DRAWING NO	2021-49	PROJ. NO.

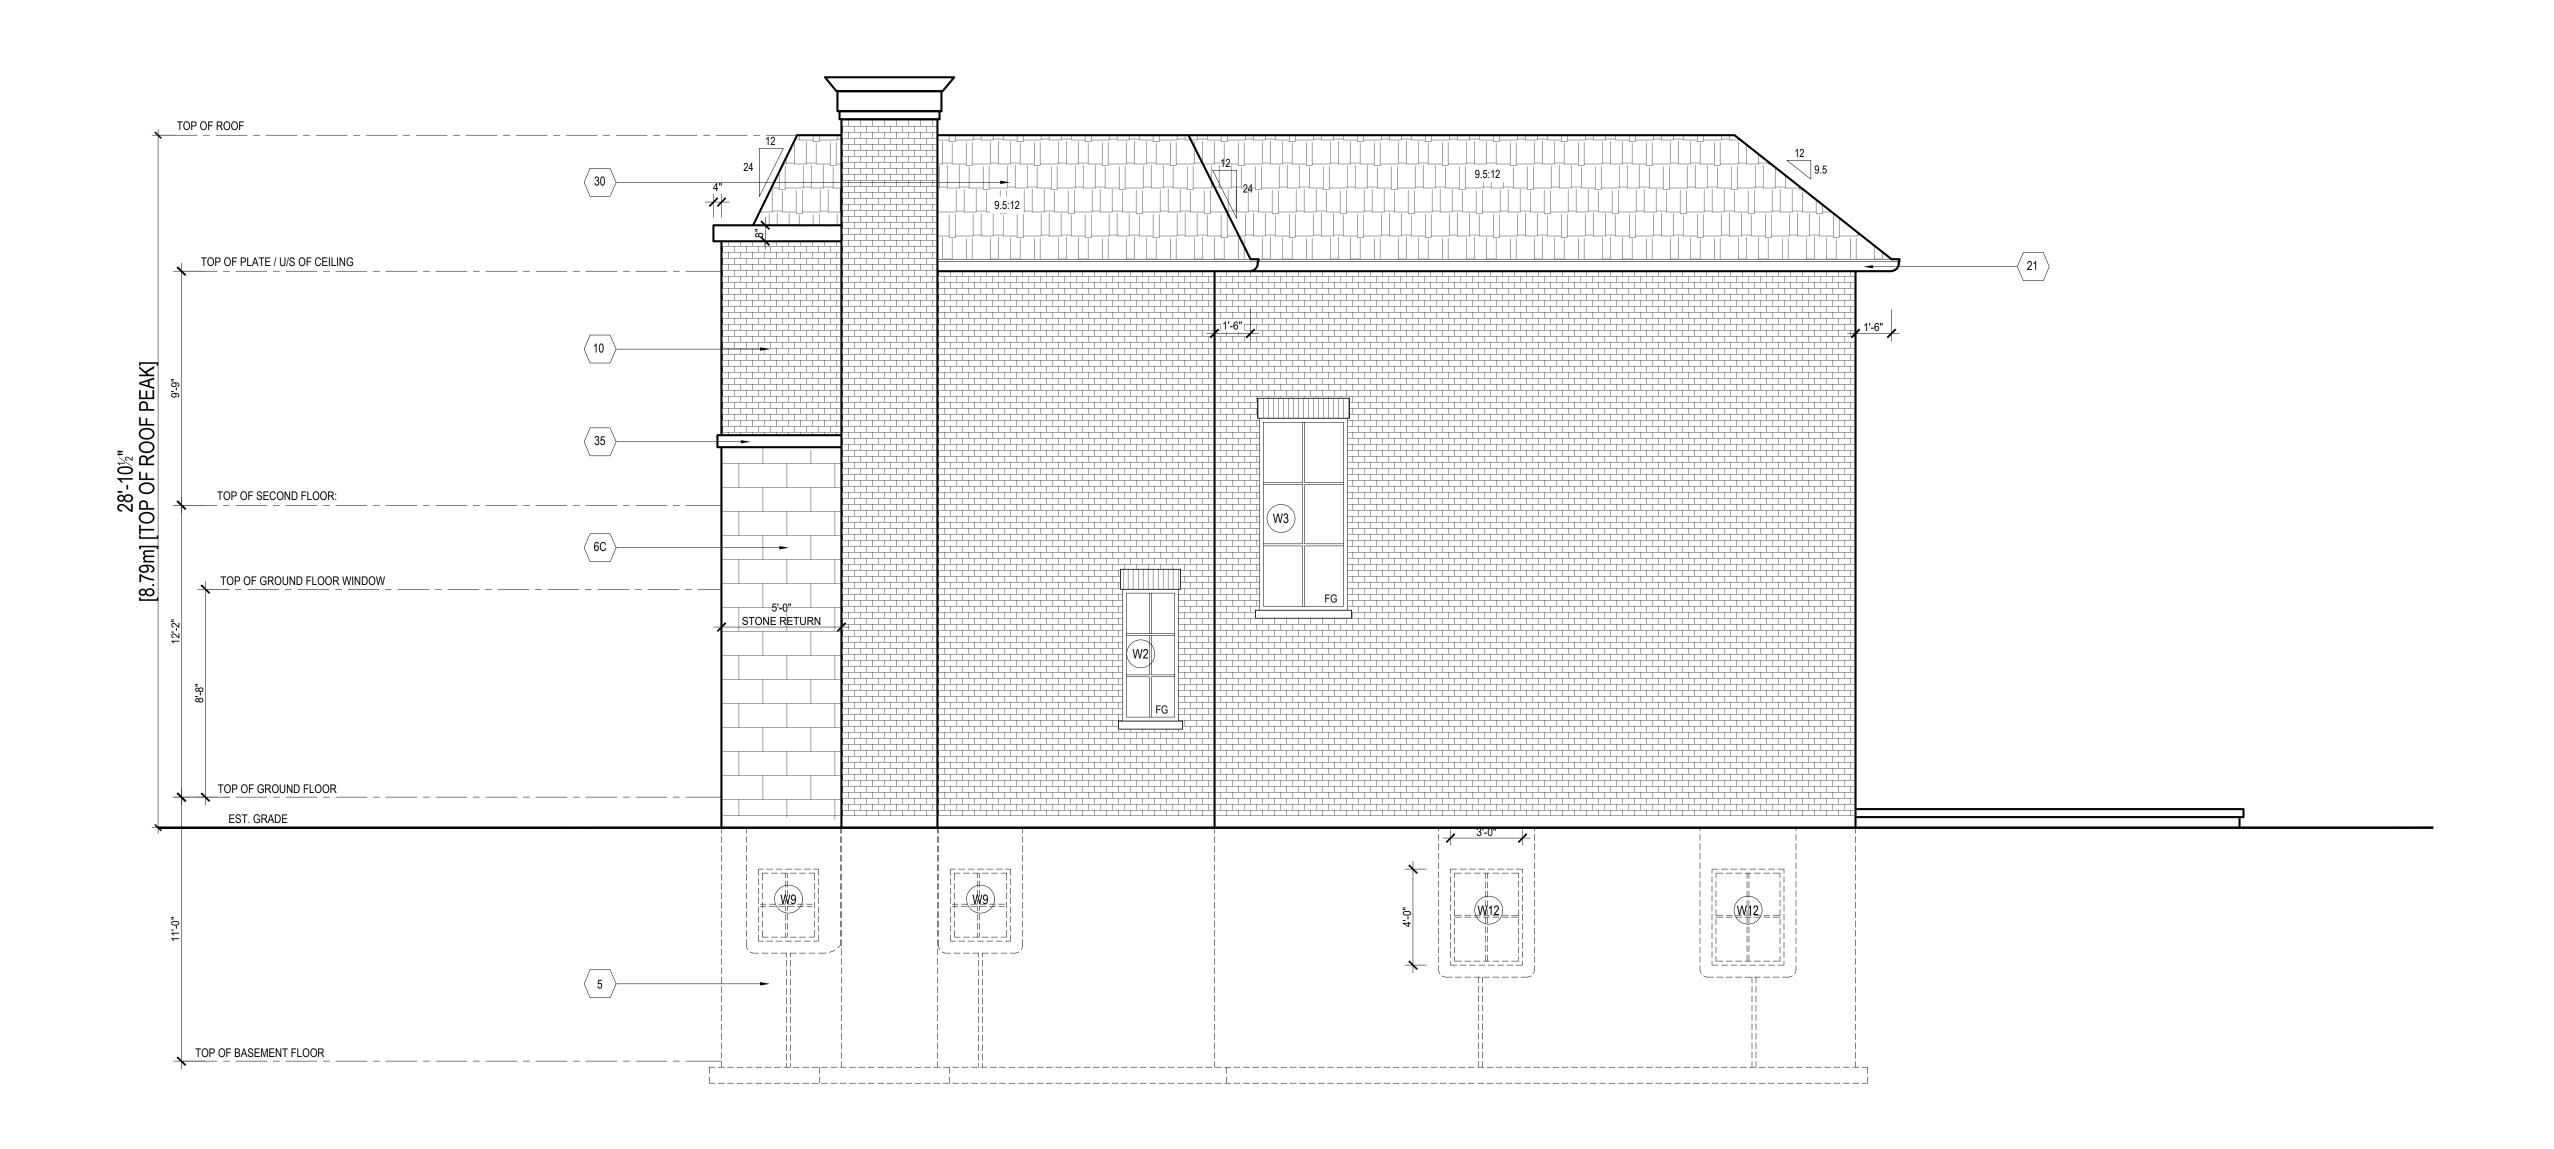

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- 3. PROVIDE 1/4" PARGING COVED OVER POURED CONCRETE FOOTING. 4. PROVIDE 2" x 3" WOOD STRAPPING @ 16" O.C. ON INTERIOR FACE OF CONCRETE FOUNDATION WALL, R-20 INSULATION W/ INTEGRAL VAPOUR BARRIER, FULL HEIGHT 1/2" GYPSUM BOARD TAPED, SANDED & PRIMED READY FOR PAINT.
- 5. CONT. 2" x 6" WOOD SILL PLATE FASTENED W/ 1/2" DIAMETER x 12" LONG ANCHOR BOLTS EMBEDDED 6" IN CONCRETE @ 6'-0" O.C. MAX. & PROVIDE A FLEXIBLE SILL GASKET BETWEEN PLATE AND FOUNDATION.

CUT STONE VENEER CONSTRUCTION

 $\langle 6C \rangle$ 4" CUT STONE VENEER FACE WITH HAIR LINE JOINT BETWEEN STONE MODULES , 1" AIR SPACE, TYVEK HOUSE WRAP (AIR BARRIER/ MOISTURE BARRIER) , LAYERS TO OVERLAP, JOINTS TAPED & SEALED ON 1/2" DENSE GLASS GOLD SHEATHING ON 2" x 6" @ 16" O.C. SPR STUD WALLS W/ R-24 BATT INSULATION W/ VAPOUR BARRIER (WARM SIDE). DOUBLE TOP PLATE & SINGLE SOLE PLATE, 1/2" GYPSUM BOARD TAPED, SANDED & PRIMED, READY FOR PAINT FINISH.USE

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PREFINISHED ALUMINUM RAIN WATER LEADER (RWL)

COLOUR TO MATCH EAVESTROUGHING. INSTALL PREFINISHED CONDUCTOR HEADS ON FRONT ELEVATION AS PER DRAWING. DOWNSPOUTS NOT CONNECTED TO STORM SEWER SHALL HAVE EXTENSIONS TO CARRY WATER AWAY FROM THE BUILDING & PROVISIONS SHOULD BE MADE TO PREVENT SOIL EROSION AND DEVERT WATER TO SOFT LANDSCAPING AREAS. PROVIDE PRECAST CONCRETE SPLASH BLOCKS IF REQUIRED TO AVOID RAIN WATER DISCHARGING DIRECTLY ONTO DRIVEWAYS AND WALKWAYS.

ROOF SADDLE

PROVIDE STICK FRAME ROOF SADDLE CONSTRUCTION OVER PRE-FABRICATED ROOF TRUSS SYSTEM TO ENSURE POSITIVE DRAINAGE TO PERIMETER EAVES DRAINAGE

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- 2. WHEN FACE BRICK IS USED ABOVE GRADE LEVEL, PROVIDE 3/16" DIAMETER CORROSION RESISTANT METAL TIES@ 36" HORIZONTALLY, 8" VERTICALLY.
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PRECASET CONCRETE SILL

30 SLOPED ROOF CONSTRUCTION:

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4" BRICK FACE, 1" AIR SPACE, TYVEK HOUSE WRAP (AIR BARRIER/ MOISTURE BARRIER), LAYERS TO OVERLAP, JOINTS TAPED & SEALED ON 1/2" EXTERIOR GRADE PLYWOOD SHEATHING ON 2" x 6" @ 16" O.C. SPR STUD WALLS W/ R-20 BATT INSULATION W/ VAPOUR BARRIER (WARM SIDE). DOUBLE TOP PLATE & SINGLE SOLE PLATE, 1/2" GYPSUM BOARD TAPED, SANDED & PRIMED, READY FOR PAINT FINISH.

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MAY.10.2024	2	COMMITTEE OF ADJUSTMENT	DO
MAR.10.2023	2	ISSUED FOR BUILDING PERMIT	DO
FEB.18.2022	1	ISSUED FOR CLIENT REVIEW	LM
DATE	NO.	DESCRIPTION	BY

ALL PREVIOUS ISSUES

KEY TO DETAIL LOCATION DETAIL NOTATION DRAWING NUMBER

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Toronto, ON M5M 2J1 Tel: (416) 781-6125 Web: WWW.SGM-ARCH.COM

326 SANDLEWOOD RD OAKVILLE, ON

CUSTOM HOME

RIGHT SIDE ELEVATION

	1/4" = 1'-0"	SCALE
	RS/DO	DRAWN
Λ.	LM	CHECKED
A	FEB.18.2022	DATE

2021-49 DRAWING N



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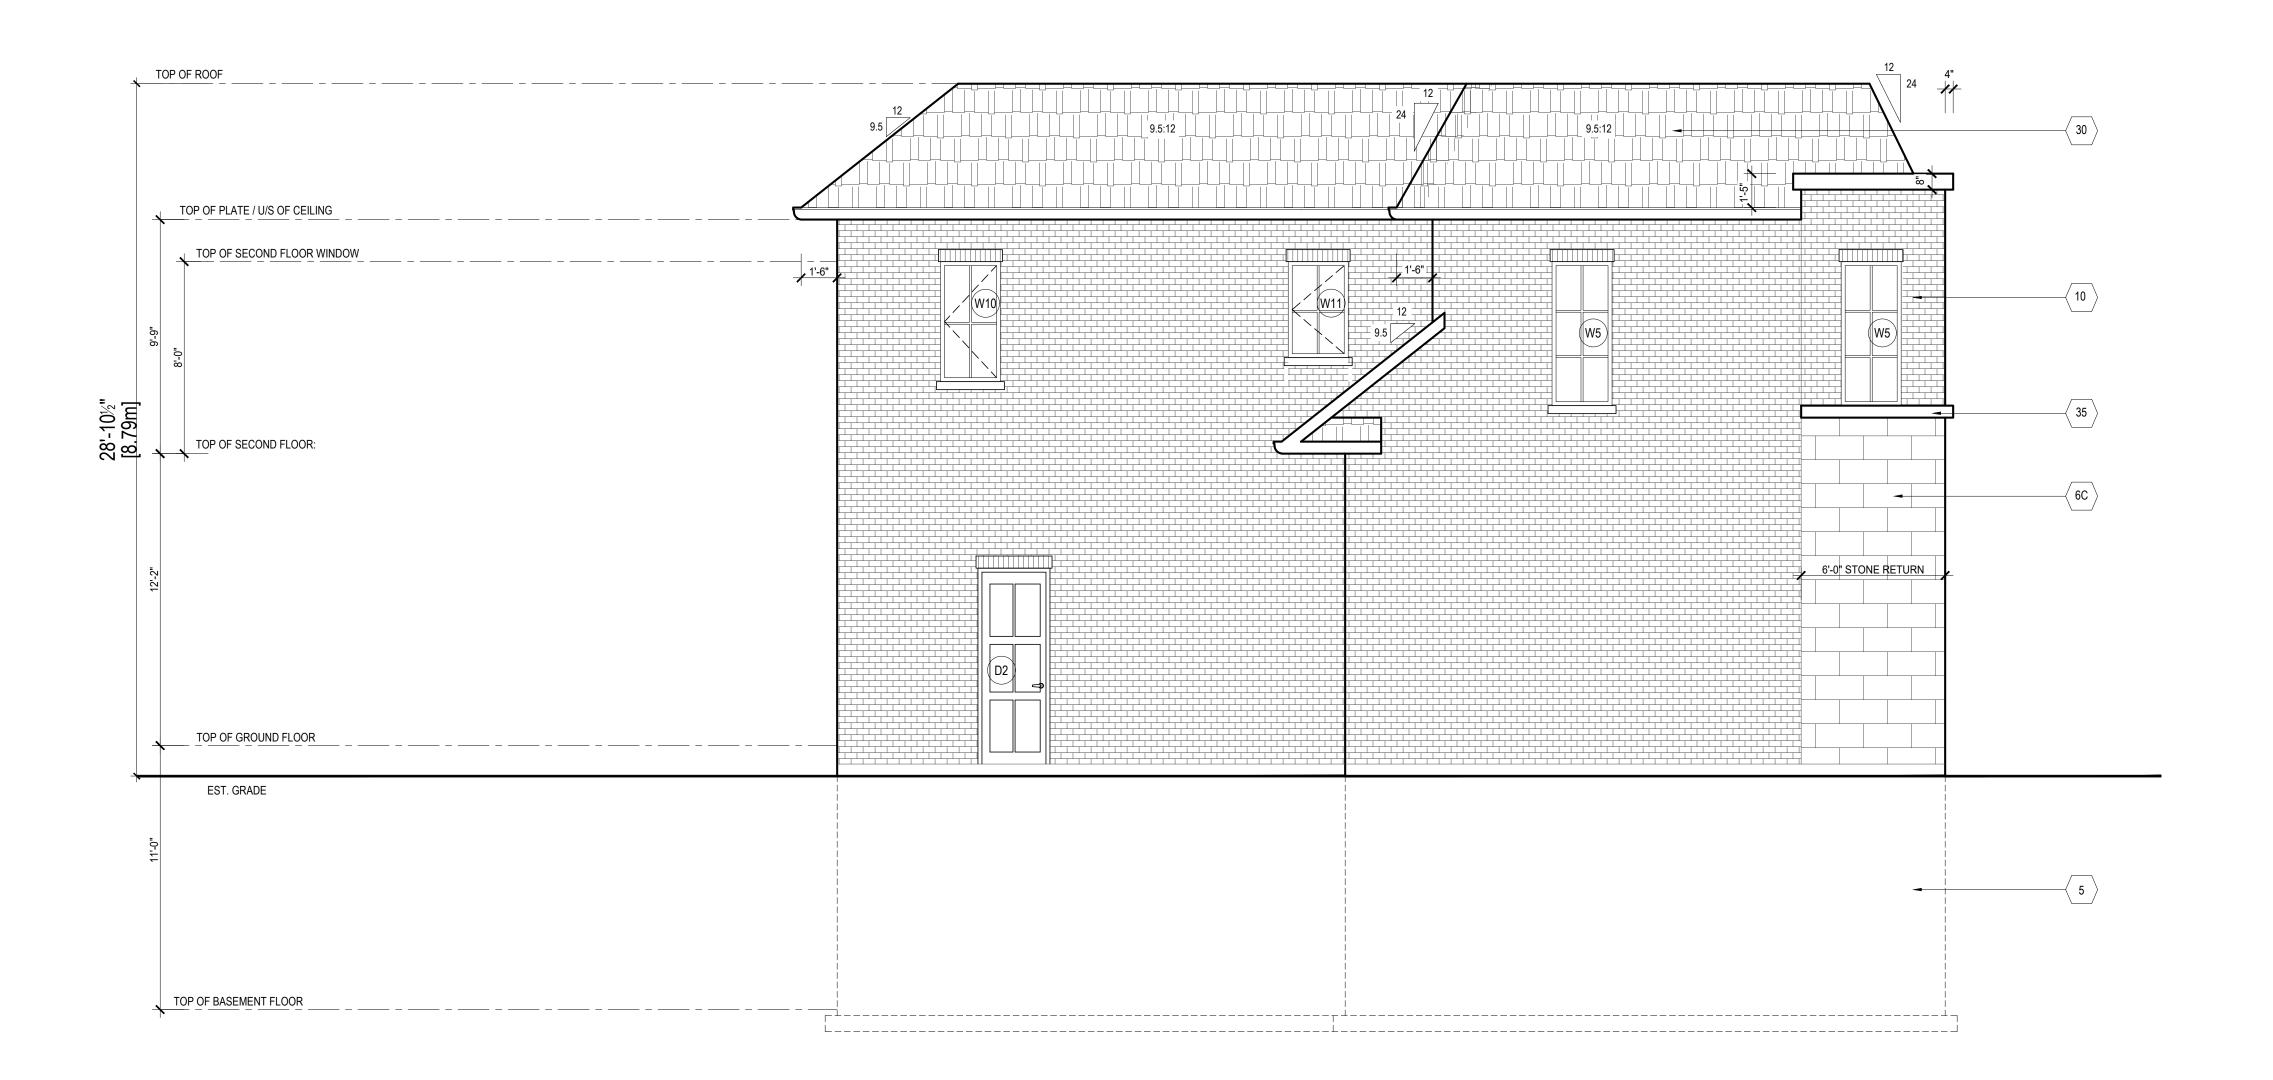
326 SANDLEWOOD RD OAKVILLE, ON

CUSTOM HOME

REAR ELEVATION

	1/4" = 1'-0"	SCALE
	RS/DO	DRAWN
۸ ۵	LM	CHECKED
A3	FEB.18.2022	DATE
	0004.40	

2021-49 DRAWING NO



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35 PRECASET CONCRETE SILL

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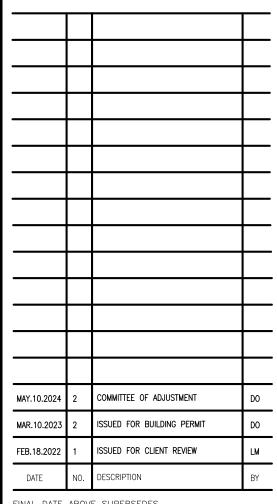
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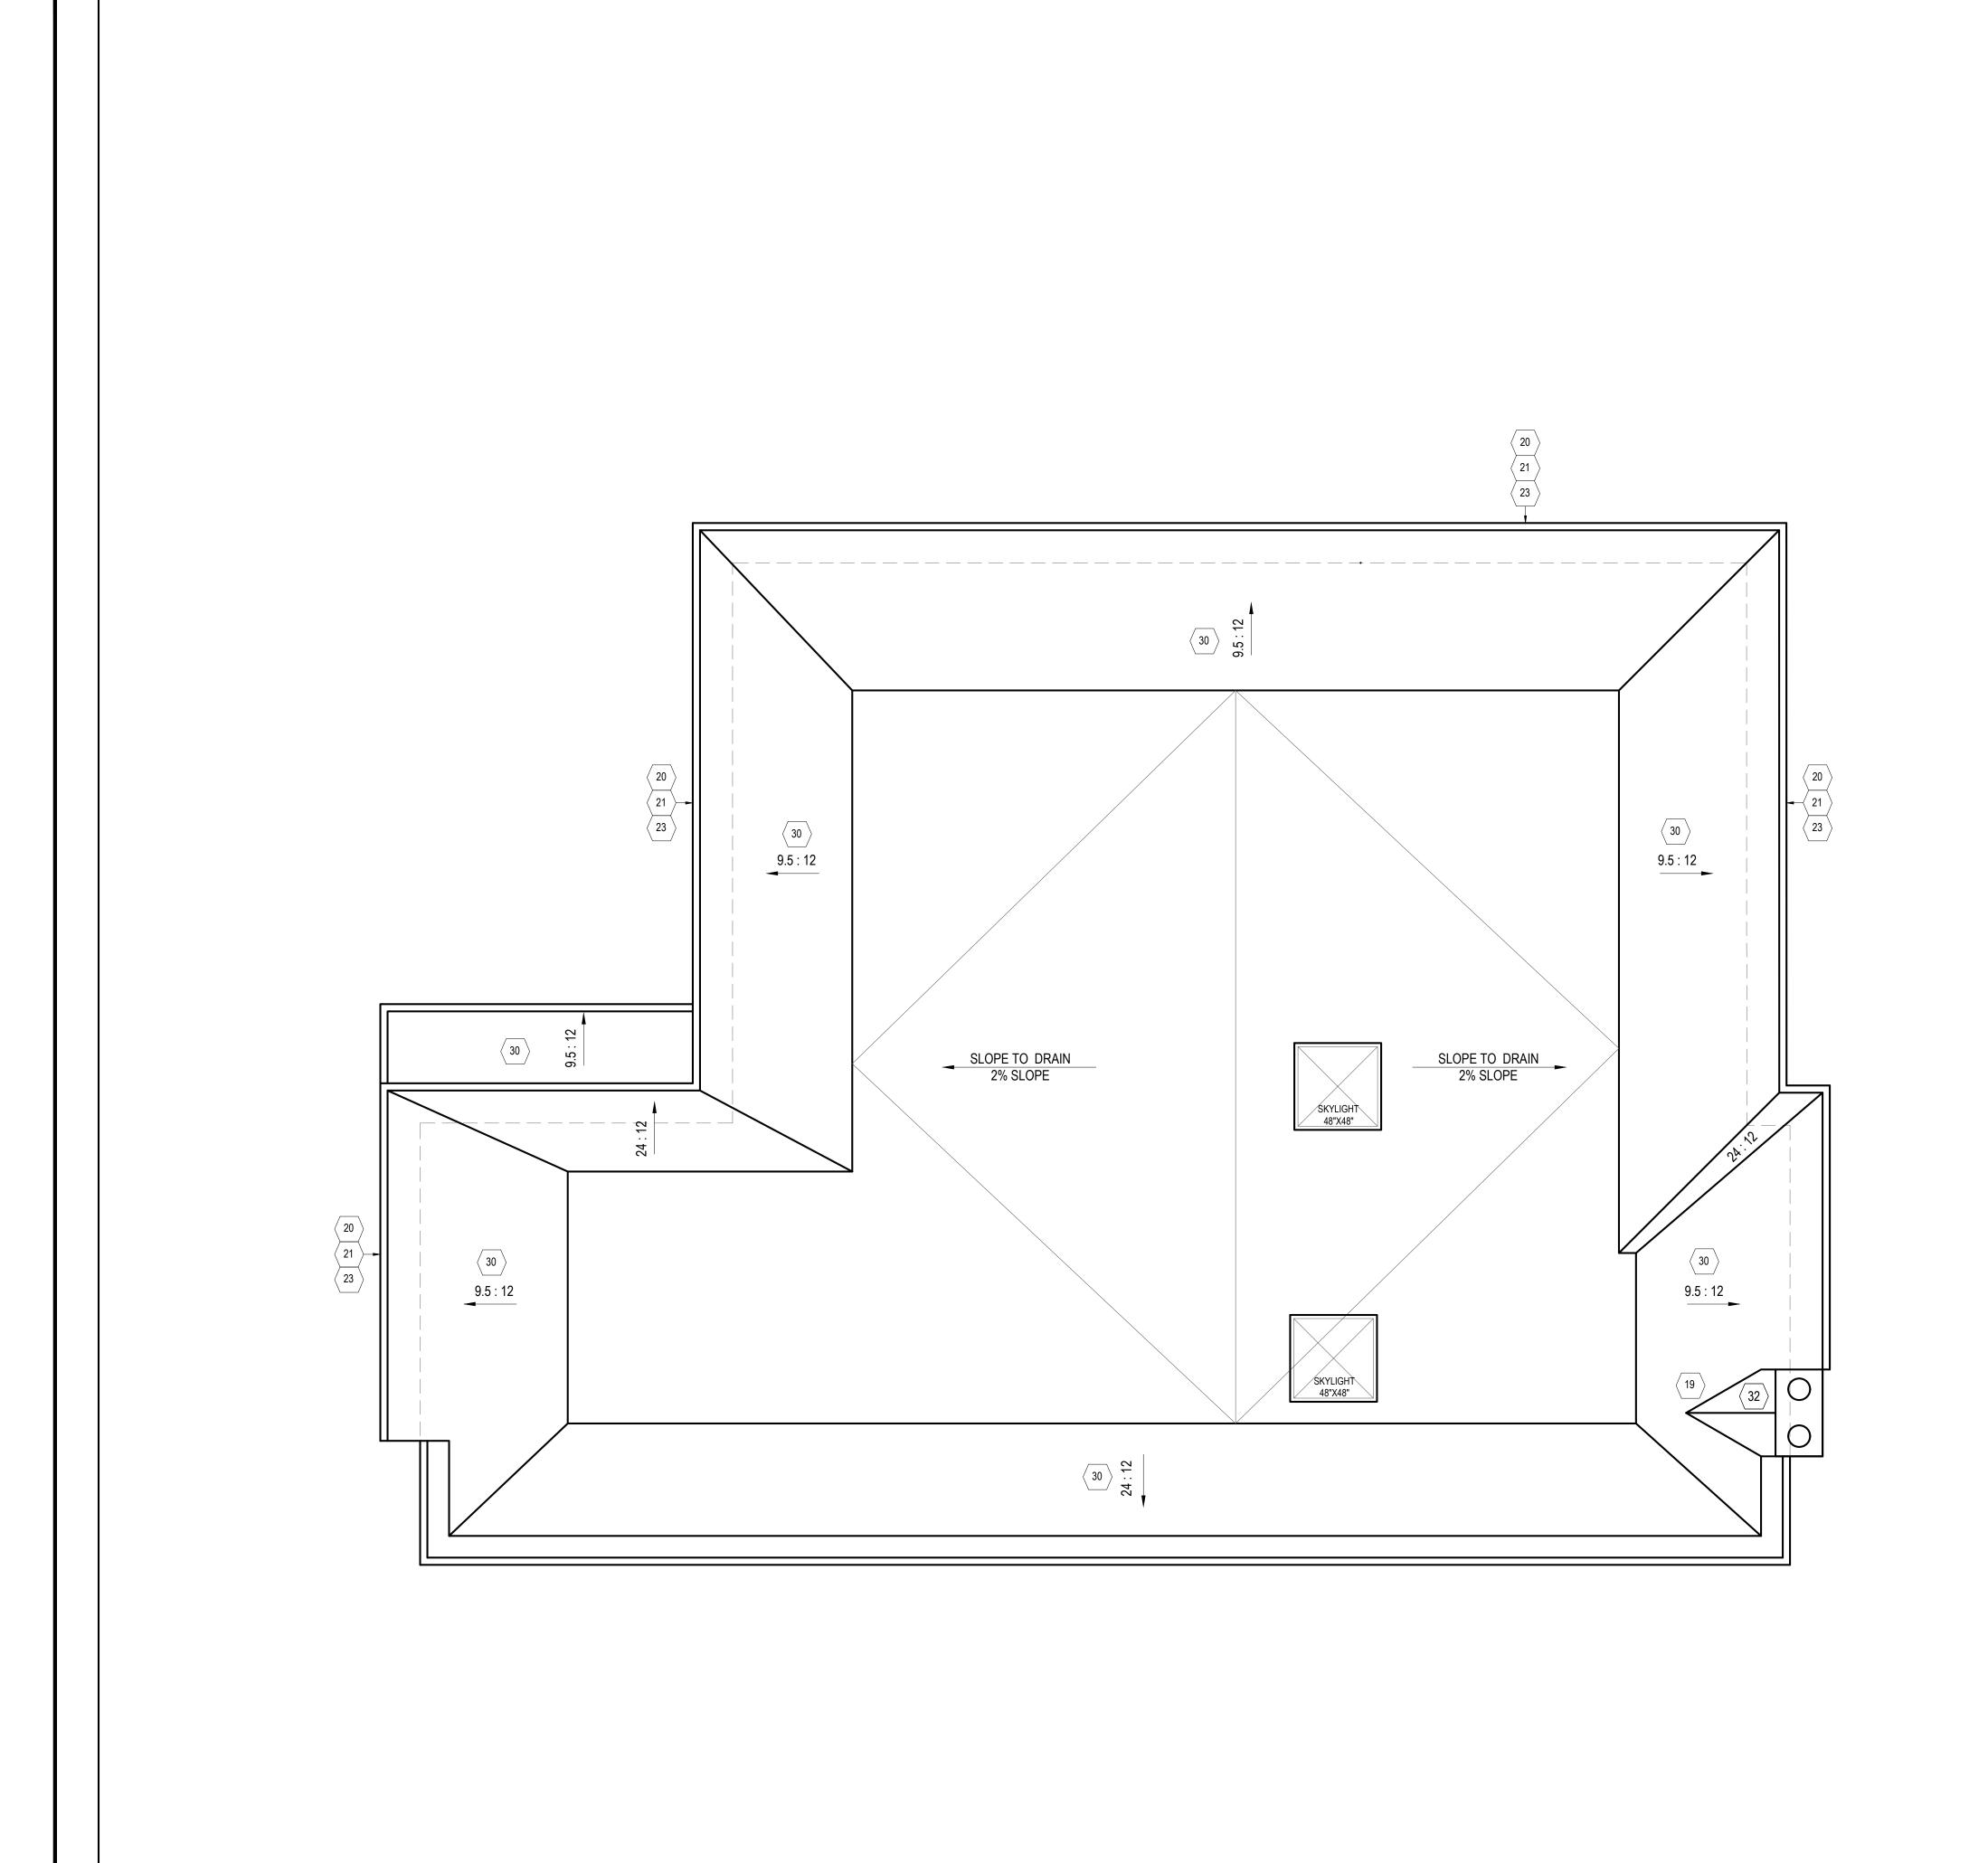
193 ROE AVENUE Toronto, ON M5M 2J1 Tel: (416) 781-6125 Web: WWW.SGM-ARCH.COM

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CUSTOM HOME

LEFT SIDE ELEVATION

	1/4" = 1'-0"	SCALE
	RS/DO	DRAWN
^ ^	LM	CHECKED
A3-4	FEB.18.2022	DATE
DRAWING NO	2021-49	PROJ. NO.



19 PREFINISHED METAL FLASHING

PROVIDE PREFINISHED METAL FLASHING AT ALL ROOF PENETRATIONS INCLUDING FLUES, CHIMNEYS, SKYLIGHTS AND ALL OTHER ARCHITECTURAL ROOF FEATURES. ENSURE THAT METAL FLASHING IS INSTALL A MINIMUM OF 6" ABOVE FINISHED ROOF LINE. PROVIDE STEP THRU WALL FLASHINGS AT SLOPING INTERFACES AS REQUIRED. COLOUR OF FLASHING TO BE SLECTED BY ARCHITECT AT A LATER DATE.

20 PREFINISHED ALUMINUM EAVESTROUGHING

ON 1" x 6" WOOD FASCIA

PREFINISHED ALUMINUM RAIN WATER LEADER (RWL)

COLOUR TO MATCH EAVESTROUGHING. INSTALL PREFINISHED CONDUCTOR HEADS ON FRONT ELEVATION AS PER DRAWING. DOWNSPOUTS NOT CONNECTED TO STORM SEWER SHALL HAVE EXTENSIONS TO CARRY WATER AWAY FROM THE BUILDING & PROVISIONS SHOULD BE MADE TO PREVENT SOIL EROSION AND DEVERT WATER TO SOFT LANDSCAPING AREAS. PROVIDE PRECAST CONCRETE SPLASH BLOCKS IF REQUIRED TO AVOID RAIN WATER DISCHARGING DIRECTLY ONTO DRIVEWAYS AND WALKWAYS.

23 VENTED ALUMINUM SOFFIT

SLOPED ROOF CONSTRUCTION:

ASPHALT SHINGLES ON 15 LB. BUILDING PAPER ON ½" EXTERIOR GRADE PLYWOOD SHEATHING ON PRE-ENGINEERED ROOF TRUSSES AS NOTED ON DRAWINGS. PROVIDE APPROVED EAVES PROTECTION TO MIN. 12" BEYOND INNER FACE OF EXTERIOR WALL. PROVIDE MIN. R40 BATT INSULATION W/ 6 MIL. POLY VAPOUR BARRIER (WARM SIDE- ABOVE CEILING) W/ 5%" GYPSUM BOARD. GYPSUM BOARD TO BE TAPED, SANDED AND PRIMED READY FOR PAINT FINISH. PROVIDE MIN. 1 SQ.FT. OF ROOF VENT AREA FOR EVERY 300 SQ.F.T OF INSULATED CEILING EVENLY DISTRIBUTED W/ MIN. 50% @EAVES.

ROOF SADDLE

PROVIDE STICK FRAME ROOF SADDLE CONSTRUCTION OVER PRE-FABRICATED ROOF TRUSS SYSTEM TO ENSURE POSITIVE DRAINAGE TO PERIMETER EAVES DRAINAGE

33 LOW SLOPED ROOF CONSTRUCTION:

4 PLY BUILT UP WATERPROOFING MEMBRANE ON MINIMUM 4"
POLYISOCYANURATE RIGID INSULATION BOARD (R30). PROVIDE TAPERED
INSULATION BOARD AS REQUIRED TO ENSURE POSITIVE DRAINAGE. TO
DRAINAGE OUTLET SCUPPERS. INSULATION BOARD PLACED OVER KRAFT
PAPER VAPOUR BARRIER AND APPLIED TO 1/2" EXTERIOR GRADE PLYWOOD
SHEATHING OVER METAL DECK AND OWSJ. PROVIDE TAPERED INSULATION AT
VERTICAL UPSTAND AND/OR PARAPET TO ENSURE DRAINAGE. PROVIDE 2 PLY
MODIFIED BIT MEMBRANE SHEET OVER WATER PROOFING MEMBRANE AT
PARAPETS AND PROVIDE PRE-FINISHED METAL FLASHING COPING OVER

ANY UNAUTHORIZED ALTERATION, PUBLICATION, COPYING OR USE OF THE DRAWING WITH THE WRITTEN CONSENT FROM SG&M ARCHITECTS IS STRICTLY PROHIBITED AND SHALL BE DEEMED AN INFRINGEMENT UNDER THE COPYRIGHT ACT.

SG&M ARCHITECTS RESERVES ALL PROPERTY RIGHTS IN AND TO THE DIGITAL DATA INCLUDING COPYRIGHT.

MAY.10.2024 2 COMMITTEE OF ADJUSTMENT DO

MAR.10.2023 2 ISSUED FOR BUILDING PERMIT DO

FEB.18.2022 1 ISSUED FOR CLIENT REVIEW LM

DATE NO. DESCRIPTION BY

FINAL DATE ABOVE SUPERSEDES ALL PREVIOUS ISSUES

REVISIONS

DETAIL NOTATION

DRAWING NUMBER


CONTRACTOR MUST CHECK AND VERIFY ALL DIMENSIONS
AND CONDITIONS ON THE JOB AND REPORT ANY
DISCREPANCIES TO THE ARCHITECTS BEFORE
PROCEEDING WITH THE WORK

DRAWINGS ARE NOT TO BE SCALED.

SG&M

Architects

193 ROE AVENUE Toronto, ON M5M 2J1 Tel: (416) 781-6125 Web: WWW.SGM-ARCH.COM

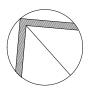

326 SANDLEWOOD RD OAKVILLE, ON

CUSTOM HOME

ROOF PLAN

 SCALE
 1/4" = 1'-0"

 DRAWN
 RS/DO

 CHECKED
 LM

 DATE
 FEB.18.2022

 PROJ. NO.
 2021-49

 DRAWING NO.

In regard to the 1 minor variance cited in the Committee of Adjustment notice, we are of the opinion that:

- The variance requested is minor in nature;
- The proposal is desirable for the appropriate use of the land and building;
- The general intent and purpose of the City's Zoning Code and/or Bylaw are maintained and;
- The general intent and purpose of the Official Plan are maintained.

Home Owner Name:	Saureet	Tinna	
Home Owner Address:_			

In regard to the 1 minor variance cited in the Committee of Adjustment notice, we are of the opinion that:

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- The proposal is desirable for the appropriate use of the land and building;
- The general intent and purpose of the City's Zoning Code and/or Bylaw are maintained and;
- The general intent and purpose of the Official Plan are maintained.

Home Owner Name: ADOLF AZ	7
Home Owner Address:	

In regard to the 1 minor variance cited in the Committee of Adjustment notice, we are of the opinion that:

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- The proposal is desirable for the appropriate use of the land and building;
- The general intent and purpose of the City's Zoning Code and/or Bylaw are maintained and;
- The general intent and purpose of the Official Plan are maintained.

Home Owner Name: Sehar	Alamgir.	
Home Owner Address:_		

In regard to the 1 minor variance cited in the Committee of Adjustment notice, we are of the opinion that:

- The variance requested is minor in nature;
- The proposal is desirable for the appropriate use of the land and building;
- The general intent and purpose of the City's Zoning Code and/or Bylaw are maintained and;
- The general intent and purpose of the Official Plan are maintained.

Home Owner Name:	ド 丁	Toma	
Home Owner Address:			

In regard to the 1 minor variance cited in the Committee of Adjustment notice, we are of the opinion that:

- The variance requested is minor in nature;
- The proposal is desirable for the appropriate use of the land and building;
- The general intent and purpose of the City's Zoning Code and/or Bylaw are maintained and;
- The general intent and purpose of the Official Plan are maintained.

Home Owner Name: Ciry	ing Li	
Home Owner Address:		

In regard to the 1 minor variance cited in the Committee of Adjustment notice, we are of the opinion that:

- The variance requested is minor in nature;
- The proposal is desirable for the appropriate use of the land and building;
- The general intent and purpose of the City's Zoning Code and/or Bylaw are maintained and;
- The general intent and purpose of the Official Plan are maintained.

Therefore, we have no objections to the proposed new construction of the (2 storey above grade and 1 storey below grade) detached dwelling unit and support the application as submitted.

Home Owner Name

ydrak Lorana Wydryk

Home Owner Address:

In regard to the 1 minor variance cited in the Committee of Adjustment notice, we are of the opinion that:

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- The proposal is desirable for the appropriate use of the land and building;
- The general intent and purpose of the City's Zoning Code and/or Bylaw are maintained and;
- The general intent and purpose of the Official Plan are maintained.

Home Owner Name:	Jennifer	Duhamel	
Home Owner Address:	-		