

LOCATED FOR THIS PLAN.

ALL DISTANCES SHOWN HEREON ARE IN METRES AND CAN BE CONVERTED INTO FEET BY DIVIDING BY 0.3048.

METRIC NOTE

GRAPHIC SCALE - METRES SCALE 1: 200

DENOTES SANITARY SEWER

DENOTES U/G WATER MAIN

DENOTES LITHLITY POLE / IGHT STANDAR

DENOTES STORM SEWER

ON 22nd DAY OF DECEMBER, 2010.

ROBERT D. McCONNELL

ONTARIO LAND SURVEYOR

NO PERSON MAY COPY, REPRODUCE, DISTRIBUTE OR ALTER THIS PLAN IN WHOLE OR

IN PART WITHOUT THE WRITTEN PERMISSION OF CUNNINGHAM McCONNELL LIMITED

(W) DENOTES PROPOSED WATER METER

---- DENOTES PROPOSED TREE HOARDING


DENOTES DOWNSPOUT C/W SPLASHPAD

S DENOTES PROPOSED SUMP PIT

CONSTRUCTION, UNTIL APPROVAL TO REMOVE IS OBTAINED FROM DEVELOPMENT AND DESIGN.

T-BAR SUPPORTS FOR SOLID HOARDING WILL ONLY BE ALLOWED WITH THE APPROVAL FROM DEVELOPEMENT AND DESIGN.

4. DO NOT ALLOW WATER TO COLLECT AND POND BEHIND OR WITHIN HOARDING

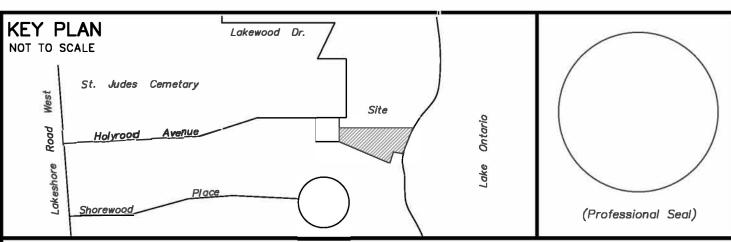

STANDARD DEVELOPMENT NOTES

(A) ENGINEERING AND CONSTRUCTION DEPARTMENT

- DRIVEWAYS ON THE MUNICIPAL RIGHT-OF-WAY SHALL BE PAVED BY THE APPLICANT.
- 2. AT THE ENTRANCES TO THE SITE, THE MUNICIPAL CURB AND SIDEWALK WILL BE CONTINUOUS THROUGH THE DRIVEWAY AND A CURB DEPRESSION WILL BE PROVIDED FOR THE ENTRANCE.
- . THE TOPS OF ANY CURBS BORDERING THE DRIVEWAYS WITHIN THE MUNICIPAL BOULEVARD WILL BE FLUSH WITH THE MUNICIPAL SIDEWALK AND ROAD CURB.

(B) GENERAL NOTES

- THE EXISTING GRADES SHOWN ON THIS DRAWING ARE TO REMAIN UNCHANGED.
- . THERE IS AN EASEMENT REGISTERED ON TITLE AND AFFECTING THE SUBJECT LANDS.
- 3. THE STOCKPILING OF CONSTRUCTION MATERIAL TO BE DONE AT THE SIDE OF THE PROPOSED DWELLING ON PROPOSED DRIVEWAY.
- 4. ALL ROOF DOWNSPOUTS FROM EAVESTROUGH TO DISCHARGE ONTO SURFACE AND THE RUNOFF DIRECTED TOWARDS THE REAR WHERE POSSIBLE AND TO THE ROAD.
- . ROOF DOWNSPOUT IS LOCATED IN SUCH MANNER AS TO DIRECT DRAINAGE AWAY FROM WALKWAYS, DRIVEWAYS OR PATIO AREAS. 5. MAINTAIN EXISTING GRADES IN AREA AROUND TREES TO BE PRESERVED.
- . PRIOR TO CONSTRUCTION, CONTRACTOR TO VERIFY IN FIELD THE EXACT SIZE AND INVERTS OF THE EXISTING WATER SERVICE
- CONNECTION AND SEWER CONNECTIONS AND REPORT IT TO THE ENGINEER. B. ALL SURPLUS/EXCAVATED MATERIAL TO BE REMOVED FROM THE SITE.
- 9. CONTRACTOR TO MATCH EXISTING GRADES ALONG PROPERTY LINES.). ALL DISTURBED AREAS WITHIN EXISTING ROAD ALLOWANCE TO BE REINSTATED WITH TOPSOIL AND SOD
- TO THE SATISFACTION OF THE TOWN OF OAKVILLE. . THE CONTRACTOR IS TO CHECK AND VERIFY ALL DIMENSIONS, IF ANY DISCREPANCIES, THEY MUST BE REPORTED TO THE ENGINEER
- IMMEDIATELY PRIOR TO CONSTRUCTION. . THE CONTRACTOR IS RESPONSIBLE FOR LOCATING AND PROTECTING ALL UTILITIES DURING CONSTRUCTION. GAS, HYDRO, TELEPHONE OR ANY OTHER UTILITIES THAT MAY EXIST ON THE SITE OR WITHIN THE STREETLINE MUST BE LOCATED BY
- ITS OWN UTILITIES AND VERIFIED PRIOR TO CONSTRUCTION. 3. ALL CONNECTIONS SHALL BE INSTALLED AS PER REGIONAL STANDARDS AND SPECIFICATIONS.
- 4. BUILDER IS TO VERIFY TO THE ENGINEER THAT THE FINAL FOOTING ELEVATION AND TOP OF FOUNDATION WALL ELEVATION ARE IN CONFORMITY WITH THE BUILDING CODE AND THE CERTIFIED GRADING PLAN PRIOR TO PROCEEDING.
- . Outside finished grade to be a miniumum of 150 mm below brick/stone veneer elevation. 3. PRIOR TO ANY SODDING, THE BUILDER IS TO ENSURE TO THE SOIL CONSULTANT AND/OR THE ENGINEER THAT THE LOT HAS BEEN
- GRADED AND TOPSOILED AND SODDED COMPLETELY WITH A MINIMUM DEPTH OF 100 mm OF TOPSOIL AND N° 1 NURSURY SOD AND A MINIMUM DEPTH OF 150 mm CRUSHED STONE TO BE PROVIDED ON THE ENTIRE LENGTH OF EACH DRIVEWAY ON A FIRM SUBGRADE
- AND THE DRIVEWAY TO BE PAVED WITH A MINIMUM COMPACTED DEPTH OF 75 mm OF ASPHALT BETWEEN THE CURB AND THE GARAGE.
- . NO SODDING ON ANY LOT IS PERMITTED UNTIL PRELIMINARY INSPECTION IS DONE BY THE ENGINEER AND THE BUILDER.
- 8. DRIVEWAY GRADES SHOULD BE NOT LESS THAN 2.0% AND NOT GREATER THAN 7.0%. 9. LAWN AND SWALES SHALL HAVE MINIMUM SLOPE OF 2.0% AND A MAXIMUM SLOPE OF 5.0%.
- D. WHERE GRADES IN EXCESS OF 5% ARE REQUIRED, THE MAXIMUM SLOPE SHALL BE 3:1. GRADE CHANGES IN EXCESS OF 1.0m ARE TO BE ACCOMPLISHED BY USE OF A RETAINING WALL. RET. WALLS HIGHER THAN 0.6m SHALL HAVE A FENCE INSTALLED ON THE HIGH SIDE.
- . THE SERVICE CONNECTION TRENCH THROUGH THE TRAVELLED PORTION OF THE ROAD ALLOWANCE SHALL BE BACKFILLED WITH UNSHRINKABLE BACKFILL MATERIAL AS PER TOWN OF OAKVILLE STANDARDS UNLESS OTHERWISE SPECIFIED PRIOR APPROVAL FOR OTHER BACKFILL MATERIAL HAS BEEN OBTAIN.
- 2. ALL WATERMAINS AND WATER SERVICE MATERIALS AND CONSTRUCTION METHODS MUST CORRESPOND TO CURRENT REGION OF HALTON 3. WATERMAINS AND/OR WATER SERVICES ARE TO HAVE A MINIMUM DEPTH OF 1.7 m WITH A MINIMUM HORIZONTAL SPACING
- OF 1.5 m FROM THEMSELVES AND OTHER UTILITIES AND 2.5m MINIMUM FROM ALL SEWERS.
- 24. SEDIMENT CONTROL FENCE TO BE INSTALLED AS PER THE TOWN OF OAKVILLE STANDARDS. 25. ALL DAMAGED AND DISTURBED AREAS TO BE REINSTATED WITH TOPSOIL AND SOD.

(C) UTILITIES CONNECTION

- . SANITARY: (A) MUNICIPAL SANITARY SEWER AVAILABLE ON THE SITE. (B) EXISTING CONNECTION TO REMAIN UNCHANGED.
- 2. STORM: (A) MUNICIPAL STORM SEWER NOT AVAILABLE ON THE SITE.
- (B) PROPOSED SUMP PUMP TO DISCHARGE TO EXISTING STORM CHANNEL
 - (A) EXISTING 20mmø SERVICE CONNECTION (PUBLIC-SIDE) TO BE ABANDONED AND REPLACED WITH 25mmø TYPE K SOFT COPPER AS PER REGION OF HALTON STANDARDS. REFER TO SERVICE CONNECTION DETAIL.
 - (B) SERVICE CONNECTIONS (PRIVATE-SIDE) TO BE 32mmø TYPE 'K' SOFT COPPER TUBING AS PER TOWN OF OAKVILLE STANDARDS.

SITE STATISTICS - ZONE RL3-0

ZONING BY-LAW 2014-014

1. LOT AREA = 2,853 m2 (557.5 m2. Minimum). 2. LOT FRONTAGE = 22.51 m (18.00 m Minimum).

5. ESTABLISHED GRADE = 83.70 m.

REGION OF HALTON CERTIFICATE

REGION DESIGN OF WATER AND/OR WASTEWATER SERVICES APPROVAL SUBJECT TO DETAIL CONSTRUCTION CONFORMING TO HALTON REGION STANDARDS & SPECIFICATIONS & LOCATION APPROVAL FROM AREA MUNICIPALITY.

SIGNED: _____ DATED: _____

INFRASTRUCTURE PLANNING & POLICY

The approval of the water system on private property is the responsibility of the Local Municipality, regardless, the Appliicant must ensure that the Region of Halton's standards and specifications are met, (the water and wastewater Linear Design Manual may be obtained on Halton,ca or by calling 311)

All water quality tests must be completed to the Region of Halton's satisfaction, before the water supply can be turned on.

MIGRATORY BIRD NOTE ADDED SILT FENCE DETAILS ADDED REVISED AS PER TOWN COMMENTS REVISED AS PER REGION COMMENTS REVISED DWELLING DESIGN REVISED AS PER TOWN COMMENTS

ISSUED FOR DESIGN


REVISIONS


OAKVILLE SITE PLAN

N° 26 HOLYROOD AVENUE,

SITE GRADING AND SERVICING PLAN DATE: APRIL 8, 2024 SCALE 1: 200

REGIONAL DRAWING N°_____ PLAN N° 165-10-1

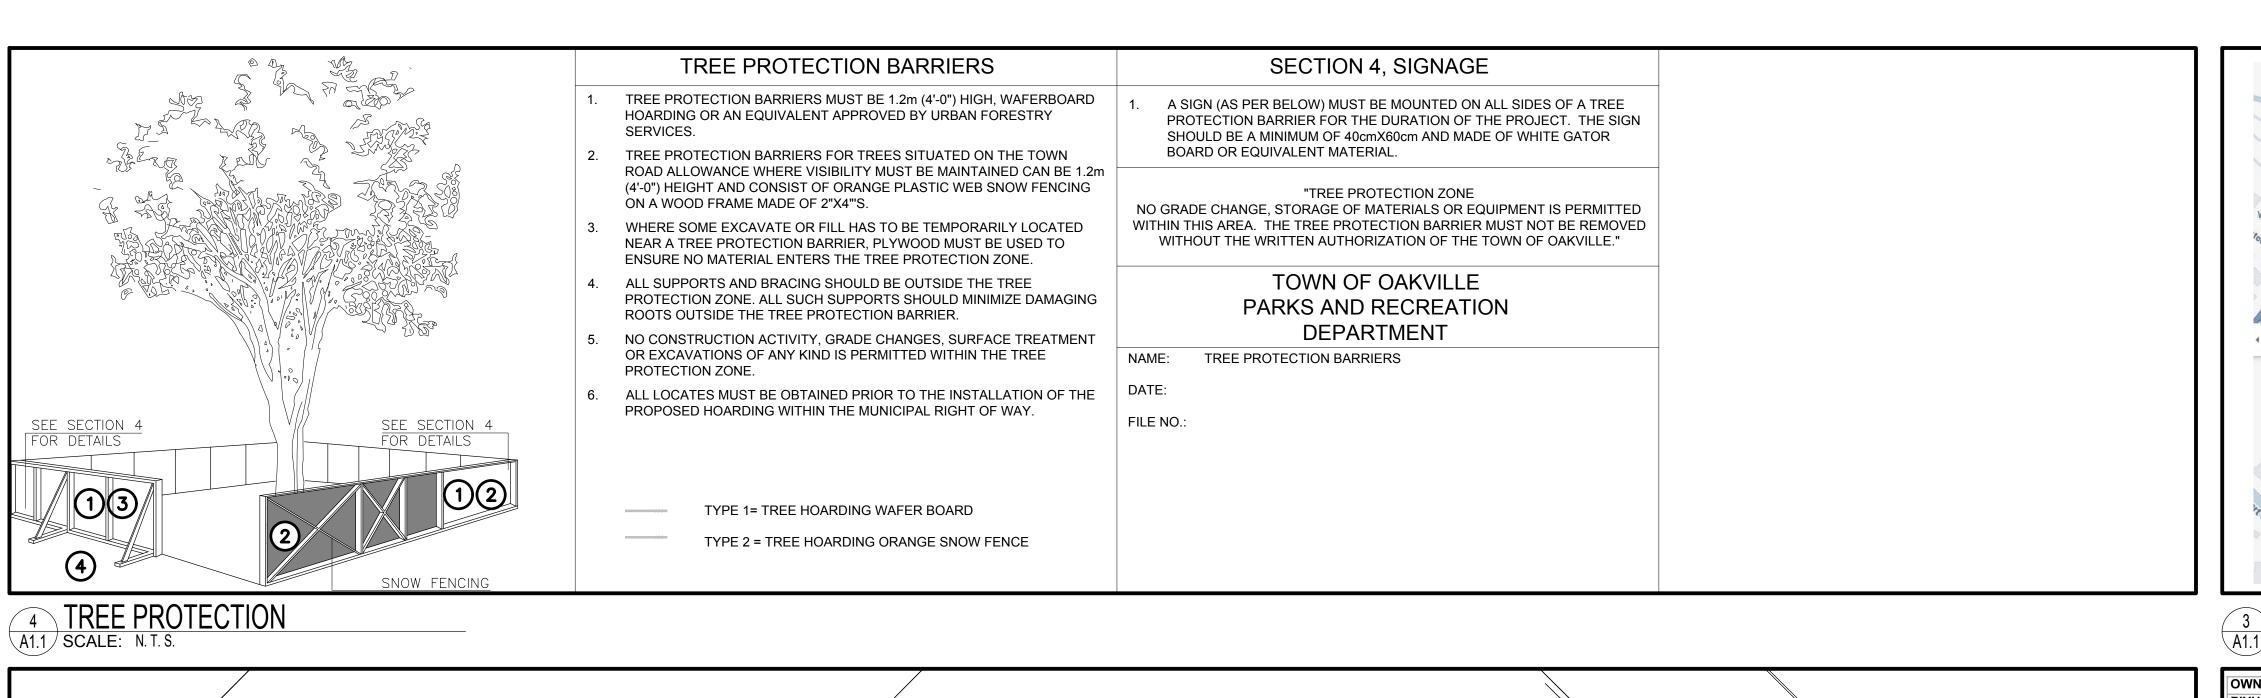

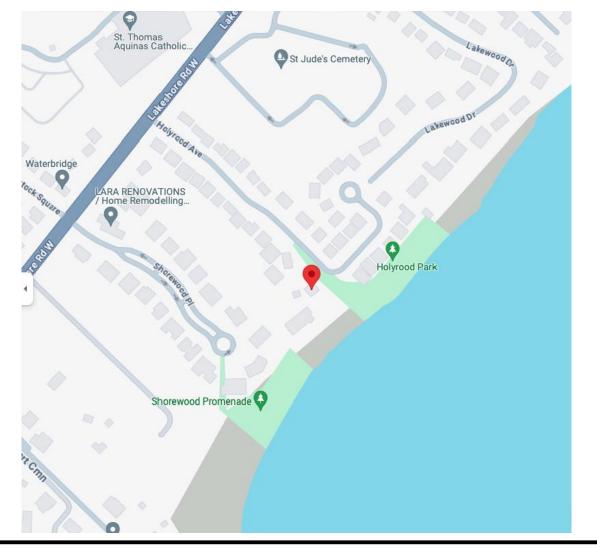

REGISTRATION INFORMATION

Drawings must NOT be scaled. Contractor must check and verify all dimensions, specifications and drawings on site and report any discrepancies to the architect prior to

proceeding with any of the work.

SITE LEGEND:

PROPERTY LINE

EXISTING GRADE

FINISHED GRADE

MAIN ENTRANCE

SECONDARY ENTRANCE

TREE HOARDING

EXISTING STRUCTURES TO BE REMOVED

BORE HOLE LOCATION & No. PER SOILS REPORT

ROOF DOWNSPOUT LOCATION, DISCHARGE ON 600X600 CONC. PAVER
PROPOSED DIMENSIONS TO NEW STRUCTURES

05 EXISTING STING DIMENSIONS TO EXISTING STRUCTUR

S NEW SUMP WITH DISCHARGE DIRECTION

EXISTING TREE TO REMAIN -DASHED LINE INDICATES TPZ (TRE

EXISTING TREE TO BE REMOVED

EXISTING TREE TO BE REMAIN.

REGION OF HALTON CERTIFICATE

REGION DESIGN OF WATER AND/OR WASTEWATER SERVICES

TO HALTON REGION STANDARDS AND SPECIFICATIONS AND

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egion of Halton's satisfaction, before the water supply can be

4 | 05.21.24 | REISSUED FOR C OF A

1 01.24.24 ISSUED FOR C OF A

REF. DATE: DESCRIPTION:

REVISIONS / ISSUANCE:

THE PATEL

DRAWING TITLE:

DRAWN: J.W.H

JOB NUMBER:

DATE: 01.24.24

24-064

ADDRESS: 26 HOLYROD DR

OAKVILLE

SCALE: 1:200 SHEET NUMBER:

A1.1

04.06.24 REISSUED FOR C OF A

02.06.24 ISSUED FOR CONSERVATION

epartment at 905-825-6032).

PPROVED SUBJECT TO DETAIL CONSTRUCTION CONFORMING

TREE NUMBER PER ARBOURIST REPORT


PROTECTION ZONE PER ARBOURIS

FINISHED FLOOR ELEVATION FINISHED BASEMENT ELEVATION FINISHED DECK ELEVATION


S Dwell Inc.

3 KEY PLAN A1.1 SCALE: N. T. S.




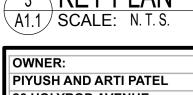

1 SITE STATISTICS
A1.1 SCALE: N.T.S.

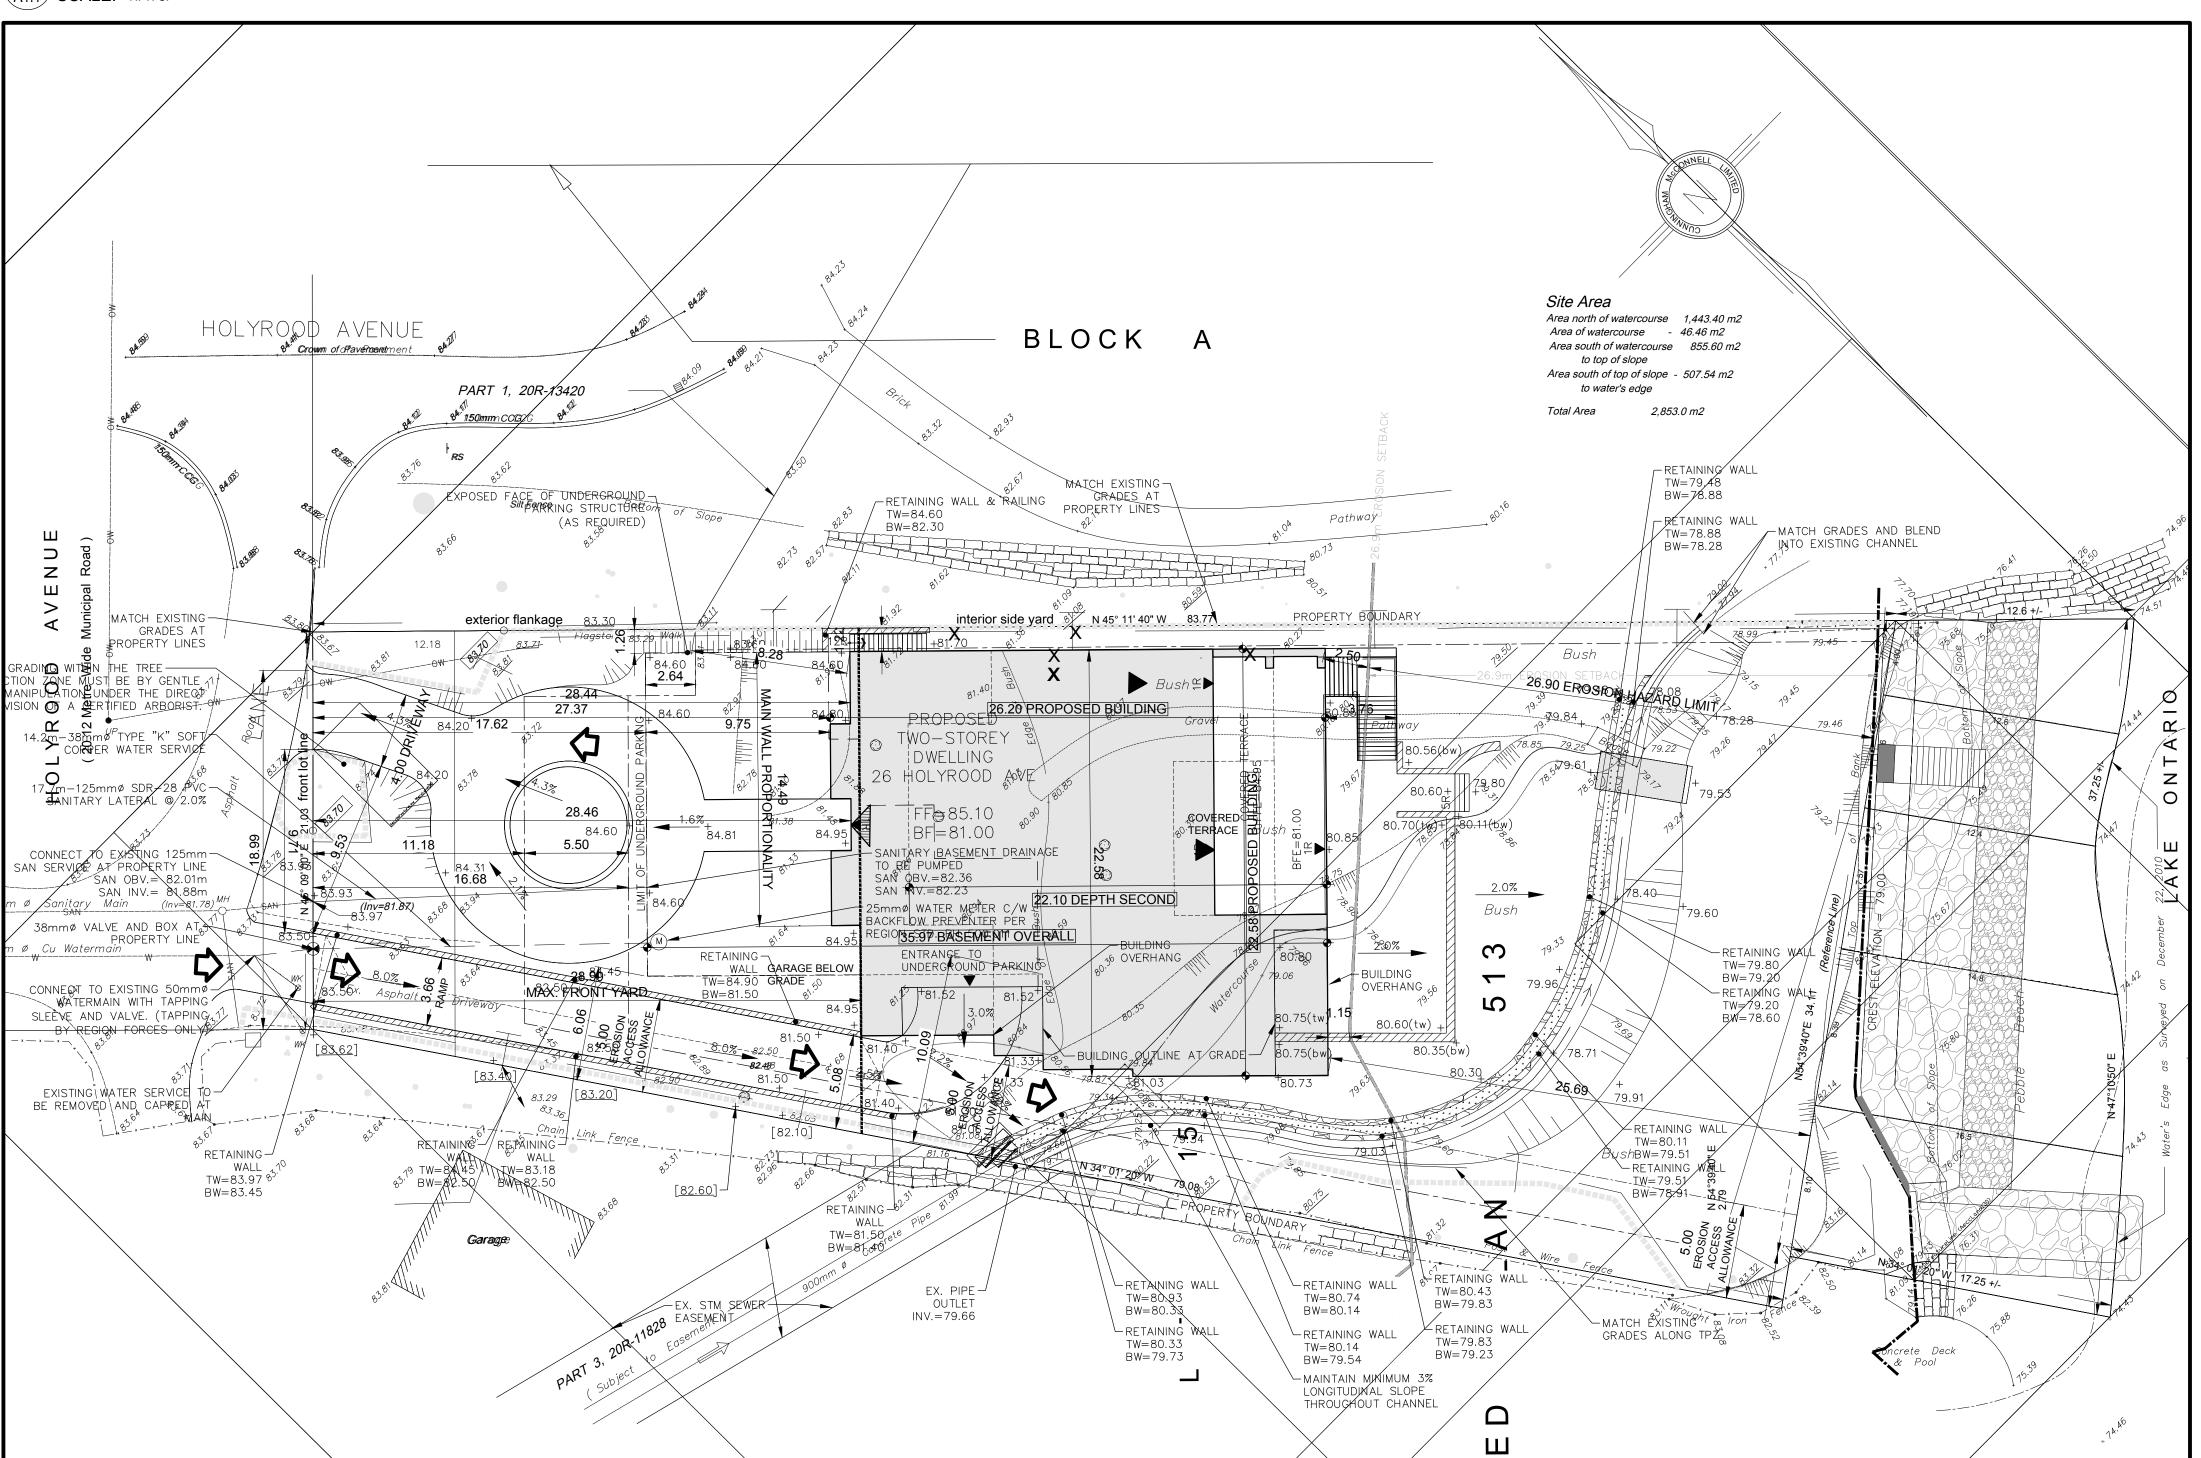

3 SITE PLAN A1.1 SCALE: 1:200

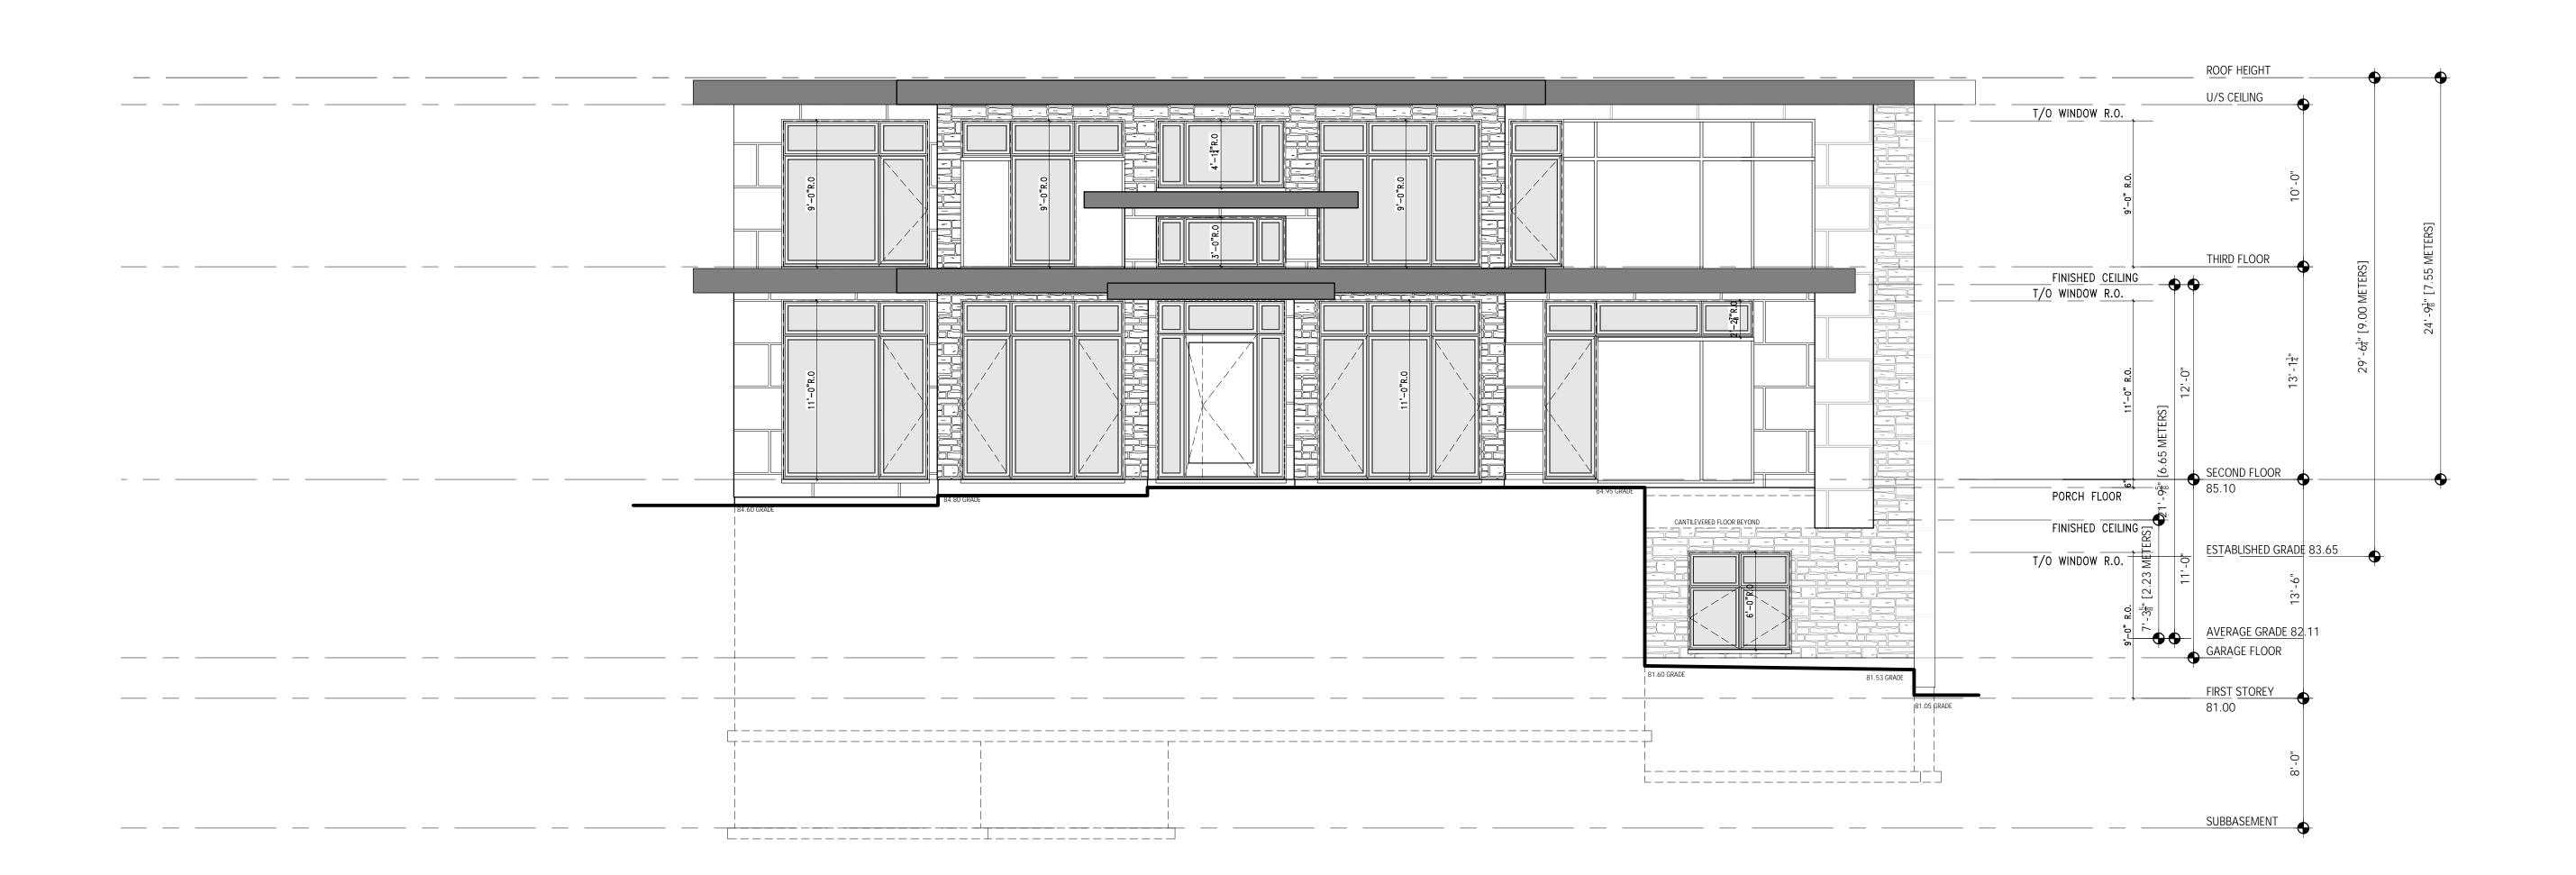

CITY OF MISSISSAUGA STAMP:

e undersigned has reviewed and takes resposibility for the sign, and has the qualifications and meets the requirements set in the Ortano Building Code to be a designer.

QUALIFICATION INFORMATION

uired unless design is exempt under 2.17.5.1 of the building code as SON HUETHER

SIGNATURE

BCIN

REGISTRATION INFORMATION

uired unless design is exempt under 2.17.5.1 of the building code and uired unless design is exempt under 2.17.5.1 of the building code and uired unless design is exempt under 2.17.5.1 of the building code DS Dwell Inc.

118699

RM NAME

BCIN

Drawings must NOT be scaled. Contractor must check and verify all dimensions, specifications and drawings on site and report any discrepancies to the architect prior to proceeding with any of the work.

2 02.06.24 ISSUED FOR CONSERVATION
1 01.24.24 ISSUED FOR C OF A
REF. DATE: DESCRIPTION:
REVISIONS / ISSUANCE:



HDS DWELL INC.

20 GILMOUR ROAD, PUSLINCH ON, CAN NOB 2J0
WWW.HDSDWELL.CA T.(226)979-4493

CLIENT: THE PATEL RESIDENCE

DDRESS: 26 HOLYROD


ADDRESS: 26 HOLYROD DR CITY: OAKVILLE

DRAWING TITLE:

NORTH

FLEVATION

DRAWN:	J.W.H		
DATE:	01.24.24	SCALE:	3/16"=1'-0"
JOB NUMBER:		SHEET NUMBER:	
24-064			A4.1
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WWW.HDSDWELL.CA T.(226)979-4493

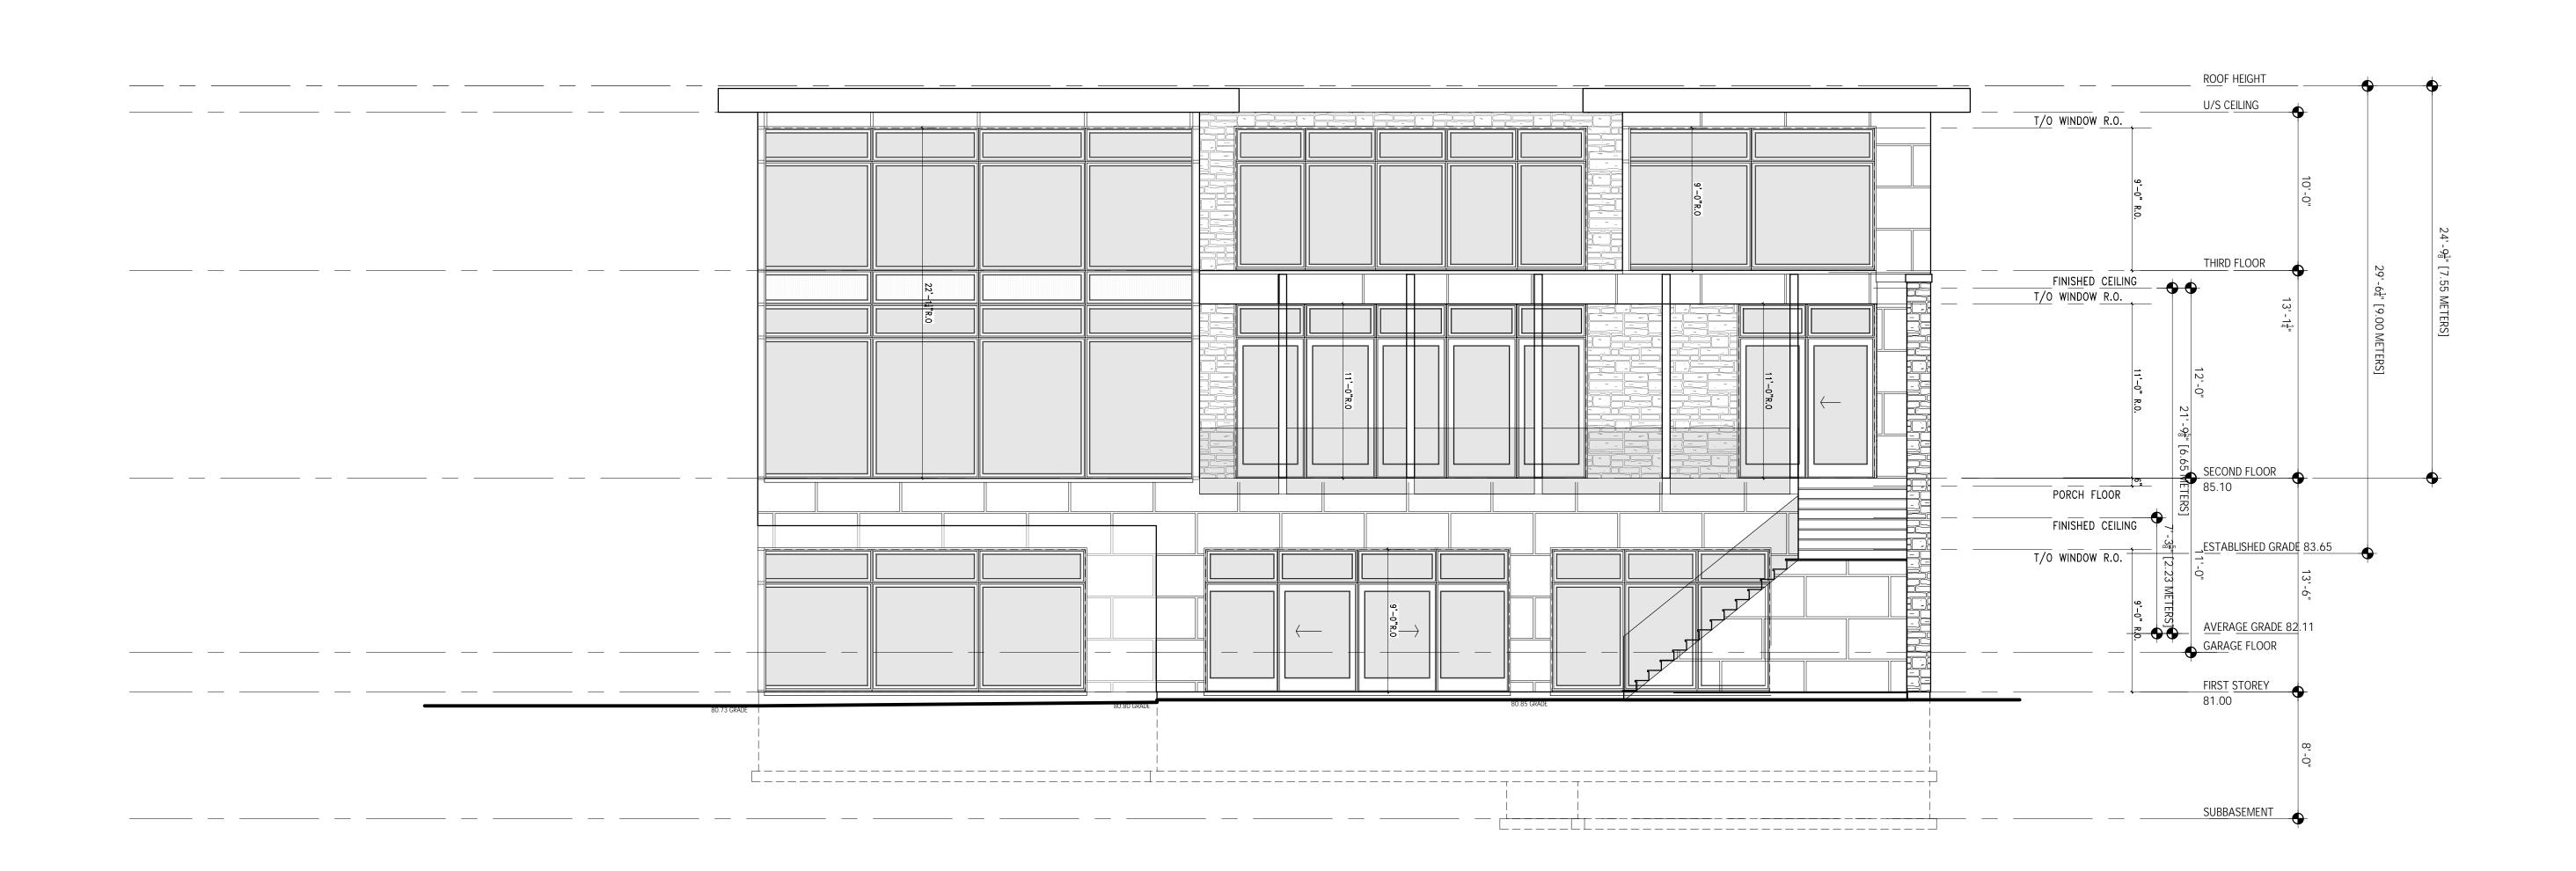CLIENT: THE PATEL RESIDENCE

ADDRESS: 26 HOLYROD DR CITY: OAKVILLE DRAWING TITLE:

DRAWN: J.W.H


DATE: 01.24.24 SCALE: 3/16"=1'-0"

JOB NUMBER: SHEET NUMBER: 24-064

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ASON HUETHER

39381

AME

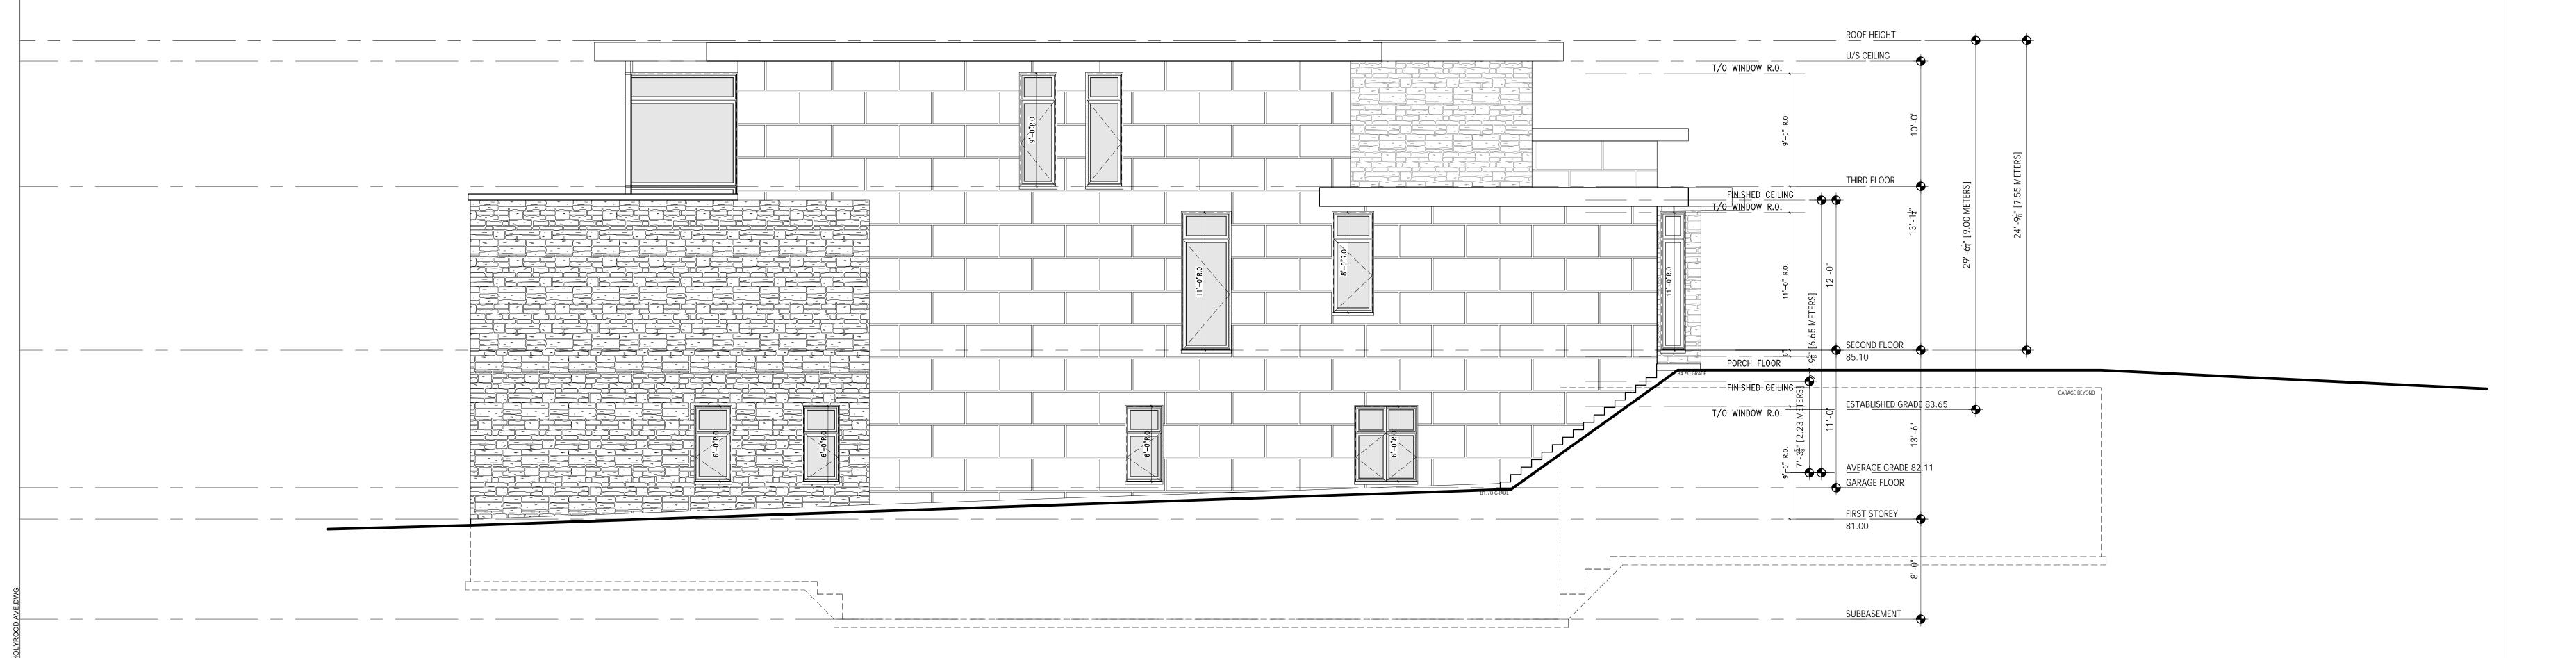SIGNATURE

BCIN

REGISTRATION INFORMATION

quired unless design is exempt under 2.17.5.1 of the building code


105 DWell Inc.

118699

IRM NAME

BCIN

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2 02.06.24 ISSUED FOR CONSERVATION
1 01.24.24 ISSUED FOR C OF A
REF. DATE: DESCRIPTION:
REVISIONS / ISSUANCE:

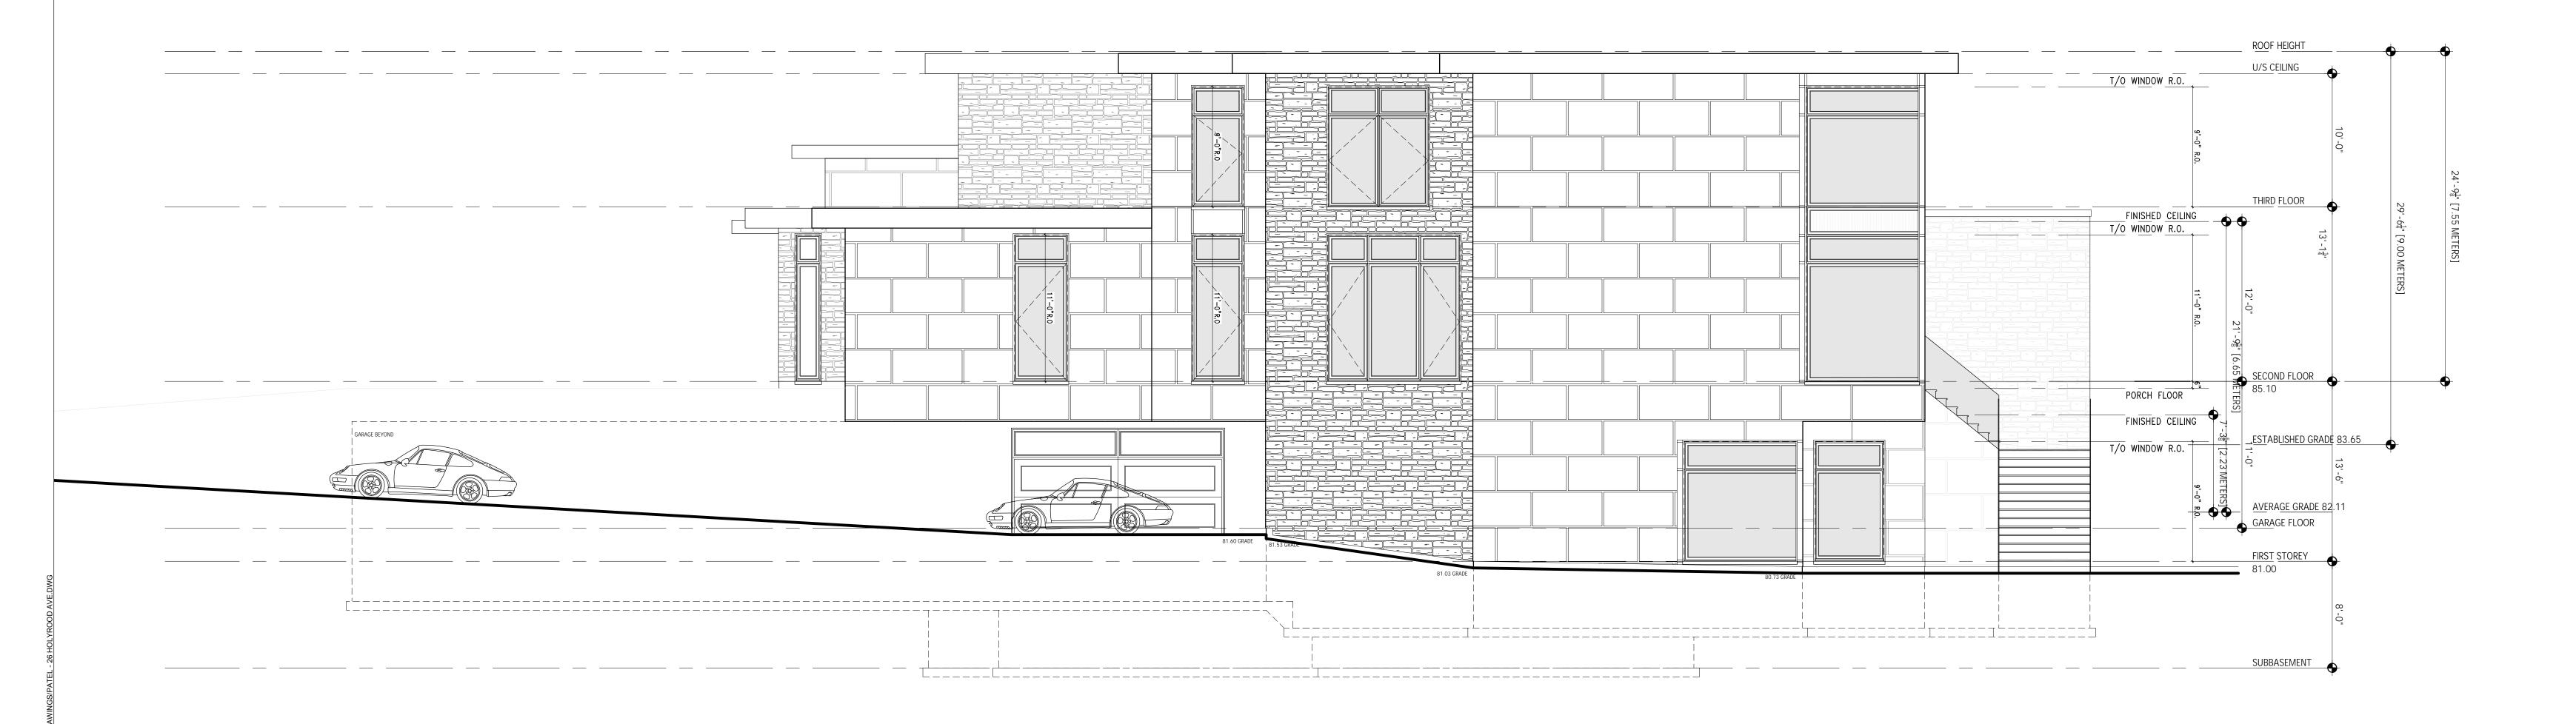

HDS DWELL INC.

20 GILMOUR ROAD, PUSLINCH ON, CAN NOB 2J0

WWW.HDSDWELL.CA T.(226)979-4493

CLIENT: THE PATEL RESIDENCE

ADDRESS: 26 HOLYROD DR CITY: OAKVILLE DRAWING TITLE:

DRAWING TITLE:
WEST
ELEVATION

DRAWN: J.W.H

DATE: 01.24.24 | SCALE: 3/16"=1'-0"

JOB NUMBER: SHEET NUMBER:

24-064 | A 4.4



VARIANCE RATIONALE FOR 26 HOLYROD AVE, OAKVILLE, ON

We are the Designers assisting the Owner of the property known as 26 Holyrod Ave with their new 2 storey dwelling and we are requesting some Minor variances connected to the property. The variances requested are listed below along with a brief rationale.

VARIANCES REQUIRED - RL3-0 ZONING

FLANKAGE YARD SETBACK - Required 3.5m, Proposed 1.26 to an underground garage

MAXIMUM FRONT YARD SETBACK - Required 16.68m, Proposed 28.99m

PROJECTING GARAGE - Allowable 1.5m., Proposed 20.89m

3 STOREYS WHERE 2 ARE PERMITTED - Permitted is 2 stories, proposed is 3 stories

FLOOR AREA ABOVE THE 2ND STOREY - Permitted is 0 sqm, proposed is 276 sql

DRIVEWAY SETBACK TO SECOND DRIVEWAY - Permitted 11.2m, Proposed 18.99m

GARAGE AREA - Permitted 45sqm, Proposed 261sqm

MAX RESIDENTIAL FLOOR AREA - Permitted 29% or 826,2sam, Proposed 1145sam

REASONS FOR VARIANCE:

EXTERIOR SIDE YARD SETBACK - Required 3.5m, Proposed 1.26 to an underground garage

This is a rather odd shaped lot. What appears to be an interior side yard setback is actually an exterior side yard up until a point it intersects the park block lot line, where is switches back to an interior side yard. We are proposing a setback of a small square of underground garage that is 1.26m from the exterior lot lien versus 3.5m required. This is a below grade structure and this condition on applies for a length of 2.64m after which is complies.

MAXIMUM FRONT YARD SETBACK - Required 16.68m, Proposed 28.99m

The house is pushed back on the lot given its lake front location. This also helps better align the home with the neighbouring properties. The lot had a previous house and the required minimum front yard would have been 11.18m. The required max to the front main wall will be 28.99 as we have the house deeper on the lot thus beyond the allowable max setback. This allows us to comply with a required 5.0m conservation setback and sets the house back further from the corner road.

PROJECTING GARAGE - Permitted is 1.5m, Proposed 20.89m

This is a very technical variance given the garage is located entirely underground beneath the earth surface. The first storey of the dwelling is actually what would normally be classified as a basement (again technicality based in established grade) the garage projects 20.89m from the longest main floor exterior wall beneath grade. This has no affect whatsoever on neighbouring properties and is invisible from the street as it is all below grade.

3 STOREYS WHERE 2 ARE PERMITTED - Permitted is 2 stories, proposed is 3 stories

The lot in its natural state slopes drastically from the street front to the lake, with a large overland flow south along the west side. Given the slope, the technical definition for a storey based on established grade now makes the basement walkout (which exists naturally) as the first storey. The house is a 2 storey home from the street, but based on the OBC definition, it must be classified as a 3 storey home.

FLOOR AREA ABOVE THE 2ND STOREY - Permitted is 0sqm, proposed is 276 sql

Similar to the variance above for 3 stories. The bylaw does note permit GFA above a second storey. Since we are technically classified as 3 stories our proposed second floor of 276sqm is above the second storey. The house is a 2 storey in design and complies with height. It is a technical variances based on the natural lot slope to the lake.

DRIVEWAY SETBACK TO SECOND DRIVEWAY - Permitted 11.2m, Proposed 18.99m

Again a rather technical variance for the main driveway into the front door, based on bylaw required dimensions. The driveway is a long way away from the actual intersection given the park lot next to us, which is the intent of this measurement.

GARAGE AREA - Permitted 45sqm, Proposed 261sqm

Again this variance is rather technical in nature as the entire garage is accessed from a ramp and is buried below grade. Given the designation as 3 stories the basement (and the garage) are now classified as the first floor and are thus required to be included. Were this not a natural walkout lot, and we proposed the full underground garage, it would not require a variance as it would be in the basement.

RESIDENTIAL FLOOR AREA - Permitted 29% or 826.30sqm, Proposed 1145sqm

Again this variance is rather technical in nature given the requirement to classify the home as 3 stories. With this designation the basement is now classified as the first storey/ floor and is thus required to be included in the total GFA. Were this not a natural walkout lot, and we proposed the same finished basement, it would not require a variance as it would be in the basement. The house as viewed from the street is 2 stories and those natural 2 stories comply with the 29% at 743 sql in fact it is significantly less. The basement can only bee seen from the lake and the additional GFA is out of site from all neighbouring dwellings. It is essentially below grade where the additional GFA exists and does not make the home feel larger as a result.

Why this application meets the four tests.

Are the variances Minor In Nature?

The variances as requested are minor in nature, there is no cumulative affect to the requested variances and they do not pose impacts on the neighbouring homes, as this home is bordered for the most part by a town park block and the lakefront

Is the proposal desirable and appropriate?

The new home is in keeping with the scale, size and character for the neighbourhood. This house will sit gently on this lakefront property and takes advantage of the odd shaped lot in order to conceal major portions of the home

Is it in keeping with the general Intent of the Zoning Bylaw? Is it in keeping with the general Intent of the Official Plan?

The requested variances are minor in nature and will not pose impacts to surrounding homes. They do not create an overbuild for the site and the home sits comfortably on this lakefront lot.

Thank you very much. If you have any questions at all please feel free to reach out via phone or email below.

Yours truly,

Jason Huether HDS Dwell Inc. 226 979-4493 jhuether@hdsdwell.ca