

- A DRAINAGE LAYER IS REQUIRED FOR FOUNDATION WALLS. WHERE THE INTERIOR INSULATION EXTENDS MORE THAN 2'-11" BELOW EXTERIOR GRADE.
- 2. 2 COATS OF BITUMINOUS DAMPPROOFING ON 10" REINFORCED POURED CONCRETE WALLS.
- PROVIDE 1/4" PARGING COVED OVER POURED CONCRETE FOOTING.
 PROVIDE 2" x 3" WOOD STRAPPING @ 16" O.C. ON INTERIOR FACE OF CONCRETE FOUNDATION WALL, R-20 INSULATION W/ INTEGRAL VAPOUR BARRIER, FULL HEIGHT 1/2" GYPSUM BOARD TAPED, SANDED & PRIMED READY FOR PAINT.
- 5. CONT. 2" x 6" WOOD SILL PLATE FASTENED W/ 1/2" DIAMETER x 12" LONG ANCHOR BOLTS EMBEDDED 6" IN CONCRETE @ 6'-0" O.C. MAX. & PROVIDE A FLEXIBLE SILL GASKET BETWEEN PLATE AND FOUNDATION.

CUT STONE VENEER CONSTRUCTION

4" CUT STONE VENEER FACE WITH HAIR LINE JOINT BETWEEN STONE MODULES , 1" AIR SPACE, TYVEK HOUSE WRAP (AIR BARRIER/ MOISTURE BARRIER) , LAYERS TO OVERLAP, JOINTS TAPED & SEALED ON 1/2" DENSE GLASS GOLD SHEATHING ON 2" x 6" @ 16" O.C. SPR STUD WALLS W/ R-24 BATT INSULATION W/ VAPOUR BARRIER (WARM SIDE). DOUBLE TOP PLATE & SINGLE SOLE PLATE, 1/2" GYPSUM BOARD TAPED, SANDED & PRIMED, READY FOR PAINT FINISH.USE METAL WALL TIES FOR LARGE CUT STONE ANCHORAGE.

PROVIDE 0.03 THICK x 7/8" WIDE GALVANIZED METAL VENEER TIES @ 32" O.C. HORIZONTALLY AND 16" O.C. VERTICALLY FASTENED WITH CORROSION RESISTANT 0.125" DIAMETER SCREWS OR SPIRAL NAILS WHICH PENETRATE A MINIMUM OF 1-3/16" INTO STUD.

AT FOUNDATION WALLS PROVIDE 20 MIL POLY FLASHING MIN. 6" UP BEHIND SHEATHING PAPER WEEP HOLES, MINIMUM 2'-7" APART AT BOTTOM COURSE OF VENEER AND ABOVE ALL OPENINGS.

PREFINISHED ALUMINUM RAIN WATER LEADER (RWL)

COLOUR TO MATCH EAVESTROUGHING. INSTALL PREFINISHED CONDUCTOR HEADS ON FRONT ELEVATION AS PER DRAWING. DOWNSPOUTS NOT CONNECTED TO STORM SEWER SHALL HAVE EXTENSIONS TO CARRY WATER AWAY FROM THE BUILDING & PROVISIONS SHOULD BE MADE TO PREVENT SOIL EROSION AND DEVERT WATER TO SOFT LANDSCAPING AREAS. PROVIDE PRECAST CONCRETE SPLASH BLOCKS IF REQUIRED TO AVOID RAIN WATER DISCHARGING DIRECTLY ONTO DRIVEWAYS AND WALKWAYS.

CONCRETE PORCH

- ALLOW 4" BEARING FOR CONCRETE SLAB. PROVIDE DEEP POCKETS TO SUPPORT CONCRETE SLAB BY REMOVING EVERY 2ND PAIR OF FACE BRICKS WHEN BRICK FACING IS USED.
- 2. WHEN FACE BRICK IS USED ABOVE GRADE LEVEL, PROVIDE 3/16"
 DIAMETER CORROSION RESISTANT METAL TIES@ 36" HORIZONTALLY, 8"
 VERTICALLY.
- 3. MINIMUM 3/4" CLEAR CONCRETE TO COVER RE-BAR. STAIRS AND HANDRAILS TO CONFORM TO NOTES 29. & 30.

PRECASET CONCRETE SILL

30 SLOPED ROOF CONSTRUCTION:

ASPHALT SHINGLES ON 15 LB. BUILDING PAPER ON ½" EXTERIOR GRADE PLYWOOD SHEATHING ON PRE-ENGINEERED ROOF TRUSSES AS NOTED ON DRAWINGS. PROVIDE APPROVED EAVES PROTECTION TO MIN. 12" BEYOND INNER FACE OF EXTERIOR WALL. PROVIDE MIN. R40 BATT INSULATION W/ 6 MIL. POLY VAPOUR BARRIER (WARM SIDE- ABOVE CEILING) W/ 5%" GYPSUM BOARD. GYPSUM BOARD TO BE TAPED, SANDED AND PRIMED READY FOR PAINT FINISH. PROVIDE MIN. 1 SQ.FT. OF ROOF VENT AREA FOR EVERY 300 SQ.F.T OF INSULATED CEILING EVENLY DISTRIBUTED W/ MIN. 50% @EAVES.

BRICK VENEER CONSTRUCTION

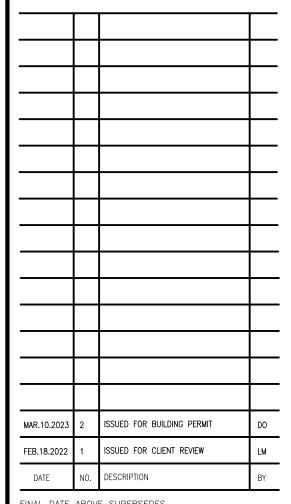
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FINAL DATE ABOVE SUPERSEDES ALL PREVIOUS ISSUES

REVISIONS

MEY TO DETAIL LOCATION

DETAIL NOTATION

DRAWING NUMBER

CONTRACTOR MUST CHECK AND VERIFY ALL DIMENSIONS
AND CONDITIONS ON THE JOB AND REPORT ANY
DISCREPANCIES TO THE ARCHITECTS BEFORE
PROCEEDING WITH THE WORK

DRAWINGS ARE NOT TO BE SCALED.



193 ROE AVENUE Toronto, ON M5M 2J1 Tel: (416) 781-6125 Web: WWW.SGM-ARCH.COM

326 SANDLEWOOD RD OAKVILLE, ON

CUSTOM HOME

LEFT SIDE ELEVATION

SCALE	1/4" = 1'-0"	
DRAWN	RS/DO	
CHECKED	LM	4.0
DATE	FEB.18.2022	A3-4
PROJ. NO.	2021-49	DRAWING NO



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ROOF SADDLE

PROVIDE STICK FRAME ROOF SADDLE CONSTRUCTION OVER PRE-FABRICATED ROOF TRUSS SYSTEM TO ENSURE POSITIVE DRAINAGE TO PERIMETER EAVES DRAINAGE

SLOPED ROOF CONSTRUCTION:

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BRICK VENEER CONSTRUCTION

4" BRICK FACE, 1" AIR SPACE, TYVEK HOUSE WRAP (AIR BARRIER/ MOISTURE BARRIER), LAYERS TO OVERLAP, JOINTS TAPED & SEALED ON 1/2" EXTERIOR GRADE PLYWOOD SHEATHING ON 2" x 6" @ 16" O.C. SPR STUD WALLS W/ R-20 BATT INSULATION W/ VAPOUR BARRIER (WARM SIDE). DOUBLE TOP PLATE & SINGLE SOLE PLATE, 1/2" GYPSUM BOARD TAPED, SANDED & PRIMED, READY FOR PAINT FINISH.

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MAR.10.2023	2	ISSUED FOR BUILDING PERMIT	DO
FEB.18.2022	1	ISSUED FOR CLIENT REVIEW	LM
DATE	NO.	DESCRIPTION	BY

ALL PREVIOUS ISSUES

KEY TO DETAIL LOCATION DETAIL NOTATION
DRAWING NUMBER

AND CONDITIONS ON THE JOB AND REPORT ANY DISCREPANCIES TO THE ARCHITECTS BEFORE PROCEEDING WITH THE WORK DRAWINGS ARE NOT TO BE SCALED.



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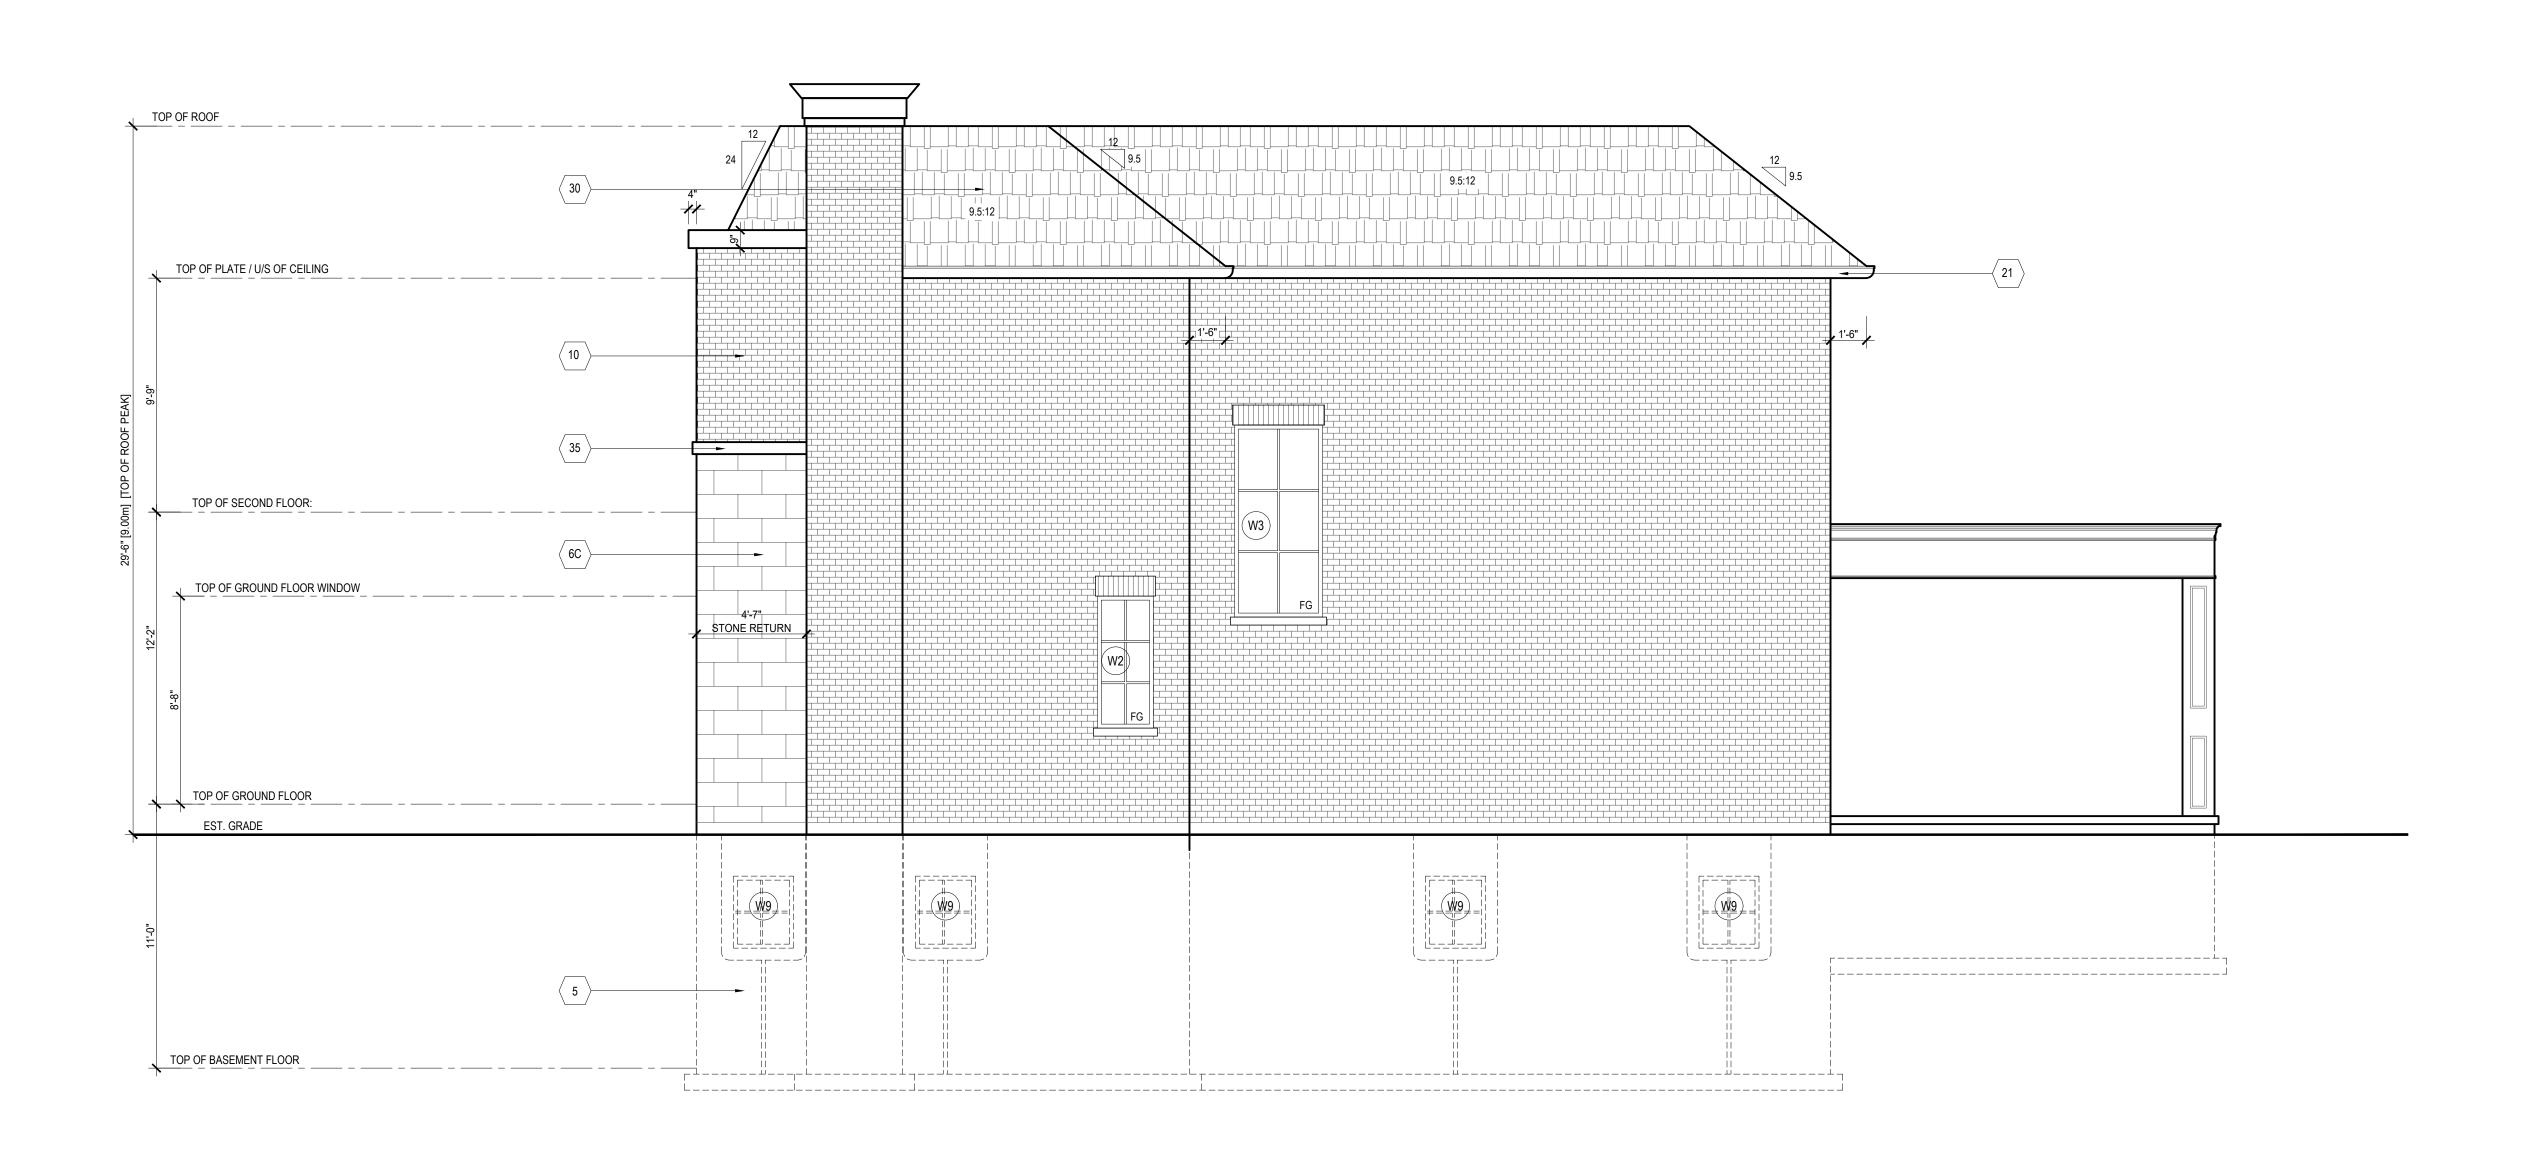
326 SANDLEWOOD RD OAKVILLE, ON

CUSTOM HOME

REAR ELEVATION

	1/4" = 1'-0"	SCALE
	RS/DO	DRAWN
Λ.	LM	CHECKED
A,	FEB.18.2022	DATE
	2024 40	

2021-49 DRAWING NO



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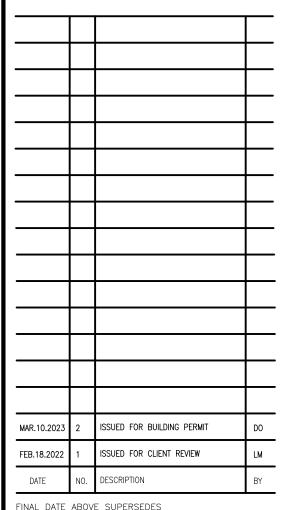
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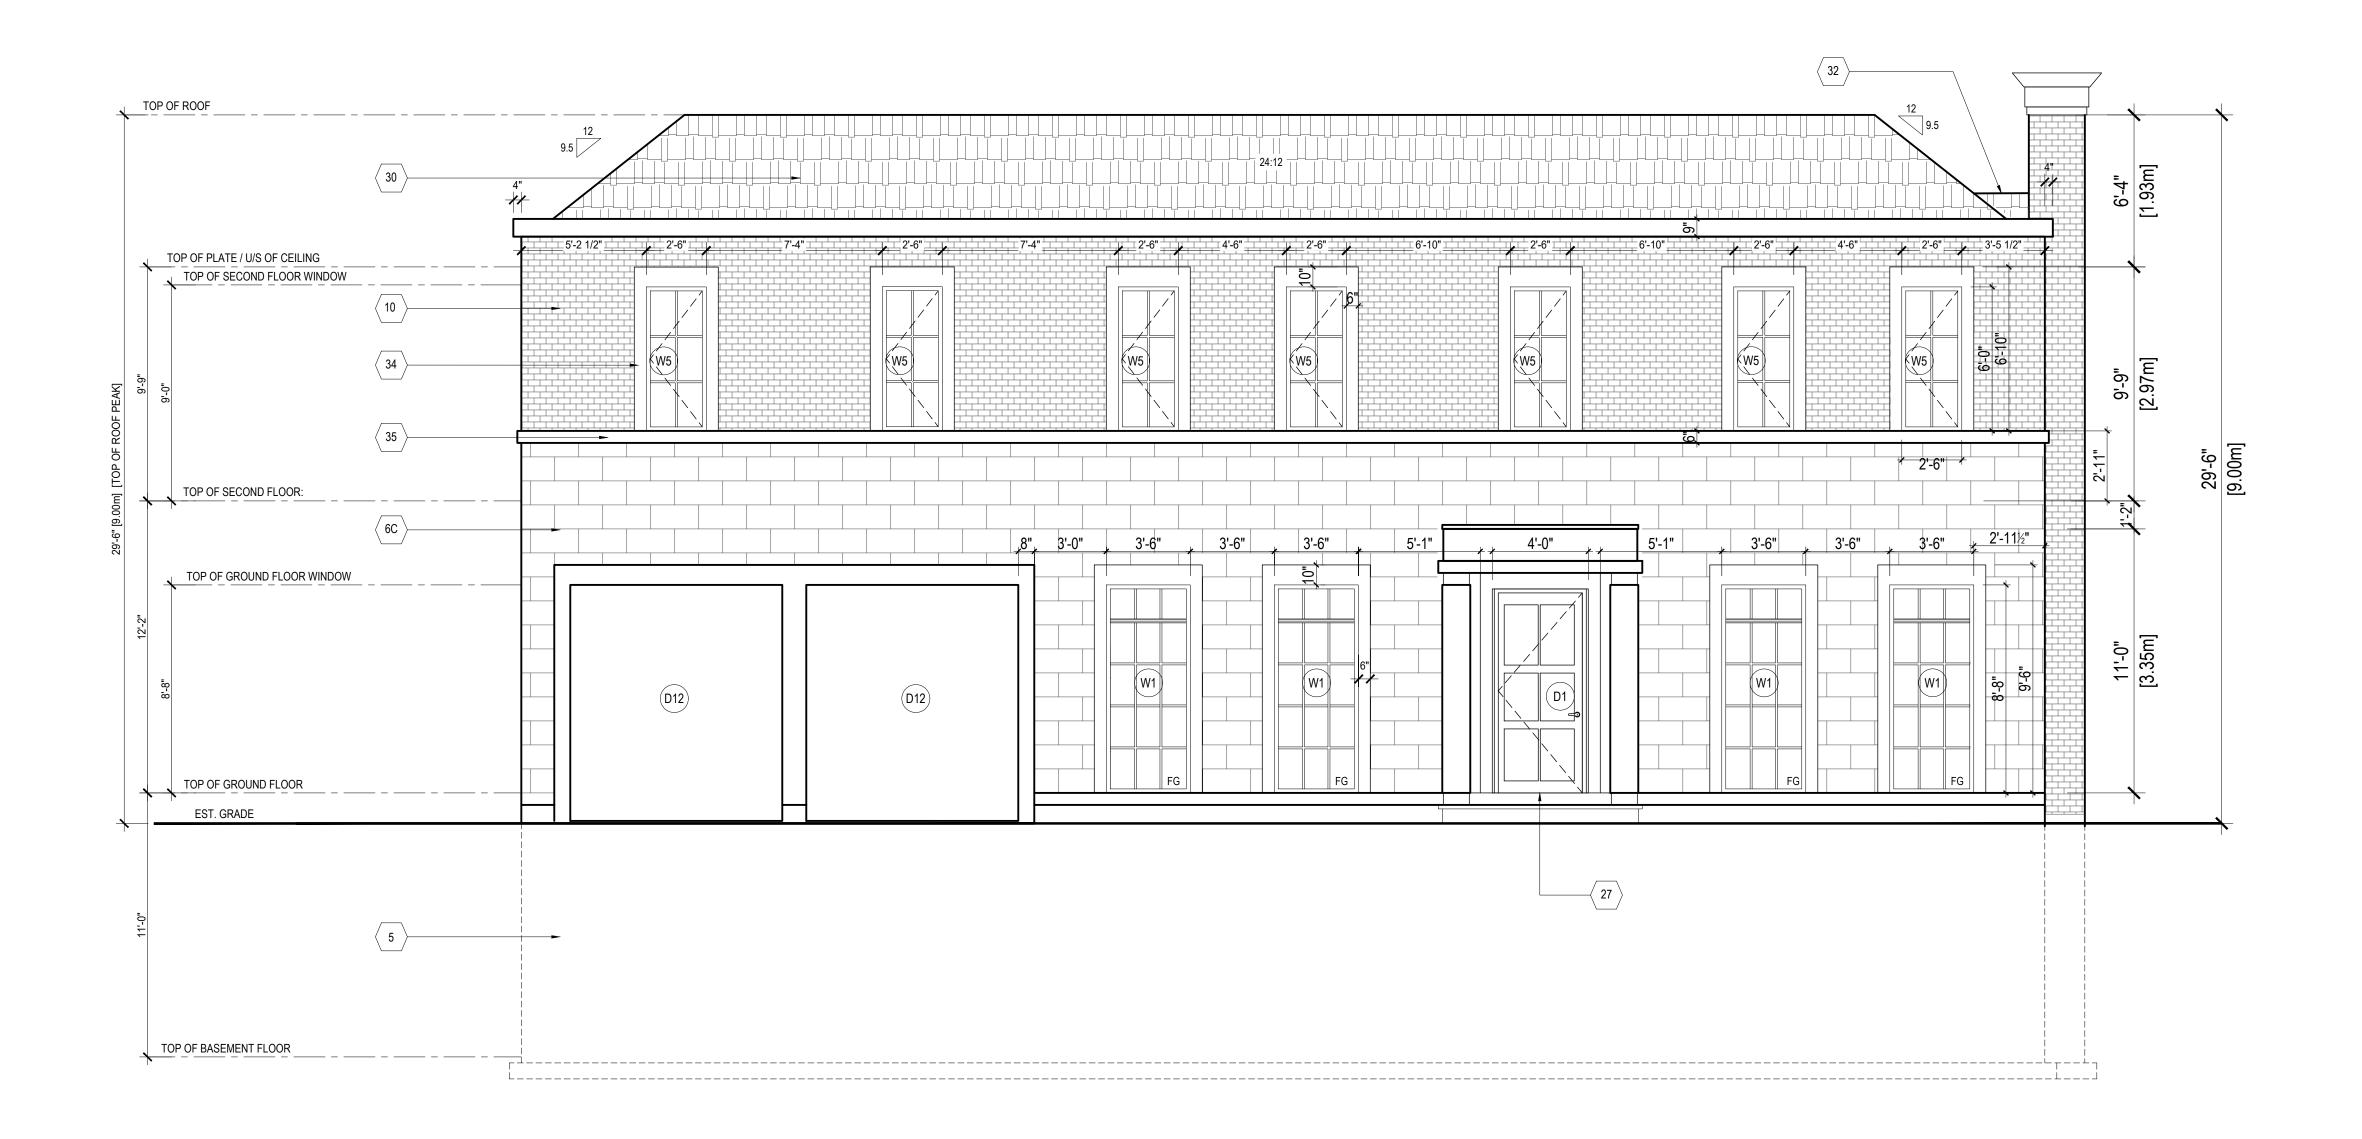
326 SANDLEWOOD RD OAKVILLE, ON

CUSTOM HOME

RIGHT SIDE ELEVATION

1/4" = 1'-0" RS/DO FEB.18.2022

2021-49



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BRICK VENEER CONSTRUCTION

4" BRICK FACE, 1" AIR SPACE, TYVEK HOUSE WRAP (AIR BARRIER/ MOISTURE BARRIER), LAYERS TO OVERLAP, JOINTS TAPED & SEALED ON 1/2" EXTERIOR GRADE PLYWOOD SHEATHING ON 2" x 6" @ 16" O.C. SPR STUD WALLS W/ R-20 BATT INSULATION W/ VAPOUR BARRIER (WARM SIDE). DOUBLE TOP PLATE & SINGLE SOLE PLATE, 1/2" GYPSUM BOARD TAPED, SANDED & PRIMED, READY FOR PAINT FINISH.

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PLYWOOD SHEATHING ON PRE-ENGINEERED ROOF TRUSSES AS NOTED ON

DRAWINGS. PROVIDE APPROVED EAVES PROTECTION TO MIN. 12" BEYOND

INNER FACE OF EXTERIOR WALL. PROVIDE MIN. R40 BATT INSULATION W/ 6 MIL.

POLY VAPOUR BARRIER (WARM SIDE- ABOVE CEILING) W/ 5/8" GYPSUM BOARD.

PROVIDE MIN. 1 SQ.FT. OF ROOF VENT AREA FOR EVERY 300 SQ.F.T OF

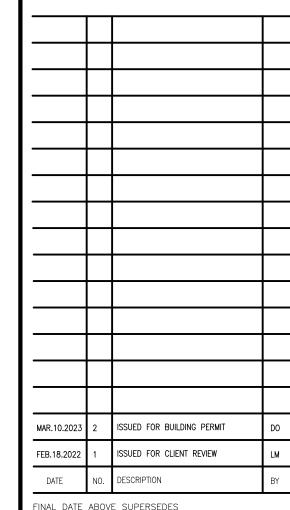
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۸ ۵	LM	CHECKED
A3	FEB.18.2022	DATE
DRAWING	2021-49	PROJ. NO.