


	APPLICANT:		OWNER:		
HICKS DESIGN STUDIO	HICKS DESIGN STUDI	0	PAT GASP	ARRO	
295 ROBINSON ST, SUITE 200	295 ROBINSON ST, SL	ITE 200	344 SPRUC	EST,	
OAKVILLE, ONTARIO L6J 1G7	OAKVILLE, ONTARIO	L6J 1G7	OAKVILLE	ONTARIO	
ATTENTION: WILLIAM R. HICKS	ATTENTION: CYNTHIA	GIBSON	L6L 2H1		
	PH: 905-339-1212 EXT.				
A 10 MILLION DOUGH IN CASE IN BRIDE R. MILLION					
SITE STATISTICS					
ADDRESS:		1067 CEDA	R GROVE	a v	
ADDRESS.				JLV.	
		OAKVILLE,	UNTARIO		
		L6J 2C3	E EL 411 40		
LEGAL DESCRIPTION:			D PLAN 404	1	
		AND BLOC			
			ED PLAN 56	50	
ZONING:		RL1-0			
DESCRIPTION		%	METRIC	IMPERIAL	
		70	and the second second		
LOT AREA:			1,075.426	11,576	
LOT FRONTAGE:					
1. AT STREET			23.77	78	
2. AS PER DEFINITION			23.77	78	
(9.0m back from property line)					
GROSS FLOOR AREA:					
PROPOSED					
GROUND FLOOR			189.75	2,042	
SECOND FLOOR			222.88	2,399	
TOTAL			412.63	4,442	
IOTAL			412.00	4,442	
TOTAL BASEMENT			289.39	3,115	
FINISHED BASEMENT AREA				,	
			191.94	2066	
GARAGE AREA WITHIN A BASEN	IENI		84.82	913	
UNFINISHED BASEMENT AREA			12.63	136	
FLOOR AREA TO LOT AREA RAT	10:				
PERMITTED		37	397.91	4,283	
PROPOSED		38.37	412.63	4,442	APPROVED CAV A/028/2022
GARAGE AREA:					
ALLOWABLE			56.00	603	
PROPOSED			53.20	573	
LOT COVERAGE:					
PERMITTED		25	268.86	2,894	
PROPOSED DWELLING		22.93	246.58	2,654	
PROPOSED COVERED PORCHES		3.12	33.50	361	
PROPOSED TOTAL		26.04	280.09	3,015	APPROVED CAV A/028/2022
DWELLING HEIGHT					1
MAXIMUM HEIGHT TO RIDGE:					
PERMITTED			9.00	29.5	
PROPOSED			9.00	29.5	
			5.00	20.0	
MAXIMUM DWELLING DEPTH			20.00	65.6	
PROPOSED DWELLING DEPTH			25.28	82.9	
Nor OSED DWEEEIng DEI III			23.20	02.5	
MINIMUM FRONT YARD (EAST) R	FOURED		10.33	33.9	(EXIST. FRONT YARD SETBACK-1.0m)
PROPOSED			4.18	33.9 13.7	(ENGT. FRUNT TARD SETDAGK-1.UIII)
MINIMUM FLANKAGE YARD (SOU			4.18	13.7	
•	III) NEQUIRED				
			3.76		APPROVED CAV A/028/2022
MINIMUM INTERIOR SIDE YARD (NOR TH) REQUIRED		4.20	13.8	
			4.20	13.8	
MINIMUM REAR YARD-(WEST)			10.50	34.4	
PROPOSED			15.80	51.8	
POOL SET-BACKS					
MINIMUM FLANKAGE SIDE YARD	- (SOUTH) REQUIRED		3.50		
PROPOSED			2.15		APPROVED CAV A/028/2022
MINIMUM REAR YARD - (WEST) F	REQUIRED		1.50	4.9	
PROPOSED			4.51	14.8	
GARAGE WALL PROJECTION					
MAXIMUM PERMITTED			1.50	4.9	
PROPOSED			6.15	20.2	
					•

	ARCHITECTS Z
	O ARCHITECTS Z
	WILLIAM RHYS HICKS LICENCE
	Territory 3355
Drav	wings must NOT be scaled. Contractor must
drawii	k and verify all dimensions, specifications and ngs on site and report any discrepancies to the itect prior to proceeding with any of the work.
	SITE LEGEND:
~~~~~~~~~~~~~~~~~~~~~~~~~~~~~~~~~~~~~~	PROPERTY LINE EXISTING GRADE
<u>83.37</u> F.F.E.	FINISHED GRADE FINISHED FLOOR ELEVATION
F.B.E.	FINISHED BASEMENT ELEVATION
F.D.E.	FINISHED DECK ELEVATION MAIN ENTRANCE
	SECONDARY ENTRANCE EXISTING STRUCTURES TO BE REMOVED
<del>♦</del> ي DS_	BORE HOLE LOCATION & No. PER SOILS REPORT ROOF DOWNSPOUT LOCATION, DISCHARGE ON
<u> </u>	600X600 CONC. PAVER PROPOSED DIMENSIONS TO NEW STRUCTURES
	EXISTING DIMENSIONS TO EXISTING STRUCTURES
(4)	A) TREE HOARDING TREE NUMBER PER ARBOURIST REPORT
	EXISTING TREE TO REMAIN – DASHED
	ZONE PER ARBOURIST REPORT
	EXISTING TREE TO BE REMOVED
~~~~~~~~~~~~~~~~~~~~~~~~~~~~~~~~~~~~~~~	EXISTING TREE TO BE REMAIN.
•	
+	NEW REPLACEMENT TREE TO BE PLANTED.
2 S	ON OF HALTON CERTIFICATE
LOCATIO SIGNED: Planning & The Applic system on Municipalit Region of I (The Desig may be ob Departmen Furthermoo	ON REGION STANDARDS AND SPECIFICATIONS AND N APPROVAL FROM AREA MUNICIPALITY.
3 08 2 05 1 0 REF. [3.29.22ISSUED FOR C. OF A.3.23.22REISSUED FOR DESP5.06.22ISSUED FOR DESP1.19.22ISSUED FOR C. OF A. REVIEWDATE:DESCRIPTION:SIONS / ISSUANCE:
295 ROB	DESIGN STUDIO DESIGN STUDIO DESIGN STUDIO DESIGN STUDIO.CAN L6J 1G7 T.905.339.1212
	SPARRO RESIDENCE
CITY: DRAV SIT GR	OAKVILLE, ONTARIO. VING TITLE: E SERVICING AND ADING PLAN
	MIT NO. 22-111864
DATE JOB N	1.08.26 SCALE: 1:150 NUMBER: SHEET NUMBER: 1-298 A1.2

RIO ASSOC




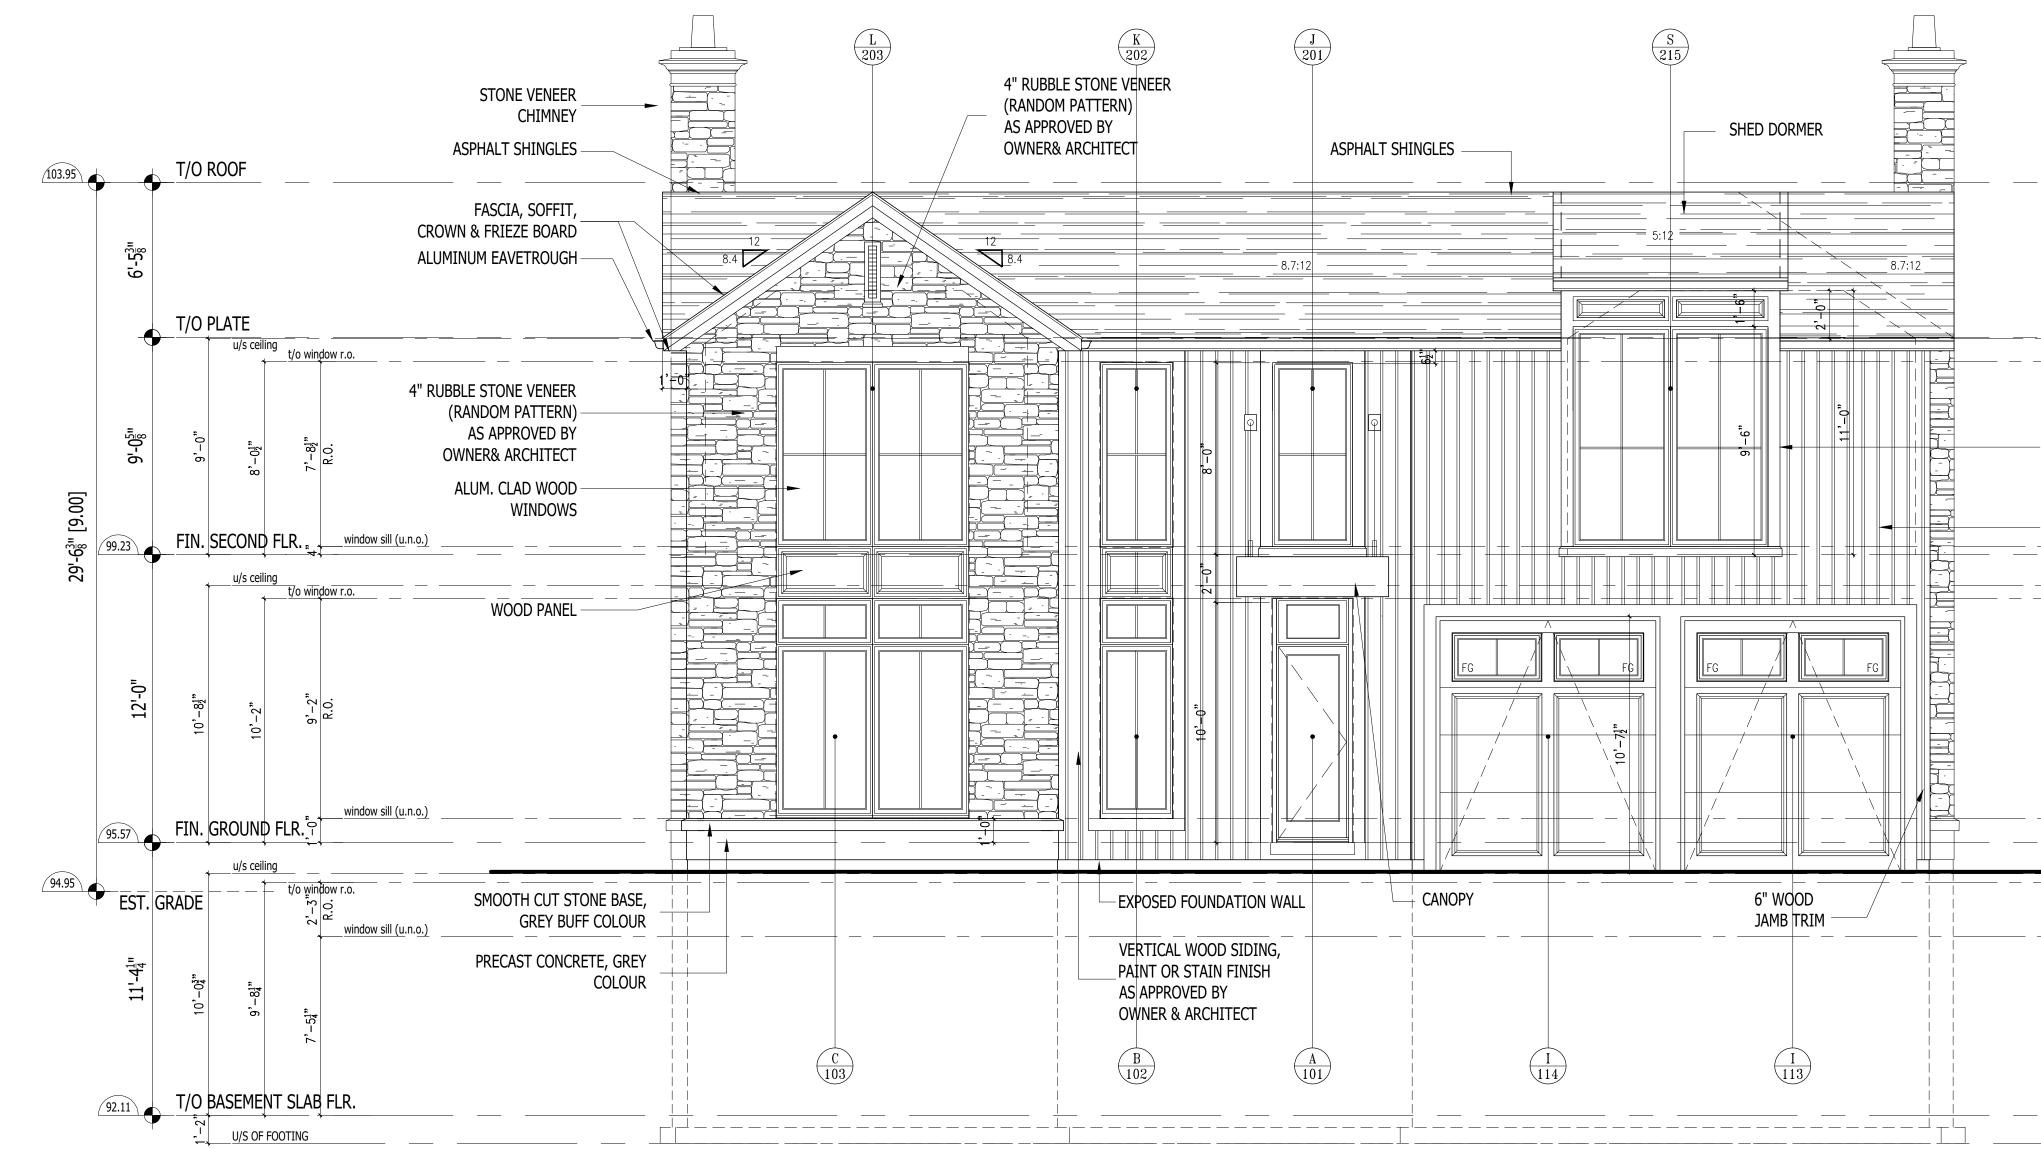

all ASSOC ARCHITECTS WILLIAM RHYS HICKS LICENCE 3355 Drawings must <u>NOT</u> be scaled. Contractor must check and verify all dimensions, specifications and drawings on site and report any discrepancies to the architect prior to proceeding with any of the work. 3 08.29.22 ISSUED FOR C. OF A. 2 07.19.22 ISSUED FOR BUILDING PERMIT 1 01.19.22 ISSUED FOR C. OF A. REVIEW REF. DATE: DESCRIPTION: **REVISIONS / ISSUANCE:** CKS \mathbf{H} DESIGN STUDIO HICKS DESIGN STUDIO 295 ROBINSON STREET, SUITE 200 OAKVILLE ON, CAN L6J 1G7 WWW.HICKSDESIGNSTUDIO.CA T.905.339.1212 CLIENT: GASPARRO RESIDENCE ADDRESS: 1067 CEDAR GROVE BLV. CITY: OAKVILLE, ONTARIO. DRAWING TITLE: RIGHT SIDE (EAST) ELEVATION DRAWN: V.P./D.S. DATE: 21.03.20 SCALE: 1/4"=1'-0" JOB NUMBER: SHEET NUMBER: A4.3 21-298

- 6" WOOD TRIM

VERTICAL WOOD SIDING, __ PAINT OR STAIN FINISH __AS_APPROVED BY_____ OWNER & ARCHITECT

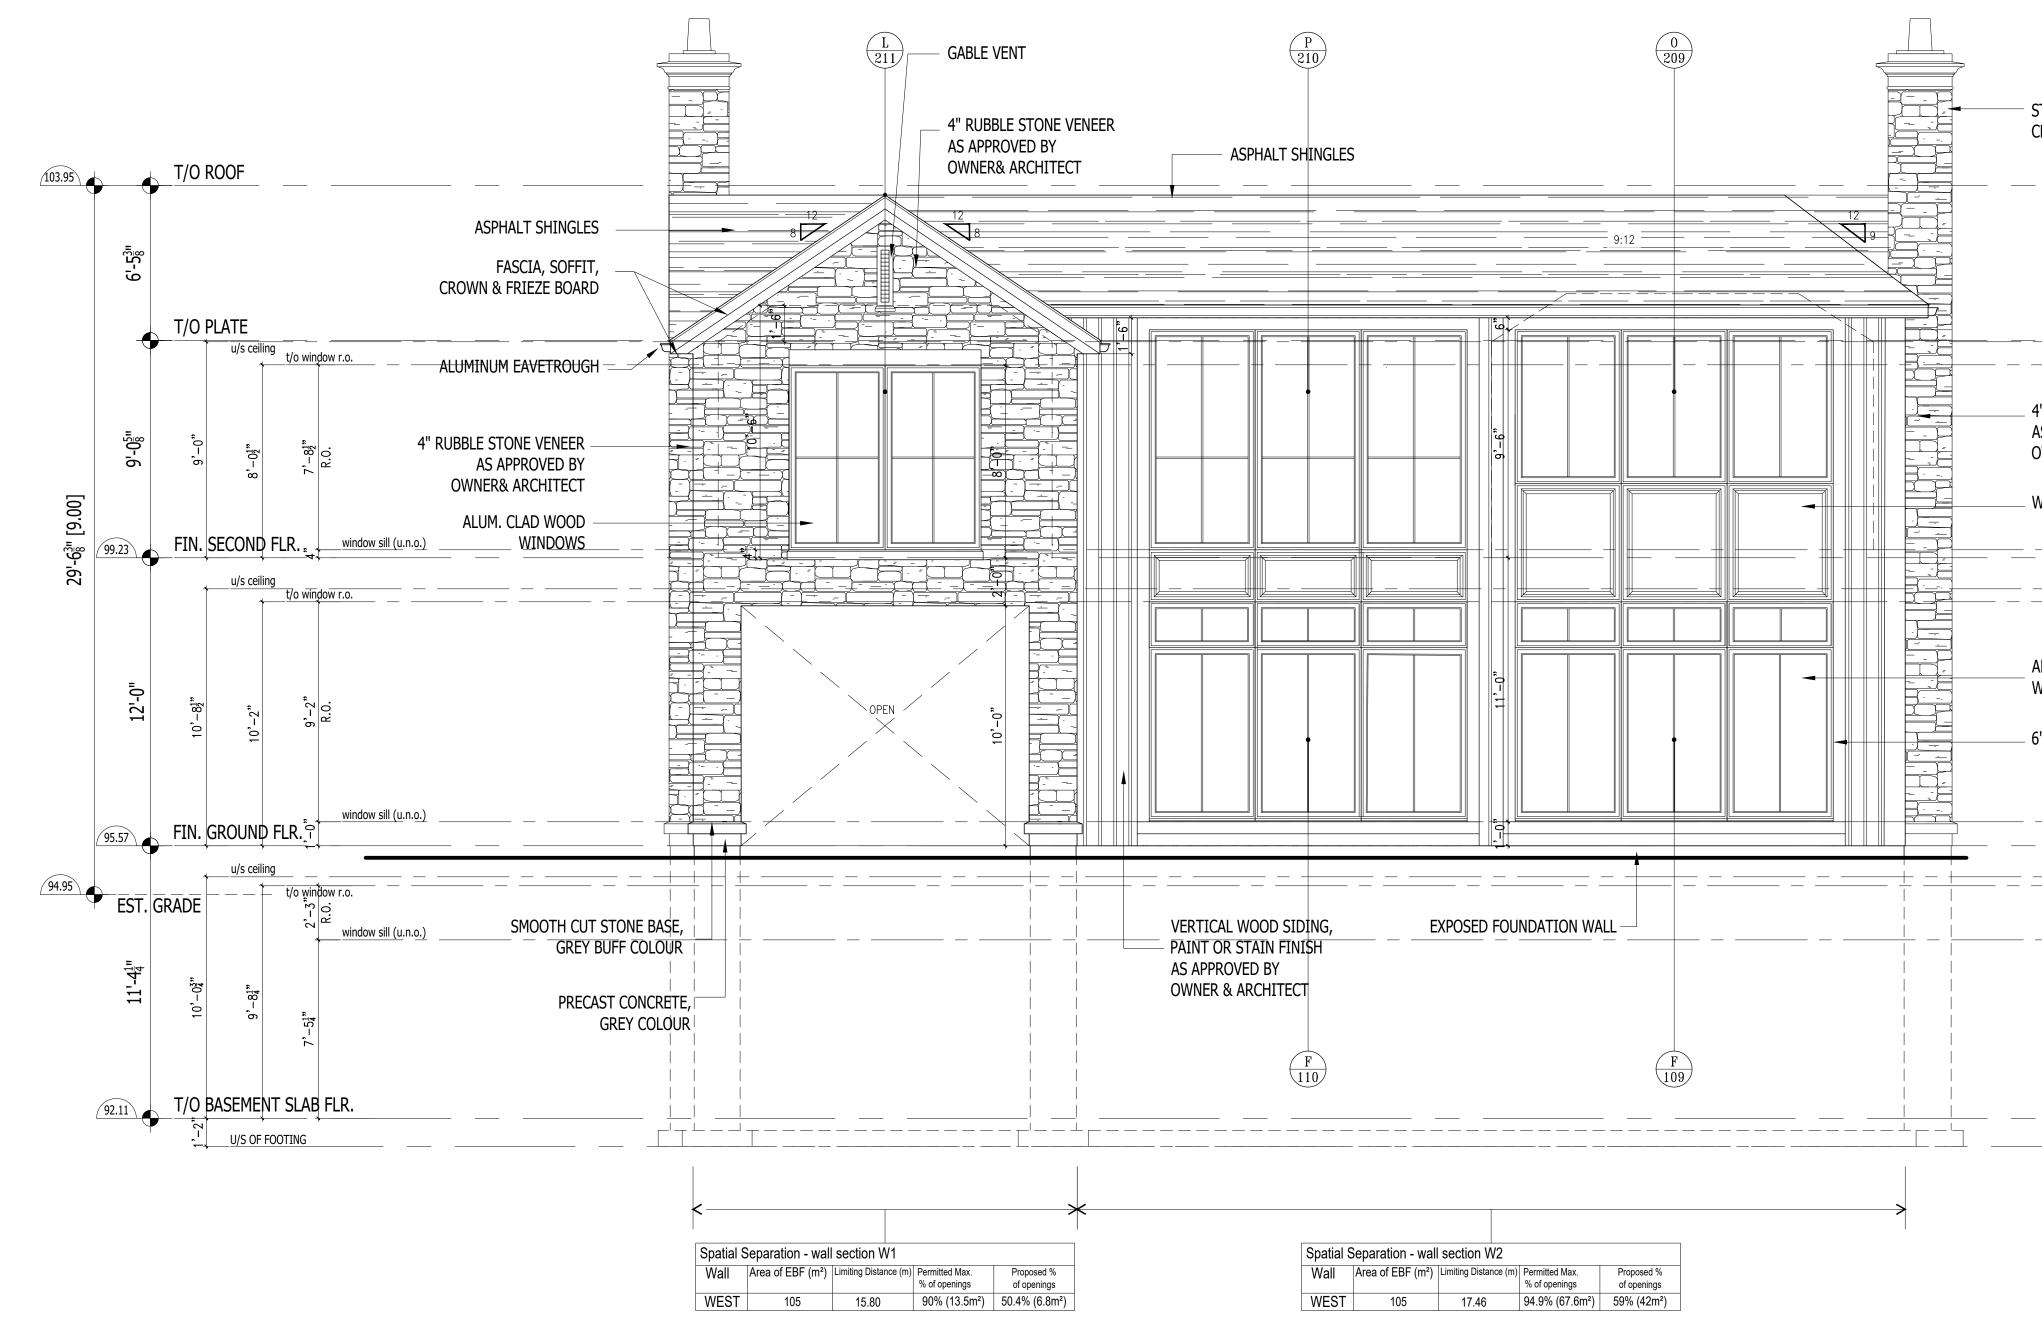



RIO ASSOC ARCHITECT WILLIAM RHYS HICKS LICENCE 3355 Drawings must <u>NOT</u> be scaled. Contractor must check and verify all dimensions, specifications and drawings on site and report any discrepancies to the architect prior to proceeding with any of the work. 3 08.29.22 ISSUED FOR C. OF A. 2 07.19.22 ISSUED FOR BUILDING PERMIT 1 01.19.22 ISSUED FOR C. OF A. REVIEW REF. DATE: DESCRIPTION: **REVISIONS / ISSUANCE:** HICKS DESIGN STUDIO HICKS DESIGN STUDIO 295 ROBINSON STREET, SUITE 200 OAKVILLE ON, CAN L6J 1G7 WWW.HICKSDESIGNSTUDIO.CA T.905.339.1212 CLIENT: GASPARRO RESIDENCE ADDRESS: 1067 CEDAR GROVE BLV. CITY: OAKVILLE, ONTARIO. DRAWING TITLE: LEFT SIDE (WEST) ELEVATION DRAWN: V.P./D.S. DATE: 21.03.20 SCALE: 1/4"=1'-0" SHEET NUMBER: JOB NUMBER: A4.4 21-298


- Stone veneer Chimney

4" RUBBLE STONE VENEER AS APPROVED BY OWNER& ARCHITECT

- WOOD PANEL

_ ALUM. CLAD WOOD WINDOWS


- 6" WOOD TRIM

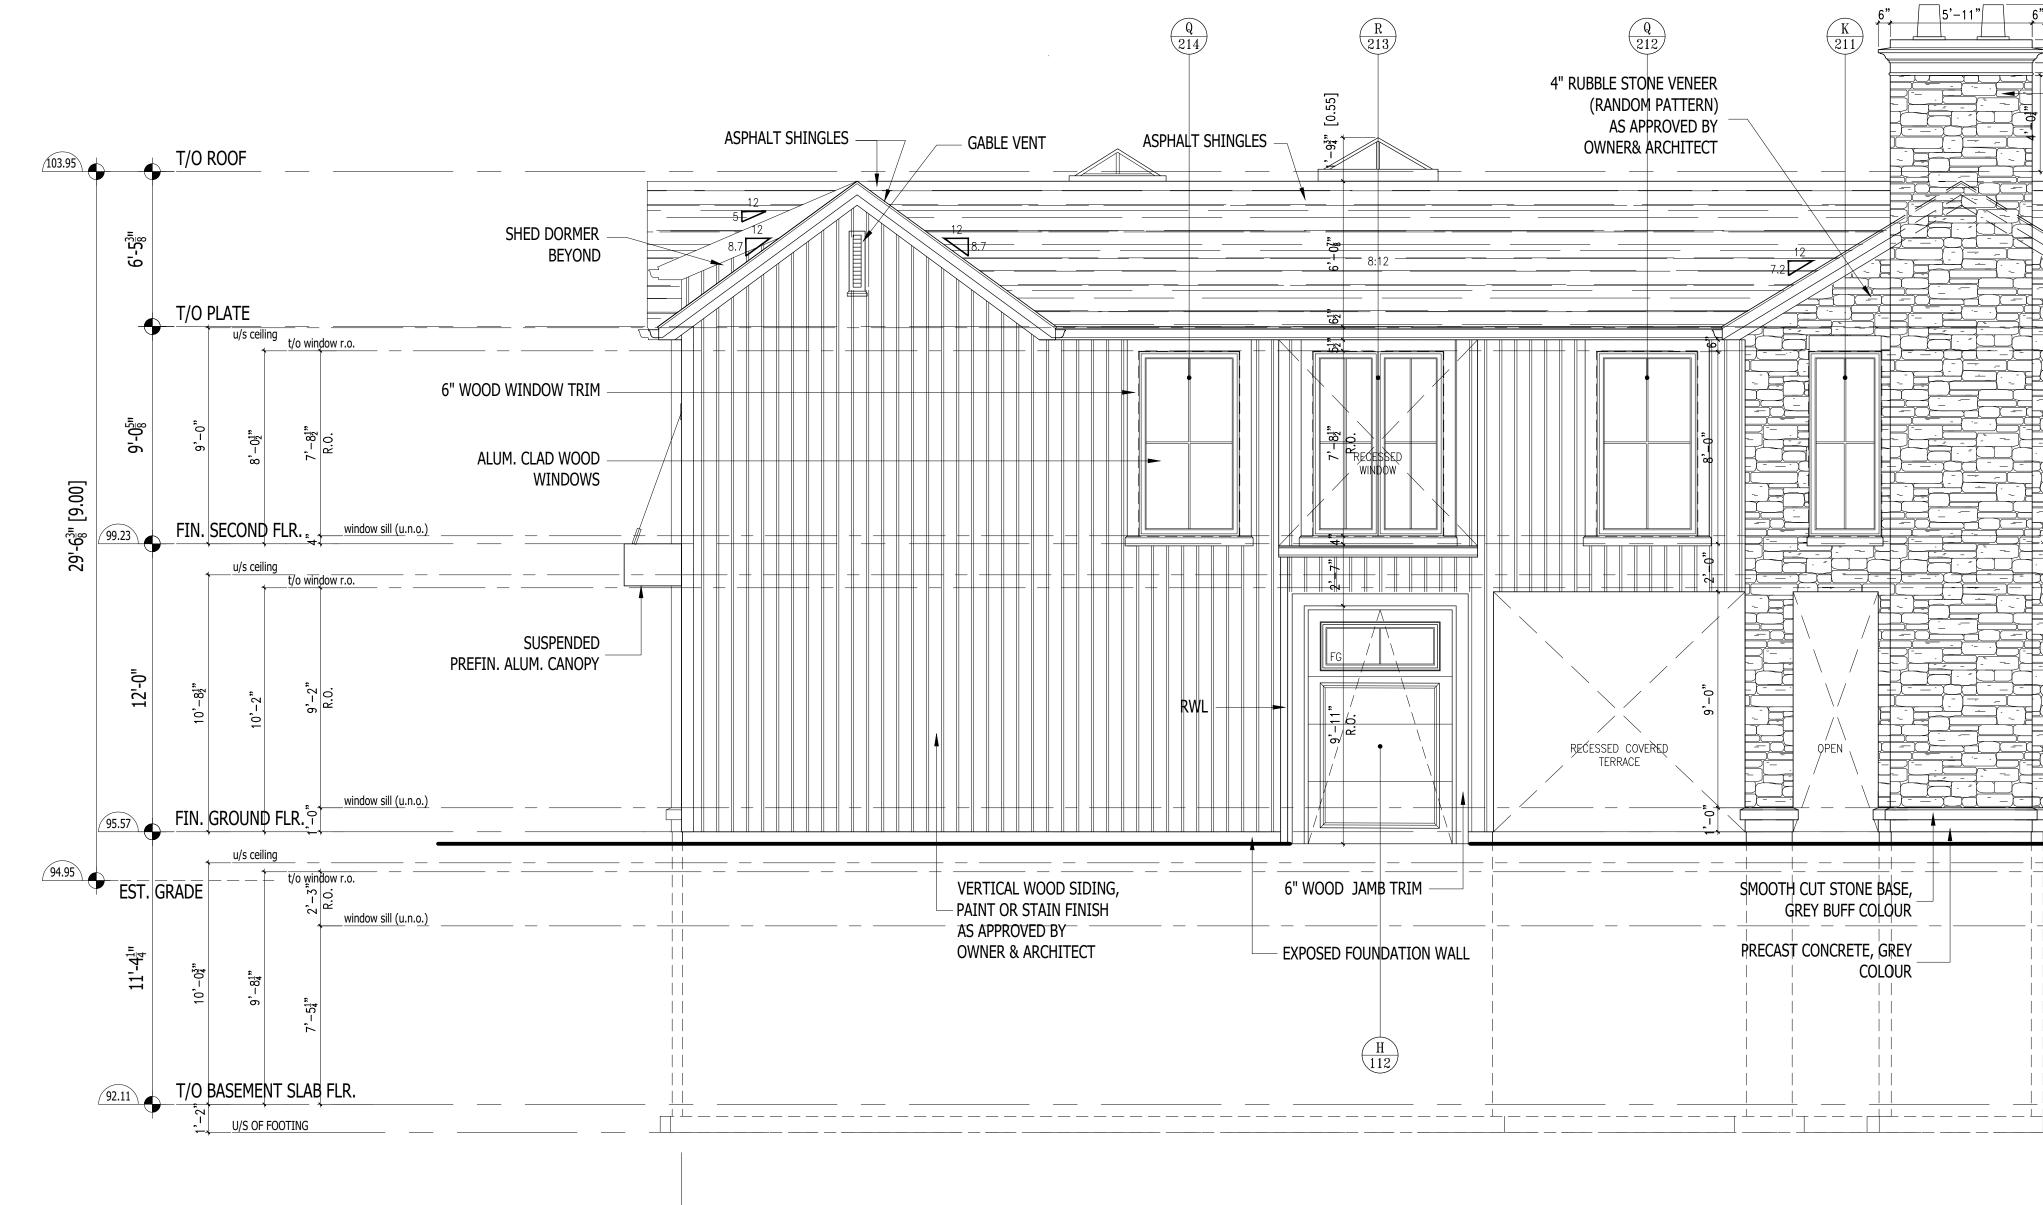

22 C:\USERS\DANYHICKS DESIGN STUDIO\HDS - DOCUMENTS\21-298 GASPARRO - 1067 CEDAR GROVE BLVD\DRAWINGS\21-298 GASPARRO RESIDENCE(AUG 19. 2022) PERMIT.I

Spatial S	Separation			
Wall	Area of EBF (m ²)	Limiting Distance (m)	Permitted Max. % of openings	Proposed % of openings
NORTH	124	4.20	12.7% (15.7m ²)	9.4% (11.7m ²)

O ASSOC ARCHITECT WILLIAM RHYS HICKS LICENCE 3355 Drawings must NOT be scaled. Contractor must check and verify all dimensions, specifications and drawings on site and report any discrepancies to the architect prior to proceeding with any of the work. - Stone veneer Chimney - Aluminum Eavetrough \1'-0" FASCIA, SOFFIT, CROWN & FRIEZE BOARD 4" RUBBLE STONE VENEER - (RANDOM PATTERN) AS APPROVED BY OWNER& ARCHITECT 3 08.29.22 ISSUED FOR C. OF A. 2 07.19.22 ISSUED FOR BUILDING PERMIT 1 01.19.22 ISSUED FOR C. OF A. REVIEW REF. DATE: DESCRIPTION: **REVISIONS / ISSUANCE:** HICKS $\lfloor | \top - - - | \bot - - \bot$ DESIGN STUDIO HICKS DESIGN STUDIO 295 ROBINSON STREET, SUITE 200 OAKVILLE ON, CAN L6J 1G7 WWW.HICKSDESIGNSTUDIO.CA T.905.339.1212 CLIENT: GASPARRO RESIDENCE ADDRESS: 1067 CEDAR GROVE BLV. CITY: OAKVILLE, ONTARIO. DRAWING TITLE: REAR (NORTH) ELEVATION DRAWN: V.P./D.S. DATE: 21.03.20 SCALE: 1/4"=1'-0" JOB NUMBER: SHEET NUMBER: A4.2 21-298

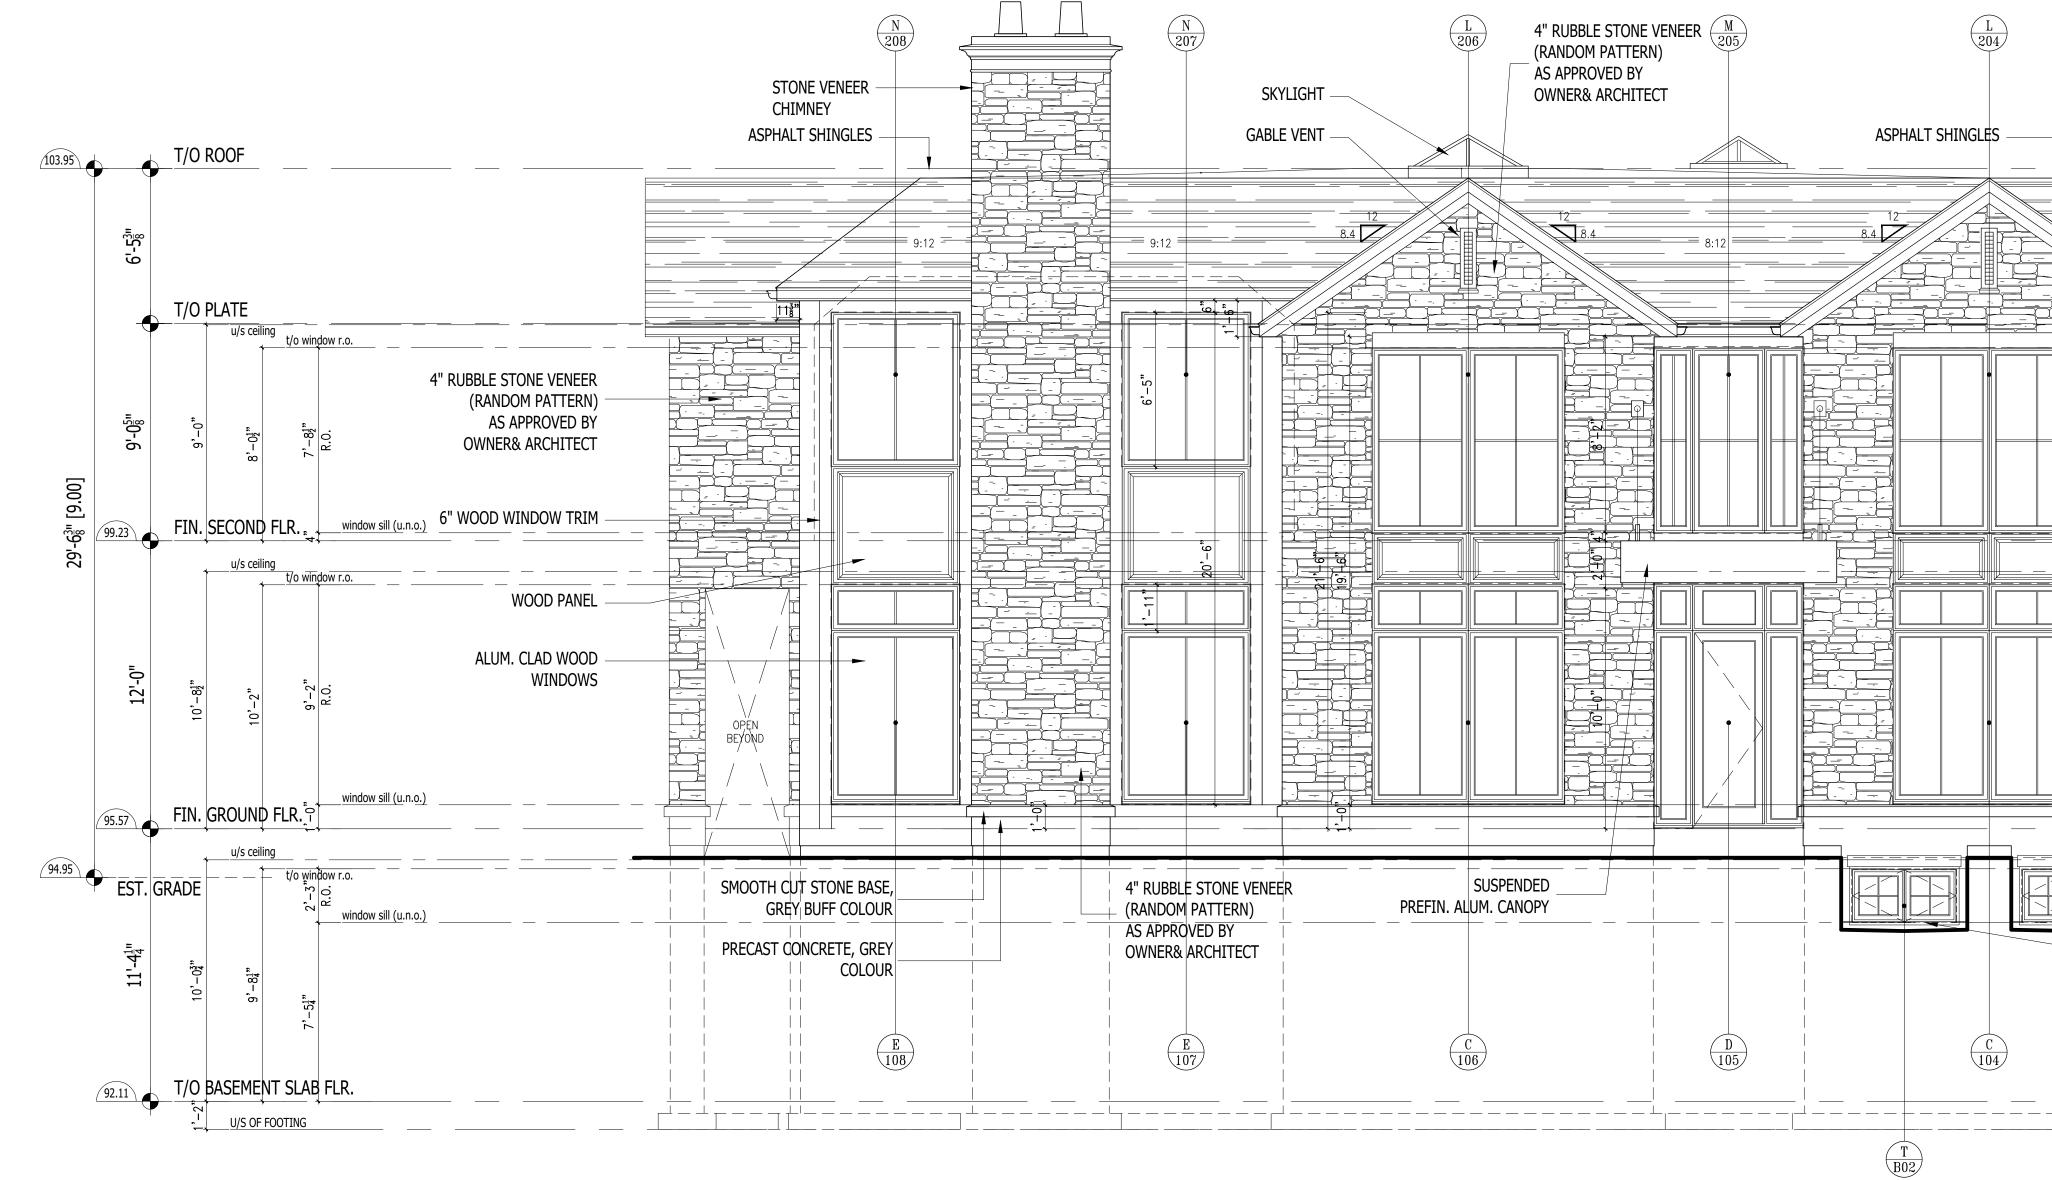

RIO ASSOC OF ARCHITECTS WILLIAM RHYS HICKS LICENCE 3355 Drawings must NOT be scaled. Contractor must check and verify all dimensions, specifications and drawings on site and report any discrepancies to the architect prior to proceeding with any of the work. 3 08.29.22 ISSUED FOR C. OF A. 2 07.19.22 ISSUED FOR BUILDING PERMIT 1 01.19.22 ISSUED FOR C. OF A. REVIEW REF. DATE: DESCRIPTION: **REVISIONS / ISSUANCE:** HICKS DESIGN STUDIO HICKS DESIGN STUDIO 295 ROBINSON STREET, SUITE 200 OAKVILLE ON, CAN L6J 1G7 WWW.HICKSDESIGNSTUDIO.CA T.905.339.1212 CLIENT: GASPARRO RESIDENCE ADDRESS: 1067 CEDAR GROVE BLV. CITY: OAKVILLE, ONTARIO. DRAWING TITLE: FRONT (SOUTH) ELEVATION DRAWN: V.P./D.S. DATE: 21.08.23 SCALE: 1/4"=1'-0" JOB NUMBER: SHEET NUMBER: A4.1 21-298

<u>-</u>8.4 8.4.12 - Aluminum Eavetrough FASCIA, SOFFIT, CROWN & FRIEZE BOARD 6" CUT STONE JAMB TRIM - Wood Panel SUSPENDED - PREFIN. ALUM. CANOPY 4" RUBBLE STONE VENEER (RANDOM PATTERN) AS APPROVED BY **OWNER& ARCHITECT** ALUM. CLAD WOOD WINDOWS - ____ - EXPOSED FOUNDATION WALL _ EGRESS WINDOWS AS PER O.B.C. (9.9.10.1) _____ _____ T B01



September 30, 2022/Revised October 25, 2022

Committee Of Adjustment, Town of Oakville 1225 Trafalgar Road, Oakville, ON

RE: Minor Variance Application, 1067 Cedar Grove Blvd

Dear Committee:

We are the Architects working with the Owners on their new 2 storey dwelling at 1067 Cedar Grove Blvd. We came before the Committee earlier in the year for variances connected to the new dwelling (CAV A/028/22, flankage yard, residential floor area and coverage) which were approved. Since that time, the Owner has requested to have a garage below grade, so this application is directly related to that request. As such, we would like to request relief for 3 minor variances which are technical in nature and are listed below. Again, these requests are for a below grade garage which do not impact the adjacent neighbour or streetscape.

Zoning Bylaw 2014-14, RL1-0 Variances Requested

Front yard setback- Permitted: 10.33 Proposed: 4.18

The front yard setback is measured to the closest part of the dwelling above or below grade so in this instance, the front yard is measured to the underground portion of the garage at 4.18m. This is a technical variance as the reduction in the front yard setback is all underground and has no impact on the adjacent neighbour or streetscape.

Dwelling Depth- Permitted: 20.00 Proposed: 25.28

The calculation for dwelling depth is measured from the front of the garage which is underground to the rear of the dwelling or in this case, the covered porch. Again, this is a technical variance as the additional depth is all underground and has no impact on the adjacent neighbour or streetscape.

Garage Wall Projection-Permitted: 1.50 Proposed: 6.15

The garage projection is measured from the underground portion of the garage to the longest portion of the main wall located on the ground floor which in this instance is from the study room. Again, this is a technical variance as the additional relief for garage wall projection is underground and has no impact on the adjacent neighbour or streetscape.



It should also be noted that our Arborist has reviewed Tree number 2 (Town Tree) in connection with this Minor Variance application and it is being preserved with the excavation outside of the required TPZ. The report is also attached.

We believe this proposal certainly complies with the Official Plan, is desirable development in the neighbourhood and is minor in nature given all the variances are below grade.

Thank you for your consideration. We look forward to presenting this application to you.

Sincerely,

William R. Hicks B.E.S., B.Arch., MRAIC. OAA

HDS | Hicks Design Studio Inc.

295 Robinson Street, Suite 200 Oakville, Ontario, Canada L6J 1G7 T. 905.339.1212 ext. 222 C. 416.953.2926 bhicks@hicksdesignstudio.ca



1067 Cedar Grove Boulevard Oakville, Ontario Arborist Report & Tree Protection Plan

Report to:	Development & Engineering Town of Oakville	Submitted by:	Wildwood Tree Services Michael Boulanger ISA Certified Arborist info@wildwoodtree.ca 905-337-8733
Requested by:	Pat Gasparro pgasparro@rogers.com	Report Author:	Jennifer Kreller info@wildwoodtree.ca
Re:	Site Plan Application		
Date:	April 20, 2022 Updated July 28, 2022 Updated Aug 22, 2022 Updated October 12, 2022	2	
# of Pages:	19		
Delle D	1		

Mike Boulanger, ON0893-AT

Site & Report Background	Page 3
Observations & Recommendations	Page 3
Tree Inventory	Page 4-5
Tree Inventory Methodology	Page 6
Municipal Appraisals	Page 7-11
Site Plan & Tree Protection Measures	Page 12
Town of Oakville Forestry GIS Map	Page 13
Site Photos	Page 14-16
Town of Oakville Schedule 1; Specifications for Tree Protection Barrier	Page 17
List of Trees to Consider Planting (post construction)	Page 18
Town of Oakville Arborist License	Page 19
ISA Certification	Page 19

Site & Report Background:

To obtain a permit to install a 2-story dwelling at 1067 Cedar Grove Boulevard in Oakville.

I have visited the above site and collected all relevant data pertaining to the tree protection on site and any relevant trees within 6 meters of the property line. Data was collected on December 30, 2021 by Mike Boulanger ISA Certified Arborist.

Observations & Recommendations:

There are 15 trees identified on this report; any municipal trees located within 6 meters of the property line and all privately owned trees over 15cm in DBH within 6 meters of the property line.

Tree 1 is dead and requires removal by the Town of Oakville, marked with an X.

Trees 3, 7 and 8 are proposed for removal to accommodate the proposed construction. A tree removal permit is required. It is anticipated that 13 replacement trees will be required by the Town of Oakville.

Boundary tree 10 requires removal as it's dead. Written permission from the neighbouring property and a tree removal permit is required prior to removal.

The proposed excavation for the pool and patio will encroach on the tree protection zone of tree 12. It is recommended that this area is exposed using high pressure air, referred to as air spading technology, so the roots can be pruned by a Certified Arborist prior to excavation.

All remaining trees are to be protected as per the Town of Oakville standards throughout construction.

This report has been written in accordance the Town of Oakville's Tree Protection during Construction Procedures. Additional information can be found at http://www.oakville.ca/townhall/en-tre-001-001.html

Inspection of the trees on site was limited to a visual assessment from the ground only, unless stated otherwise. No inspection via climbing, exploration below grade, probing, or coring were conducted. Any observations and data collected from site are based on conditions at the time of inspection. Diameters of trees located on neighbouring properties were estimated to avoid trespassing.

Tree Inventory

Tree	Species	DBH	Crown	Health	Structural	Preservation	TPZ	Ownership	Observations/
No.		(cm)	Reserve (m)		Condition	Rating	(m)		Comments/ Recommendations
1	Norway Maple, Acer platanoides	61	8	D	Р	L REMOVE	N/R	Town of Oakville	Tree ID 76585. DD; marked for removal by town with X.
2	Norway Maple, Acer platanoides	75	18	G	F	H PRESERVE	4.8	Town of Oakville; Appraisal value \$15,539.06	Tree ID 52537. TD. DW. PP.
3	Little leaf linden, <i>Tilia cordata</i>	26	8	G	F	L REMOVE	N/R	Private	PD; requires removal. Permit required. LN. LS.
4	Norway Maple, Acer platanoides	64	17	F	F	H PRESERVE	4.2	Town of Oakville; Appraisal value \$13,613.06	Tree ID 74004. TD. Vines growing on trunk. CD. DW.
5	Little leaf linden, <i>Tilia cordata</i>	23	6	G	G	H PRESERVE	2.4	Private	
6	Norway Maple, Acer platanoides	48*	13.7	G	G	H PRESERVE	3.0 PWF	Neighbour	0.5m from property line.
7	Austrian Pine, <i>Pinus nigra</i>	64	14	F	F	L REMOVE	N/R	Private	PD; requires removal. Permit required. DW. DS; infected with diplodia.
8	Austrian Pine, Pinus nigra	43	11	F	F	L REMOVE	N/R	Private	PD; requires removal. Permit required. DW. DS; infected with diplodia.

*DBH Estimated due to access restraints

PWF = Protected with fencing

Requires attention

Tree Inventory

				r	-		r r		
Tree	Species	DBH	Crown	Health	Structural	Preservation	TPZ	Ownership	Observations/
No.		(cm)	Reserve		Condition	Rating	(m)		Comments/
			(m)						Recommendations
9	Silver Maple,	65*	19.8	F	F	М	4.2	Neighbour	2m from property line.
	Acer saccharinum					PRESERVE	PWF		DW. CD. PP.
					_	_			
10	Red Maple, acer	63*	14	D	Р	L	N/R	Boundary	DD; requires removal.
	rubrum					REMOVE			Permit and neighbours
									permission required.
11	Silver Maple,	87	22	F	F	М	5.4	Boundary	CD. Large DW. LN. TD.
	Acer saccharinum					PRESERVE			Requires monitoring.
10	Oilean Man Ia	440	0.1				7.0	Deves de rec	
12	Silver Maple,	112	24	F	F	M	7.2	Boundary	CD. Large DW. IB. TD.
	Acer saccharinum					PRESERVE			PP. Air spading & root
									pruning recommended
									before landscape
									excavation.
13	Canadian Yew,	40	6	G	G	Н	3.0	Town of Oakville;	Tree ID 428743.
	Taxus canadensis					PRESERVE		Appraisal value	
								\$5,760.00	
14	Norway Maple,	48	11.9	F	F	Н	3.0	Town of Oakville;	Tree ID 428744. PP. DW.
	Acer platanoides					PRESERVE		Appraisal value	
	,							\$7425.60	
15	Mountain Ash,	24	6	F	F	Н	2.4	Town of Oakville;	Tree ID 13467. IB. DW.
-	Sorbus aucuparia		_			PRESERVE		Appraisal value	
								\$1,814.40	
								ψι,σιι.ισ	

*DBH Estimated due to access restraints

PWF = Protected with fencing

Requires attention

TREE INVENTORY METHEDOLOGY

DBH (cm): Diameter at breast height, standard of 1.4m above ground. Height (m)3.5 Height of tree from ground to top of crown.

Crown Reserve (m): Diameter of crown, the trees canopy width.

Health: General overall health of the tree. Rated as (E) excellent, (G) good, (F) fair, (P) poor, (D) dead.

Structural Condition: Based on structural faults or defects Rated as (E) excellent, (G) good, (F) fair, (P) poor.

Preservation Rating: A trees projected survival based on the existing conditions. Rated as (H) high, (M) moderate, (L) low.

Observations, Comments, and Recommendations:

DD= deadRM= remove plantDF= defoliatedRP= requires pruningDS= diseasedRS= remove stakes or wirDW= deadwoodTD= trunk decayEC= elevate canopyTP= transplanting potentiaER= exposed rootsTRS= transplant stressEX= existing cableTS= trunk splitFC= frost cracksUT= understory treeFS= plant in footprint of proposed structureUT= understory treeGC= impact from grade changesGR= girdling rootsHT= hazardous treeIB= included barkLN= leaningLS= light suppressedMS= multiple stemsPC= pollarded crownPL= poor leader developmentPP= passed pruning

Tree Number: Address: Owner: Date of Appraisal: Appraiser: Certification Number:	2 1067 Cedar Grove Blvd Town of Oakville April 20, 2022 Mike Boulanger ON-0893AT					
Number.						
Field Observations						
	1. Species:	Norway Maple				
	2. Condition:	60%				
	3. DBH:	75				
	4. Location:	65%				
Regional Plant Appra	Regional Plant Appraisal or Appraiser Developed or Modified Information					
	5. Species Rating:	68%				
	6a. Replacement Plant Size:	12				
	6b. Trunk Area:	113.04				
	7. Replacement Plant Cost:	500				
	8. Installation Cost:	1000				
	9. Installed Tree Cost:	1500				
	10. Unit Tree Cost:	13.27				
Calculations by Appr	aiser using Field and Regional Information					
	11. Appraised Trunk Area:	4,415.63				
	12. Appraised Tree Trunk Increase:	4,302.59				
	(#11 less #6b)					
	13. Basic Tree Cost (#12 x #10 + #9):	58,593.75				
	14. Appraised Value:	\$15,539.06				

Tree Number: Address: Owner: Date of Appraisal: Appraiser: Certification Number:	4 1067 Cedar Grove Blvd Town of Oakville April 20, 2022 Mike Boulanger ON-0893AT	
Field Observations		
	1. Species:	Norway Maple
	2. Condition:	69%
	3. DBH:	64
	4. Location:	68%
Regional Plant Appra	aisal or Appraiser Developed or Modified Informa	ition
	5. Species Rating:	68%
	6a. Replacement Plant Size:	12
	6b. Trunk Area:	113.04
	7. Replacement Plant Cost:	500
	8. Installation Cost:	1000
	9. Installed Tree Cost:	1500
	10. Unit Tree Cost:	13.27
Calculations by Appr	aiser using Field and Regional Information	
	11. Appraised Trunk Area:	3,215.36
	 Appraised Tree Trunk Increase: (#11 less #6b) 	3,102.32
	13. Basic Tree Cost (#12 x #10 + #9):	42,666.67
	14. Appraised Value:	\$13,613.06

Tree Number: Address: Owner: Date of Appraisal: Appraiser: Certification Number:	13 1067 Cedar Grove Blvd Town of Oakville April 20, 2022 Mike Boulanger ON-0893AT	
Number.		
Field Observations		
	1. Species:	Canadian Yew
	2. Condition:	80%
	3. DBH:	40
	4. Location:	60%
Regional Plant Appr	aisal or Appraiser Developed or Modified Informa	ation
	5. Species Rating:	72%
	6a. Replacement Plant Size:	12
	6b. Trunk Area:	113.04
	7. Replacement Plant Cost:	500
	8. Installation Cost:	1000
	9. Installed Tree Cost:	1500
	10. Unit Tree Cost:	13.27
Calculations by App	raiser using Field and Regional Information	
	11. Appraised Trunk Area:	1,256.00
	 Appraised Tree Trunk Increase: (#11 less #6b) 	1,142.96
	13. Basic Tree Cost (#12 x #10 + #9):	16,666.67
	14. Appraised Value:	\$5,760.00

Tree Number: Address: Owner: Date of Appraisal: Appraiser: Certification Number:	14 1067 Cedar Grove Blvd Town of Oakville April 20, 2022 Mike Boulanger ON-0893AT	
Field Observations		
	1. Species:	Norway Maple
	2. Condition:	65%
	3. DBH:	48
	4. Location:	70%
Regional Plant Appr	aisal or Appraiser Developed or Modified Informa	tion
	5. Species Rating:	68%
	6a. Replacement Plant Size:	12
	6b. Trunk Area:	113.04
	7. Replacement Plant Cost:	500
	8. Installation Cost:	1000
	9. Installed Tree Cost:	1500
	10. Unit Tree Cost:	13.27
Calculations by App	raiser using Field and Regional Information	
	11. Appraised Trunk Area:	1,808.64
	 Appraised Tree Trunk Increase: (#11 less #6b) 	1,695.60
	13. Basic Tree Cost (#12 x #10 + #9):	24,000.00
	14. Appraised Value:	\$7,425.60
		<i></i>

Tree Number:	15	
Address:	1067 Cedar Grove Blvd	
Owner:	Town of Oakville	
Date of Appraisal:	April 20, 2022	
Appraiser:	Mike Boulanger	
Certification Number: ON-0893AT		

Field Observations


1. Species:	Mountain Ash
2. Condition:	70%
3. DBH:	24
4. Location:	72%

Regional Plant Appraisal or Appraiser Developed or Modified Information

5. Species Rating:	60%
6a. Replacement Plant Size:	12
6b. Trunk Area:	113.04
7. Replacement Plant Cost:	500
8. Installation Cost:	1000
9. Installed Tree Cost:	1500
10. Unit Tree Cost:	13.27

Calculations by Appraiser using Field and Regional Information

14. Appraised Value:	\$1,814.40
13. Basic Tree Cost (#12 x #10 + #9):	6,000.00
(#11 less #6b)	
12. Appraised Tree Trunk Increase:	339.12
11. Appraised Trunk Area:	452.16

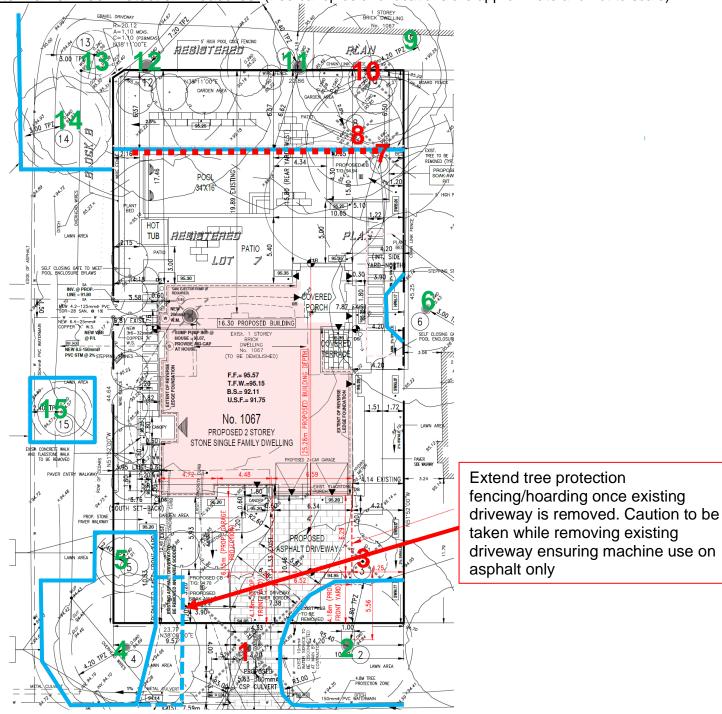


Site Plan & Tree Protection Measures: (tree canopies and locations are approximate and not to scale)

Green = PRESERVE Red = REMOVE Air Spade & Root Pruning by certified arborist prior to excavation VTPZ: Tree Protection Hoarding is indicated in BLUE Please see the Inventory Page to determine the recommended TPZ (Tree Protection Zone)

requirements for each tree

Town of Oakville GIS

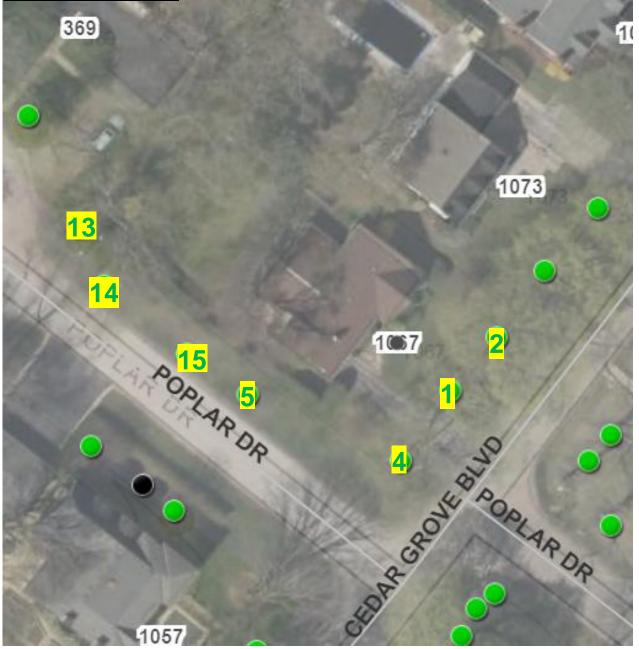



VTPZ Tree Protection Hoarding is indicated in BLUE Construction/Machine Access

HTPZ Horizontal Hoarding: 5" Layer of woodchips & Plywood or Steel Plating For more information please refer to the following page and the link below for additional details for Tree Protection during Construction within The Town of Oakville <u>http://www.oakville.ca/townhall/en-tre-001-001.html</u>

Never allow any construction material, fill or equipment to be stored within the TPZ of any preserved trees.

Site Photos





Mike Boulanger ISA Certified Arborist ON-0893AT Wildwood Tree Services Ltd.

1067 Cedar Grove Boulevard, Oakville



Mike Boulanger ISA Certified Arborist ON-0893AT Wildwood Tree Services Ltd.

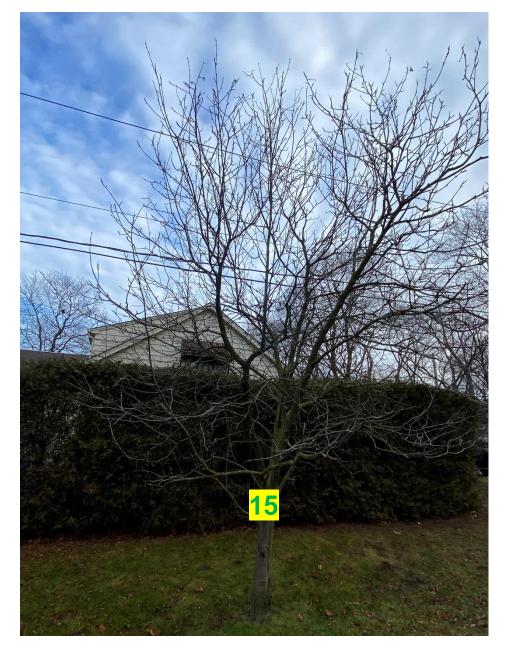

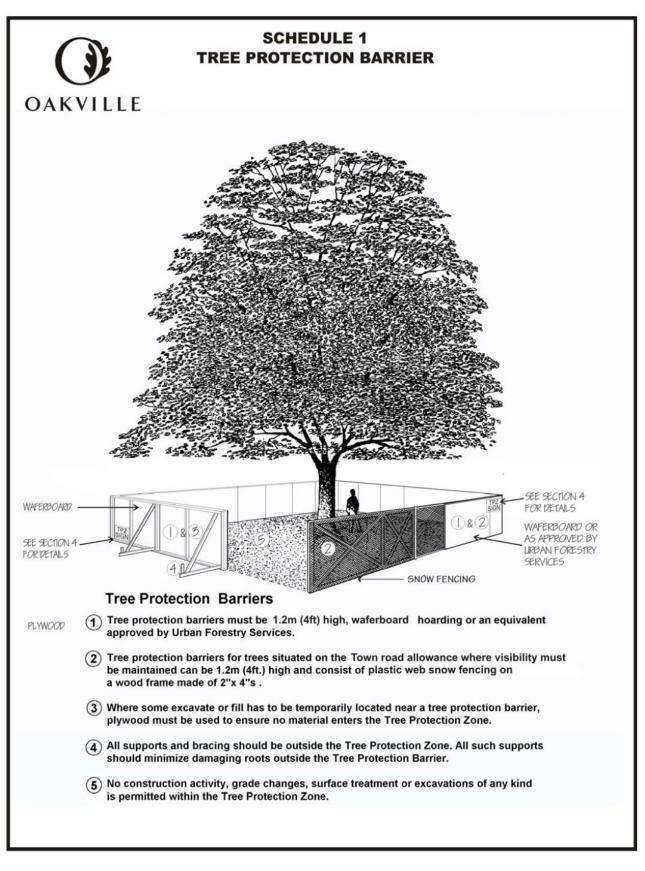

Wildwood Tree Services Ltd. Favored Tree Species for Urban Settings.

Large Shade Trees.

- Sugar Maple, Acer saccharum
- Red Oak, Quercus rubra
- American Beech, Fagus grandifolia
- European Beech, Fagus sylvatica
- Tulip Tree, Liriodendron tulipifera
- Kentucky Coffeetree, Gymnocladus dioicus

Evergreens (Coniferous)

- Silver Fir, Abies concolor
- Canadian Hemlock, Tsuga canadensis
- Eastern White Pine, Pinus strobus
- Colorado Blue Spruce, Picea pungens
- Hicks Yew, Taxus media hicksii
- Black Cedar, Thuja Occidentalis Nigra

Small and Ornamental Trees.

- Hackberry, Celtis occidentalis
- River Birch, Betula nigra
- Chanticleer Pear, Pyrus calleryana chanticleer
- Bradford Pear, Pyrus calleryana bradford
- Paperbark Maple, Acer griseum
- Bloodgood Japanese Maple, Acer palmatum bloodgood
- Siberian Crab Tree, Malus baccata
- Pyramidal English Oak, Quercus robur fastigiata
- Dawyck Purple Beech, Fagus Sylvatica dawyck purple
- Tricoloured Beech, Fagus sylvatica 'Tricolor'
- Florida Dogwood, Cornus florida Std.

It is best to consult an arborist to ensure you are selecting a species that is suitable for its location. A well maintained and carefully selected tree will ensure a tree that is both beautiful and sustainable.

"The true meaning of life is to plant trees, under whose shade you do not expect to sit." ~Nelson Henderson

Business Licence No. 21-112889 Licence type: Arboricultural Qualification(s): Arborist, Certified Tree Worker/Specialist, **Certified Chainsaw Operator** Wildwood Tree Services Ltd. 3448 Ninth Line Oakville ON L6H 7A9 OAKVILLE Issue date: Wildwood Tree Services Ltd. 3448 Ninth Line May 18, 2021 Oakville, ON L6H 7A9 Expiry Date: April 30, 2022 Licensing Commissioner



The International Society of Arboriculture

Hereby Announces That



Mike Boulanger

Has Earned the Credential

ISA Certified Arborist ®

By successfully meeting ISA Certified Arborist certification requirements through demonstrated attainment of relevant competencies as supported by the ISA Credentialing Council

allyn Bellihau

Caitlyn Pollihan CEO & Executive Director

Issue Date

C C R E D I T ISO/IEC17024 ERSONNEL CERTIFICA BODY #0847 ISA Certified Arboris

31 May 2003 30 June 2024

Expiration Date

ON-0893AT

