# TREE PROTECTION NOTE

1. ALL EXISTING TREES WHICH ARE TO REMAIN SHALL BE FULLY PROTECTED WITH HOARDING, ERECTED BEYOND THEIR DRIP LINE PRIOR TO THE ISSUANCE OF THE BUILDING PERMIT. GROUPS OF TREES AND OTHER EXISTING PLANTINGS TO BE PROTECTED, SHALL BE TREATED IN A LIKE MANNER, WITH THE HOARDING AROUND THE ENTIRE CLUMP(S). AREAS WITHIN THE PROTECTIVE FENCING SHALL REMAIN UNDISTURBED AND SHALL NOT BE USED FOR THE STORAGE OF THE BUILDING MATERIAL AND EQUIPMENT

2. NO RIGGING CABLES SHALL BE WRAPPED AROUND OR INSTALLED IN TREES AND SURPLUS SOIL, EQUIPMENT, DEBRIS OR MATERIALS SHALL NOT BE PLACED OVER ROOT SYSTEMS OF THE TREES WITHIN THE PROTECTIVE FENCING. NO CONTAMINANTS WILL BE DUMPED OR FLUSHED WHERE FEEDER ROOTS OF TREES EXIST.

3. THE DEVELOPER OR HIS/HER/ITS AGENTS SHALL TAKE EVERY PRECAUTION NECESSARY TO PREVENT DAMAGE TO TREES OR SHRUBS TO 4. WHERE LIMBS OR PORTIONS OF TREES ARE REMOVED TO ACCOMODATE

CONSTRUCTION WORK, THEY WILL BE REMOVED CAREFULLY IN ACCORDANCE WITH ACCEPTED ARBORICULTURAL PRACTICE. 5. WHERE ROOT SYSTEMS OF PROTECTED TREES ARE EXPOSED DIRECTLY TO, OR DAMAGED BY CONSTRUCTION WORK, THEY SHALL BE TRIMMED

NEATLY AND THE AREA BACKFILLED WITH APPROPRIATE MATERIAL TO PREVENT DESICCATION. 6. WHERE NECESSARY, THE TREES WILL BE GIVEN AN OVERALL PRUNING TO RESTORE THE BALANCE BETWEEN ROOTS AND TOP GROWTH OR TO RESTORE

THE PPEARANCE OF THE TREES. 7. IF GRADES AROUND TREES TO BE PROTECTED ARE LIKELY TO CHANGE, THE OWNER SHALL BE REQUIRED TO TAKE SUCH PRECAUTIONS AS DRY WELLING, RETAINING WALLS AND ROOT FEEDING TO THE SATISFACTION OF THE PLANNING AND BUILDING DEPARTMENT OF THE TOWN OF OAKVILLE.

8. GRADE CHANGES WILL NOT OCCUR WITHIN THE TREE PROTECTION ZONE (TPZ) 9. UTILITY ACCESS CORRIDOR MUST BE OUTSIDE THE TPZ

AND/OR NO OPEN TRENCH METHOD OF CONSTRUCTION BELOW-GROUND AS WELL AS NO ABOVE-GROUND LINES WITHIN THE TPZ.

# STANDARD DEVELOPMENT NOTES:

# (A) TRANSPORTATION AND WORKS DEPARTMENT

1. MUNICIPAL BOULEVARD TO BE RESTORED TO THE SATISFACTION OF ENGINEERING CONSTRUCTION STAFF.

2. RESTORE THE PUBLIC ROADWAY TO TOWN STANDARDS AND CLEARLY INDICATE ON THE ENGINEERING DRAWINGS ALL RESTORATION, TO THE SATISFACTION OF THE ENGINEERING & CONSTRUCTION DEPARTMENT.

3. DRIVEWAYS ON THE MUNICIPAL RIGHT-OF-WAY SHALL BE PAVED BY THE APPLICANT. 4. AT THE ENTRANCES TO THE SITE, THE MUNICIPAL CURB AND SIDEWALK WILL BE CONTINUOUS THROUGH THE DRIVEWAY AND A CURB DEPRESSION WILL BE PROVIDED FOR THE ENTRANCE.

5. THE TOPS OF ANY CURBS BORDERING THE DRIVEWAYS WITHIN THE MUNICIPAL BOULEVARD WILL BE FLUSH WITH THE MUNICIPAL SIDEWALK AND ROAD CURB.

# (B) GENERAL NOTES

1. THE EXISTING GRADES SHOWN ON THIS DRAWING ARE TO REMAIN UNCHANGED. 2. THERE IS NO EASEMENTS REGISTERED ON TITLE AND AFFECTING THE SUBJECT LANDS. 3. THE STOCKPILING OF CONSTRUCTION MATERIAL TO BE DONE AT THE FRONT OF THE PROPOSED DWELLING ON THE EXISTING DRIVEWAY.

4. ALL ROOF DOWNSPOUTS FROM EAVESTROUGH TO DISCHARGE ONTO SURFACE AND THE RUNOFF DIRECTED TOWARDS THE REAR WHERE POSSIBLE AND TO THE ROAD. 5. ROOF DOWNSPOUT IS LOCATED IN SUCH MANNER AS TO DIRECT DRAINAGE AWAY FROM WALKWAYS, DRIVEWAYS OR PATIO AREAS.

6. MAINTAIN EXISTING GRADES IN AREA AROUND TREES TO BE PRESERVED. 7. PRIOR TO CONSTRUCTION, CONTRACTOR TO VERIFY IN FIELD THE EXACT SIZE AND INVERTS OF THE EXISTING WATER SERVICE CONNECTION AND SEWER CONNECTIONS AND REPORT IT TO THE ENGINEER.

8. ALL SURPLUS/EXCAVATED MATERIAL TO BE REMOVED FROM THE SITE. 9. CONTRACTOR TO MATCH EXISTING GRADES ALONG PROPERTY LINES.

10. ALL DISTURBED AREAS WITHIN EXISTING ROAD ALLOWANCE TO BE REINSTATED WITH TOPSOIL AND SOD TO THE SATISFACTION OF THE TOWN OF OAKVILLE.

11. THE CONTRACTOR IS TO CHECK AND VERIFY ALL DIMENSIONS, IF ANY DISCREPANCIES, THEY MUST BE REPORTED TO THE ENGINEER IMMEDIATELY PRIOR TO CONSTRUCTION. 12. THE CONTRACTOR IS RESPONSIBLE FOR LOCATING AND PROTECTING ALL UTILITIES

DURING CONSTRUCTION. GAS, HYDRO, TELEPHONE OR ANY OTHER UTILITIES THAT MAY EXIST ON THE SITE OR WITHIN THE STREETLINE MUST BE LOCATED BY ITS OWN UTILITIES AND VERIFIED PRIOR TO CONSTRUCTION.

13. ALL CONNECTIONS SHALL BE INSTALLED AS PER REGION OF HALTON STANDARDS AND SPECIFICATIONS.

14. BUILDER IS TO VERIFY TO THE ENGINEER THAT THE FINAL FOOTING ELEVATION AND TOP OF FOUNDATION WALL ELEVATION ARE IN CONFORMITY WITH THE BUILDING CODE AND THE CERTIFIED GRADING PLAN PRIOR TO PROCEEDING.

15. OUTSIDE FINISHED GRADE TO BE A MINIUMUM OF 150 mm BELOW BRICK/STONE VENEER ELEVATION.

16. PRIOR TO ANY SODDING, THE BUILDER IS TO ENSURE TO THE SOIL CONSULTANT AND/OR THE ENGINEER THAT THE LOT HAS BEEN GRADED AND TOPSOILED AND SODDED COMPLETELY WITH A MINIMUM DEPTH OF 100 mm OF TOPSOIL AND N° 1 NURSERY SOD AND A MINIMUM DEPTH OF 150 mm CRUSHED STONE TO BE PROVIDED ON THE ENTIRE LENGTH OF EACH DRIVEWAY ON A FIRM SUBGRADE AND THE DRIVEWAY TO BE PAVED WITH A MINIMUM COMPACTED DEPTH OF 75 mm OF ASPHALT BETWEEN THE CURB AND THE GARAGE. 17. NO SODDING ON ANY LOT IS PERMITTED UNTIL PRELIMINARY INSPECTION IS DONE BY

THE ENGINEER AND THE BUILDER. 18. DRIVEWAY GRADES SHOULD BE NOT LESS THAN 1.0% AND NOT GREATER THAN 7.0%.

19. LAWN AND SWALES SHALL HAVE MINIMUM SLOPE OF 2.0% AND A MAXIMUM SLOPE OF 5.0% AND HAVE A MINIMUM DEPTH OF 150mm.

20. WHERE GRADES IN EXCESS OF 5.0% ARE REQUIRED, THE MAXIMUM SLOPE SHALL BE 3:1. GRADE CHANGES IN EXCESS OF 1.0 m ARE TO BE ACCOMPLISHED BY USE OF A RETAINING WALL. RETAINING WALLS HIGHER THAN 0.6 m SHALL HAVE A FENCE INSTALLED ON THE HIGH SIDE.


21. THE SERVICE CONNECTION TRENCH THROUGH THE TRAVELLED PORTION OF THE ROAD ALLOWANCE SHALL BE BACKFILLED WITH UNSHRINKABLE BACKFILL MATERIAL AS PER TOWN OF OAKVILLE STANDARDS UNLESS OTHERWISE SPECIFIED PRIOR APPROVAL FOR OTHER BACKFILL MATERIAL HAS BEEN OBTAIN.

22. ALL WATERMAINS AND WATER SERVICE MATERIALS AND CONSTRUCTION METHODS MUST CORRESPOND TO CURRENT REGION OF HALTON STANDARDS AND SPECIFICATIONS. A MINIMUM HORIZONTAL SPACING OF 2.5 m FROM THEMSELVES AND OTHER SERVICES. 24. SEDIMENT CONTROL FENCE TO BE INSTALLED AS PER THE TOWN OF OAKVILLE STANDARDS. 25. ALL DAMAGED AND DISTURBED AREAS TO BE REINSTATED WITH TOPSOIL AND SOD.

# (C) UTILITIES CONNECTION

1. SANITARY: (A) MUNICIPAL SANITARY SEWER AVAILABLE ON THE SITE. 2. WATER: (A) SERVICE CONNECTIONS TO BE 25mm DIA. TYPE 'K' SOFT COPPER TUBING UNLESS OTHERWISE NOTED AS PER REGION OF HALTON STANDARDS. (B) PROPOSED 32mm WATER SERVICE ON PRIVATE SIDE.

3. STORM: (A) A SUMP PUMP WILL BE REQUIRED TO DRAIN THE BASEMENT FACILITIES.

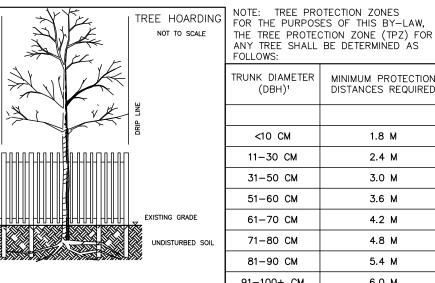

RESTORED AND SODDED. THE BOULEVARD IS

TO BE RESTORED TO THE SATISFACTION OF IL

EXISTING 380mm Ø SANITARY SEWER

The existing sanitary lateral must be inspected at the

A lateral that does not meet current Regional standards must be disconnected at the main. A revision to

EXISTING I50mm Ø WATERMAIN

FXISTING 550mm Ø STORM SEWER

— STM. —

property line by the Regional Inspector, and televised by Regional forces PRIOR to connection.

the Service Permit, drawings and payment of


applicable fees is required

\_\_\_\_\_ SAN. \_\_\_\_ SAN. \_\_\_\_ SAN. \_\_\_\_ SAN.

ENGINEERING AND CONSTRUCTION DEPARTMENT.

OPEN TRENCHING WILL NOT BE PERMITTED WITHIN TREE

O BE HORIZONTALLY BORED ONLY

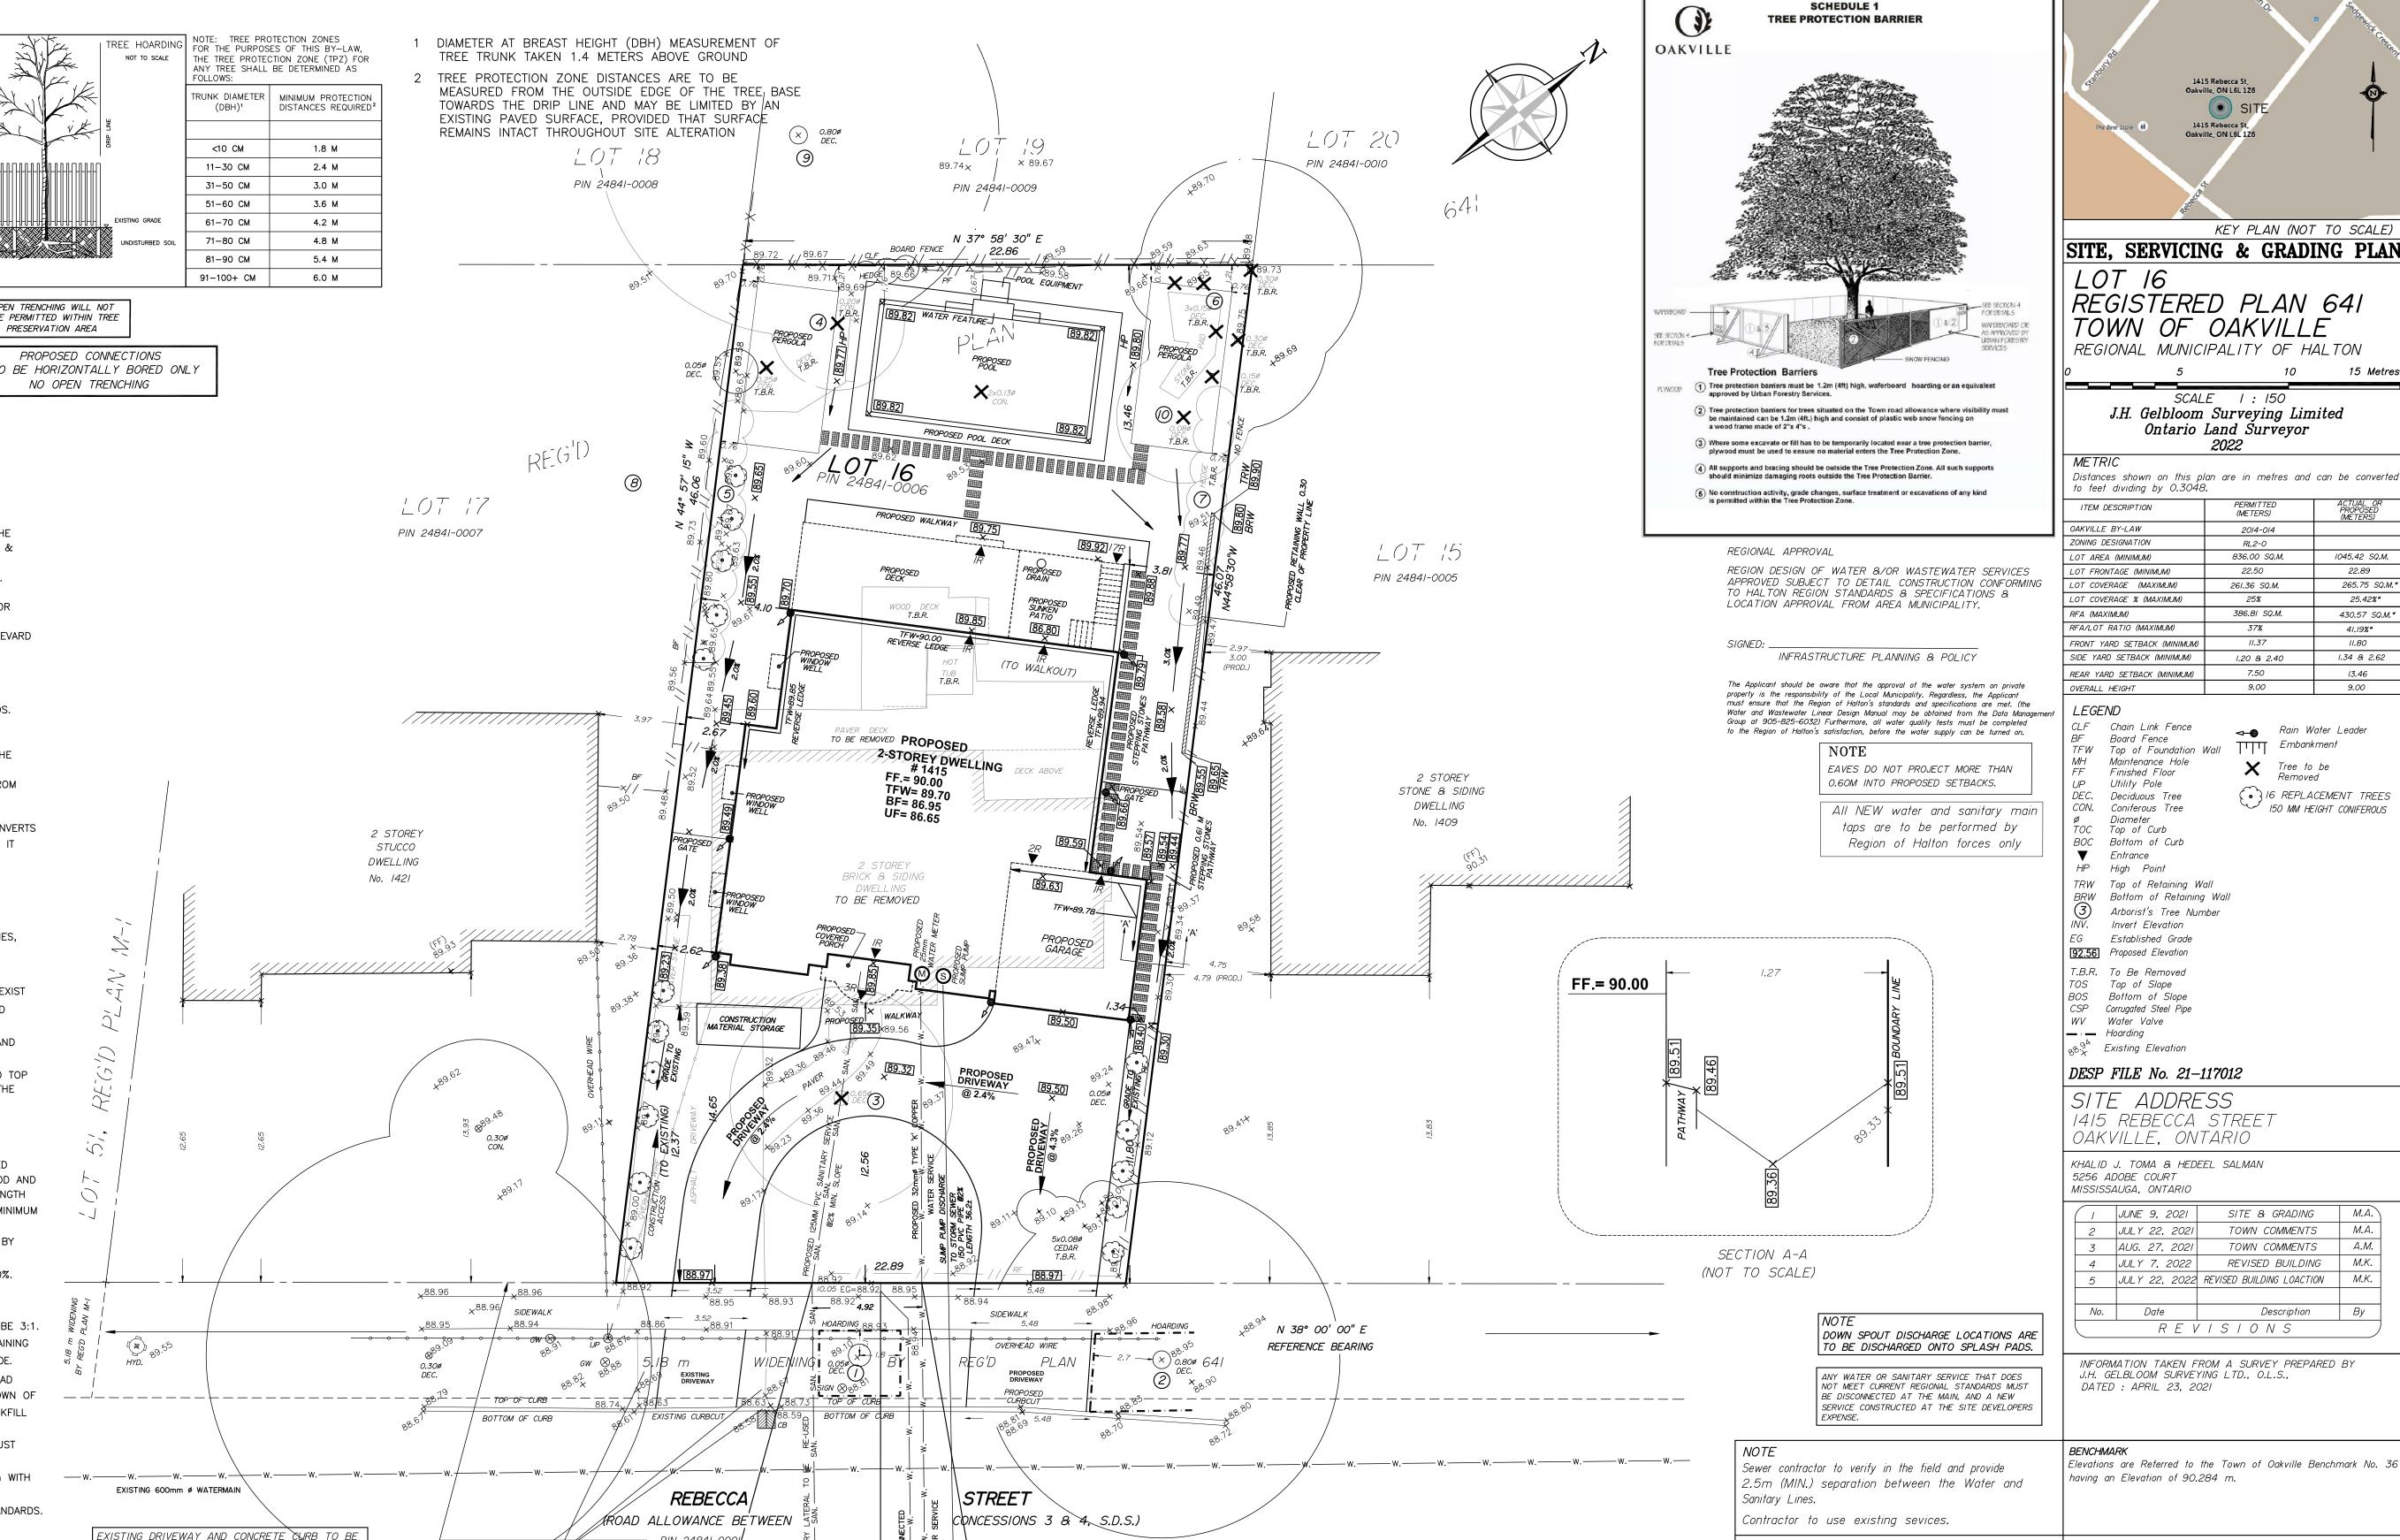

PROPOSED 25MM COPPER 'K' WATER SERVICE

TAP BY REGION OF HALTON FORCES ONLY

\_\_\_\_\_\_ STM. \_\_\_\_\_\_ STM. \_\_\_\_\_ STM. \_\_\_\_\_ STM. \_\_\_\_\_ STM. \_\_\_\_ STM. \_\_\_\_ STM. \_\_\_\_ STM. \_\_\_\_ STM. \_\_\_\_ STM. \_\_\_

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---PROPOSED CONNECTIONS

STORM INVERT= 85.4 +/-

STORM INVERT - 55.7 // STORM OBVERT= 87.0 +/-CALCULATED FROM REGION OF HALTON ENGINEERING DRAWING 0-5184

INVERT= 87.0 +/-

PIN 24841-000

SANITARY INVERT= 84.6 +/-

XISTING WATER TO BE DISCONNECTED

AS PER REGION OF HALTON STANDARDS

AT THE MAIN BY THE CONTRACTOR

CALCULATED FROM REGION OF HALTON ENGINEERING DRAWING 0-5184

CFNTRELINE OF ROAD

TOWN COMMENTS 2 JULY 22, 2021 M.A.A.M.3 | AUG. 27, 2021 | TOWN COMMENTS 4 JULY 7, 2022 REVISED BUILDING 5 JULY 22, 2022 REVISED BUILDING LOACTION Date Description REVISIONS

> INFORMATION TAKEN FROM A SURVEY PREPARED BY J.H. GELBLOOM SURVEYING LTD., O.L.S., DATED : APRIL 23, 2021

SITE & GRADING

1415 Rebecca St, Oakville, ON L6L 1Z6

Oakville, ON L6L 1Z6

J.H. Gelbloom Surveying Limited

ITEM DESCRIPTION

T ARFA (MINIMUM)

T FRONTAGE (MINIMUM)

T COVERAGE (MAXIMUM)

T COVERAGE % (MAXIMUM)

Board Fence

Maintenance Hole

Finished Floor

Deciduous Tree

Arborist's Tree Number

Invert Flevation

Top of Slope

Bottom of Slope

ı | JUNE 9, 2021 |

Utility Pole

Top of Curb

Ontario Land Surveyor

2014-014

RL2-0

22.50

261.36 SQ.M.

25%

386.81 SQ.M.

1.20 & 2.40

7.50

9.00

**→** Rain Water Leader

Tree to be

Embankment

( ) 16 REPLACEMENT TREES

150 MM HEIGHT CONIFEROUS

37%

836.00 SQ.M.

1045.42 SQ.M.

265.75 SQ.M.

25.42%\*

430.57 SQ.M.

41.19%\*

11.80

1.34 & 2.62

13.46

9.00

22.89

( SIT

KEY PLAN (NOT TO SCALE)

by the Regional Inspector, and televised

PROPERTIES AND EXISTING MUNICIPAL SERVICES. IT IS MY BELIEF THA ADHERENCE TO THE PROPOSED ELEVATIONS AND GRADIENTS SHOWN WIL PRODUCE ADEQUATE SURFACE DRAINAGE AND PROPER FACILITY OF THE MUNICIPAL SERVICES WITHOUT DETRIMENTAL EFFECT TO THE EXISTING DRAINAGE PATTERNS OR ADJACENT PROPERTIES. I HEREBY CERTIFY THAT THE DIMENSIONS AND SET-BACKS ARE CORRECTLY SHOWN.

I HAVE REVIEWED THE PLANS FOR THE CONSTRUCTION OF A TWO STORE)

DWELLING LOCATED AT 1415 REBECCA STREET AND HAVE PREPARED THIS PLAI

TO INDICATE THE COMPATIBILITY OF THE PROPOSAL WITH ALL ADJACENT

SURVEYOR'S CERTIFICATE



J. H. Gelbloom Surveying Limited | Project: Ontario Land Surveyor 476 Morden Road, Unit 102, Oakville, Ont., L6K 3W4 Drawn By: office@jhgsurveying.ca Phone:(905) 338-8210 Fax:(905) 338-9446

f the existing sanitary service lateral is used, t must be inspected at the property line by Regional forces PRIOR to connection


— SAN. ——— SAN. ——— SAN. ——— SAN.——— SAN.———

97.07 (MH TO MH) (NOT TO SCALE)

THIS LOT REQUIRES A SUMP PUMP FOR THE FOUNDATION DRAINS AND SHALL DISCHARGE TO THE STORM SEWER. COMPLETE WITH BACKFLOW PREVENTER.

Service sizes, inverts and types are derived from the Region of Halton Engineering Department Dwg. No. 0-5184 The contractor must verify inverts.

JULY 25, 2022 DATE Checked By: A.M. Party Chief:

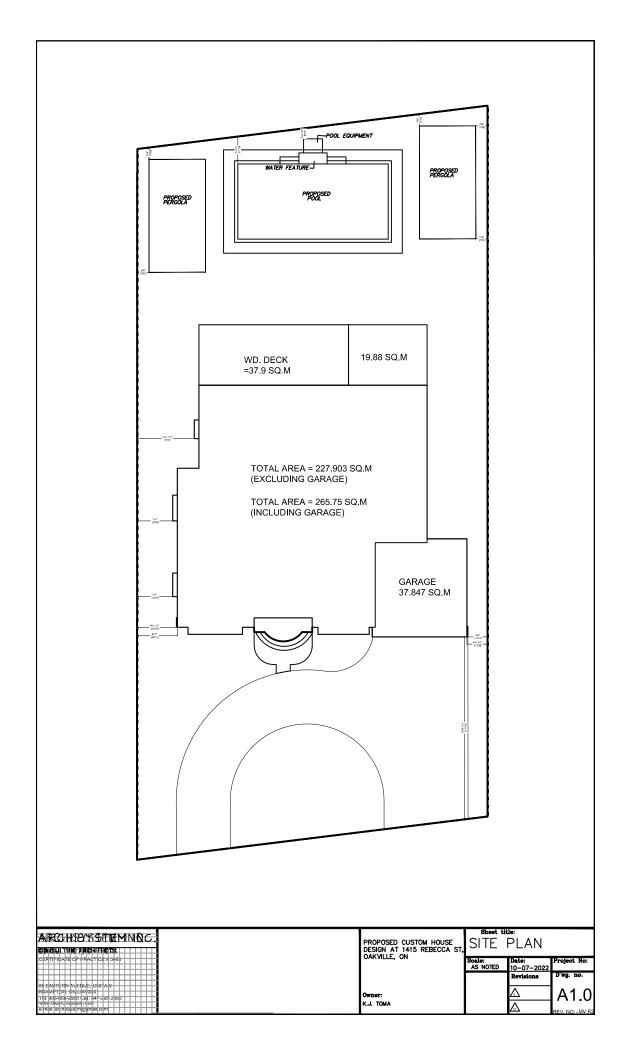



ARTIST ILLUSTRATION

PROJECT ARCHITEC

### ARCHISYSTEM INC.

CONTRACTOR OF WARTON OR OF CONTRACTOR OF CON

#### MOTEO.

THE DRAWINGS SHALL NOT BE SCALED THE COMPARATOR SHALL WERFY ALL DIMENSIONS, DATUM AN LEWIS PREST TO COMMISSION THE WORK, PAULISE TO THAT THE CONTRACTOR WILL BE LIMBLE TO RECEIP! WITHOUT EXTRA DOST.

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### OWNER/CLIENT:

Engineers:

BUILDING PERMIT 01.27.2 ISSUED FOR: DATE





CUSTOM DESIGN HOUSE 1415 REBECCA ST. OAKVILLE, ON.


DRAWING TITLE:

BUILDING PERMIT APPLICATION

T TITLE:

ARTIST ILLUSTRATION

JOB #:	
SCALE:	AS NOTED
SHEET NO:	A1.0
REV NO.	MV R

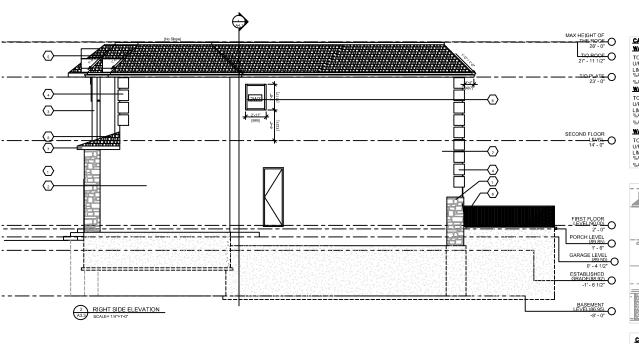

#### CALCULATION OF UNPROTECTED OPENINGS OBC 2012 (9.10.14.4) WALL #1

TOTAL EXPOSED WALL AREA U/P WINDOW AREA =39.95 SQ M =8.89 SQ M =4 M =32% = 12.31 SQ.M =23.10% =8.89 SQ.M LIMITING DISTANCE %AGE ALLOWED @1.5M<100 SQ.M %AGE OF TOTAL UNPROTECTED WINDOWS PROPOSED

WALL #2

TOTAL EXPOSED WALL AREA
U/P WINDOW AREA
LIMITINS DISTANCE
%AGE ALLOWED @1.5M<100 SQ.M
%AGE OF TOTAL UNPROTECTED WINDOWS PROPOSED

WALL #3 TOTAL EXPOSED WALL AREA 101 AL EXPOSED WALL AREA
UP WINDOW AREA
LIMITING DISTANCE
%AGE ALLOWED @1.5M<100 SQ.M
%AGE OF TOTAL UNPROTECTED WINDOWS PROPOSED

=40.32 SQ.M =1.72 SQ.M =2.55 M =15% = 6.04 SQ.M =4.26% =1.72 SQ.M

=36.71 SQ.M =4.10 SQ.M =3.01 M =20% = 7.34 SQ.M =11.17% =4.10 SQ.M

WALL #1

### CALCULATION OF UNPROTECTED OPENINGS OBC 2012 (9.10.14.4)

TOTAL EXPOSED WALL AREA U/P WINDOW AREA =31.27 SQ.M =1 SQ.M =5.35 M =32% = 1.02 SQ.M =3.2% =1 SQ.M UIP WINDUW AREA
LIMITING DISTANCE
%AGE ALLOWED @1.5M<100 SQ.M
%AGE OF TOTAL UNPROTECTED WINDOWS PROPOSED

	KEY LEGENDS FOR ELEVATION	
1	CULTURED STONE COLOUR TBD	
	STUCCO COLOUR T.B.D.	
- 3	STUCCO FINISH COLUMN AS ELEVATIONAL FEATURE	
_ 4	CULTURED STONE QUOINS COLOUR TBD	
	ASHPHALT SHINGLES COLOUR TBD	
- 6	VINYL FRAMED DBL:GLAZED WINDOW	
7	CANAMOLD STYROFOAM MOULDING W/STUCCO FINISH	
- 8	3' HIGH GUARD RAIL	

ARCHISYSTEM INC.

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WITHOUT CORRECTIONS TO PREVAIL BUT CONTROL

PLANTS CORP.

OWNER / CLIENT K.J. TOMA

BUILDING PERMIT





CUSTOM DESIGN HOUSE 1415 REBECCA ST. OAKVILLE, ON.

BUILDING PERMIT
APPLICATION

**ELEVATIONS** 

SHEET NO: A3.3 MV R2

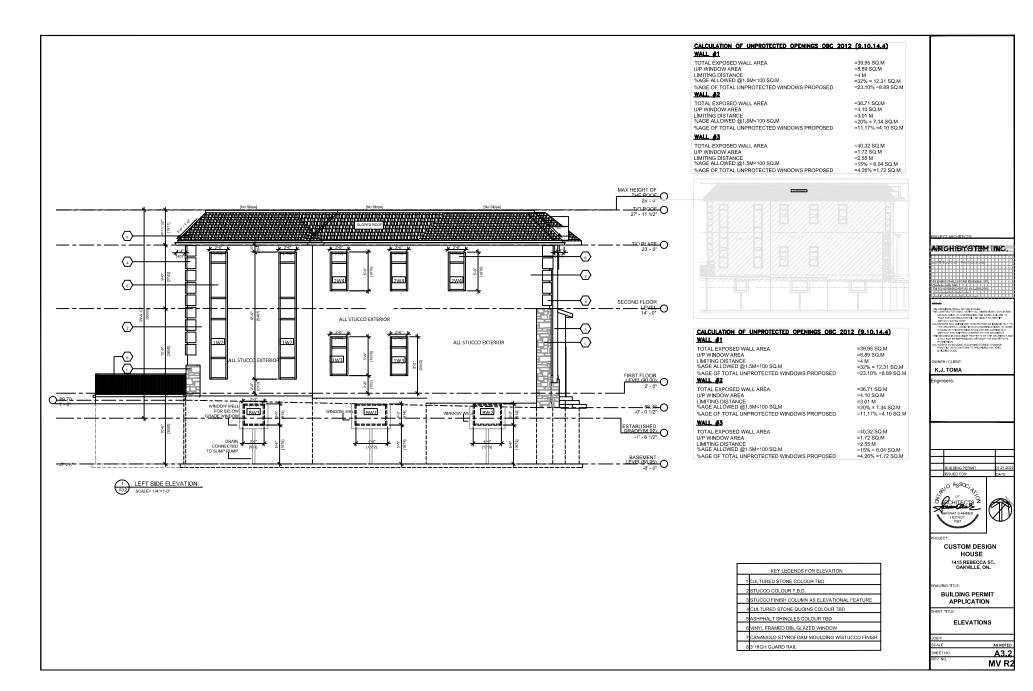

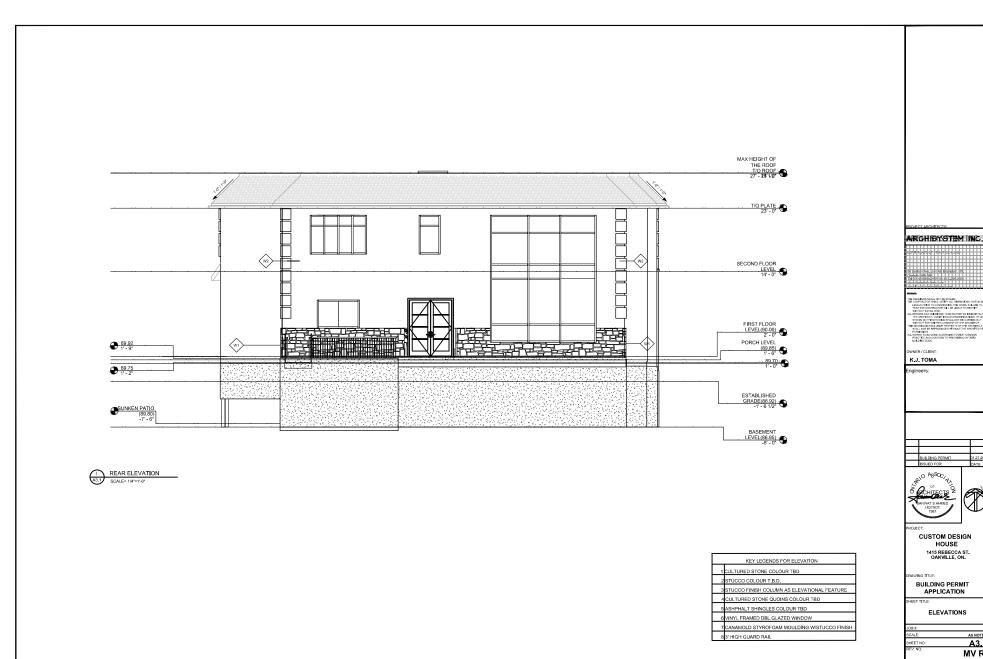

AS NOTED

MV R2



1 FRONT ELEVATION
A3.0 SCALE= 1/4"=1'-0"

	KEY LEGENDS FOR ELEVATION
1	CULTURED STONE COLOUR TBD
2	STUCCO COLOUR T.B.D.
3	STUCCO FINISH COLUMN AS ELEVATIONAL FEATURE
4	CULTURED STONE QUOINS COLOUR TBD
5	ASHPHALT SHINGLES COLOUR TBD
6	VINYL FRAMED DBL.GLAZED WINDOW
7	CANAMOLD STYROFOAM MOULDING W/STUCCO FINISH
8	3' HIGH GUARD RAIL
	2 3 4 5 6

### ARCHISYSTEM INC.

Control of Anthonic Information and Control of Control

OWNER / CLIENT: K.J. TOMA

BUILDING PERMIT



CUSTOM DESIGN HOUSE 1415 REBECCA ST. OAKVILLE, ON.

AWING TITLE:

BUILDING PERMIT
APPLICATION

ELEVATIONS

JOB#:	
SCALE:	AS NOTED
SHEET NO:	A3.4
REV NO.	MV D