

## TREE PROTECTION BARRIERS

- TREE PROTECTION BARRIERS MUST BE 1.2m (4'-0") HIGH, WAFERBOARD HOARDING OR AN EQUIVALENT APPROVED BY URBAN FORESTRY SERVICES. TREE PROTECTION BARRIERS FOR TREES SITUATED ON THE TOWN ROAD ALLOWANCE WHERE VISIBILITY MUST BE MAINTAINED CAN BE 1.2m (4'-0") HEIGHT AND CONSIST OF ORANGE PLASTIC WEB SNOW FENCING ON A WOOD FRAME MADE OF 2"X4"'S.
- WHERE SOME EXCAVATE OR FILL HAS TO BE TEMPORARILY LOCATED NEAR A TREE PROTECTION BARRIER, PLYWOOD MUST BE USED TO ENSURE NO MATERIAL ENTERS THE TREE PROTECTION ZONE.
- ALL SUPPORTS AND BRACING SHOULD BE OUTSIDE THE TREE PROTECTION ZONE. ALL SUCH SUPPORTS SHOULD MINIMIZE DAMAGING ROOTS OUTSIDE THE TREE
- NO CONSTRUCTION ACTIVITY, GRADE CHANGES, SURFACE TREATMENT OR EXCAVATIONS OF ANY KIND IS PERMITTED WITHIN THE TREE PROTECTION ZONE.
- ALL LOCATES MUST BE OBTAINED PRIOR TO THE INSTALLATION OF THE PROPOSED HOARDING WITHIN THE MUNICIPAL RIGHT OF WAY.

## | SECTION 4, SIGNAGE


A SIGN (AS PER BELOW) MUST BE MOUNTED ON ALL SIDES OF A TREE PROTECTION BARRIER FOR THE DURATION OF THE PROJECT. THE SIGN SHOULD BE A MINIMUM OF 40cmX60cm AND MADE OF WHITE GATOR BOARD OR EQUIVALENT MATERIAL.

TREE PROTECTION ZONE NO GRADE CHANGE, STORAGE OF MATERIALS OR EQUIPMENT IS PERMITTED WITHIN THIS AREA. THE TREE PROTECTION BARRIER MUST NOT BE REMOVED WITHOUT THE WRITTEN AUTHORIZATION OF THE TOWN OF OAKVILLE."

> TOWN OF OAKVILLE PARKS AND RECREATION DEPARTMENT


NAME: TREE PROTECTION BARRIERS


1 OAKVILLE SITE REQUIREMENTS
A1.2 SCALE: NTS

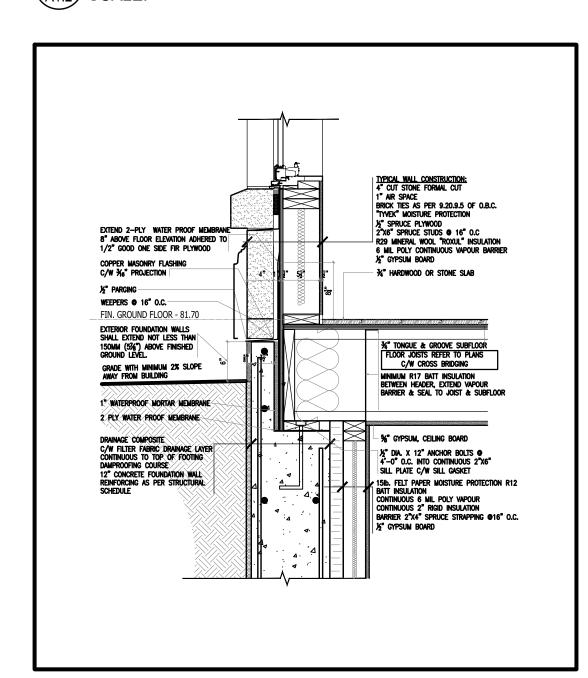


2 REVERSE LEDGE AT GRADE DETAIL
A1.2 SCALE: NTS


3 SITE PLAN A1.2 SCALE: 1:150

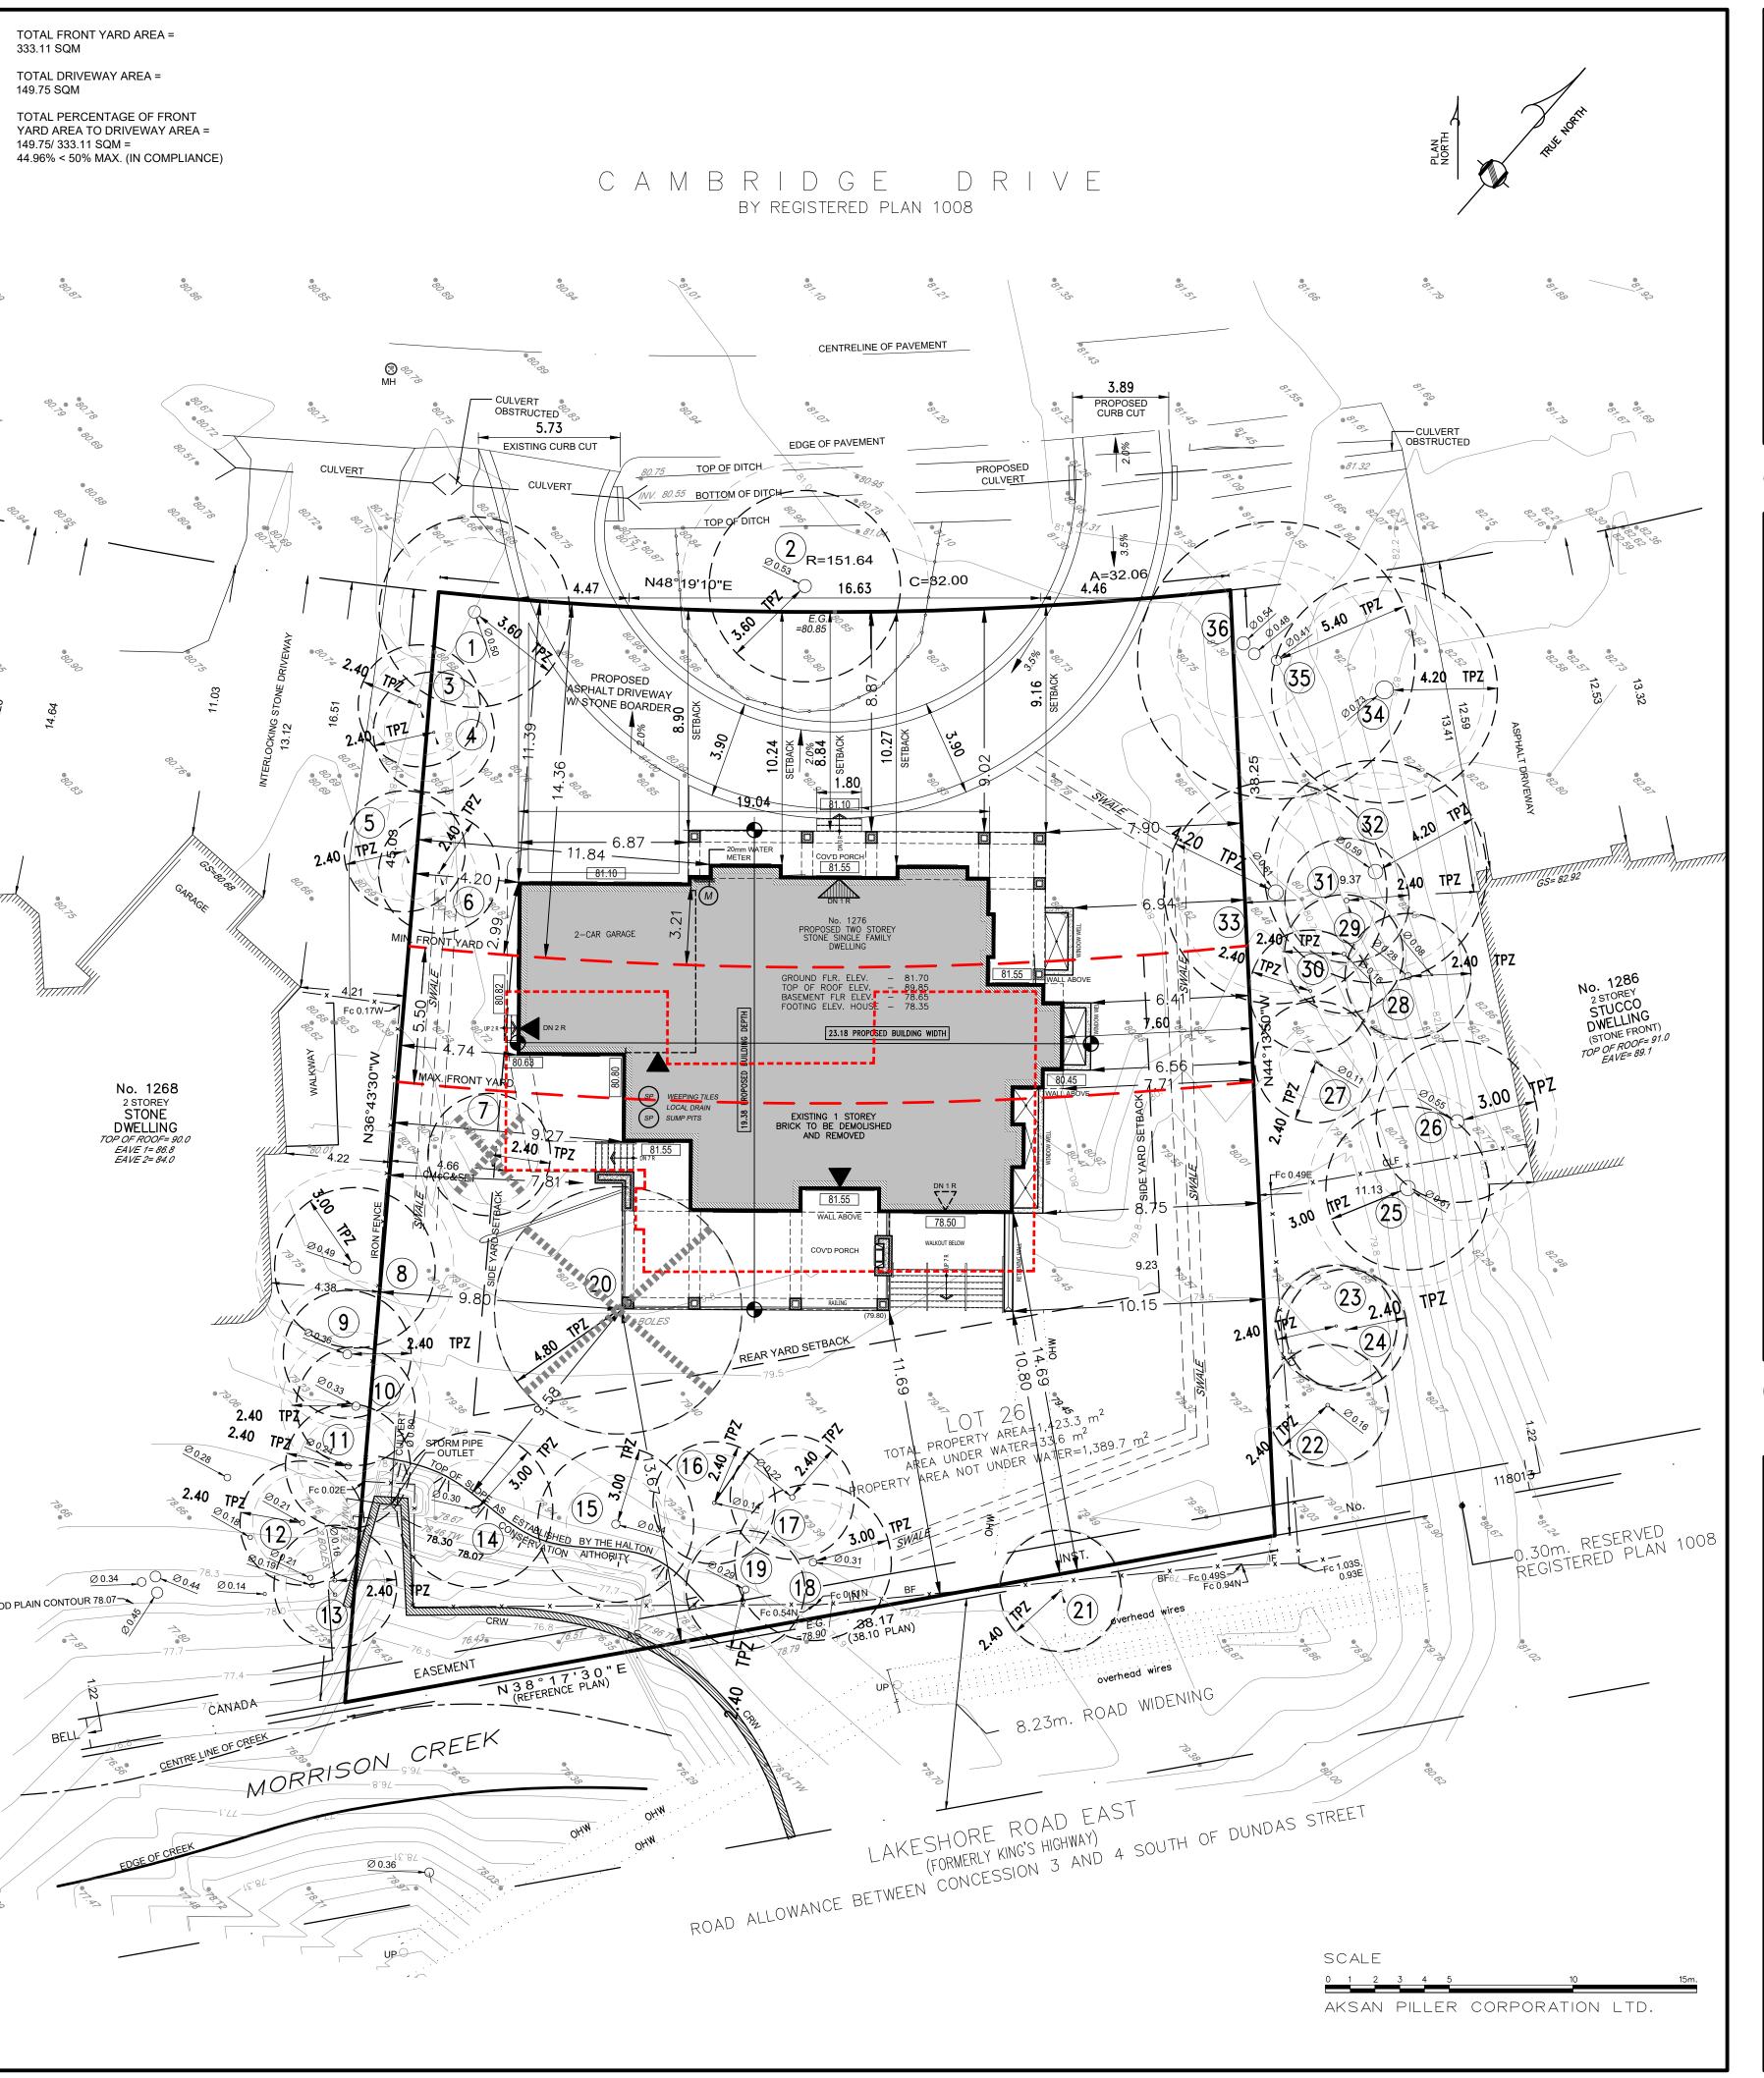

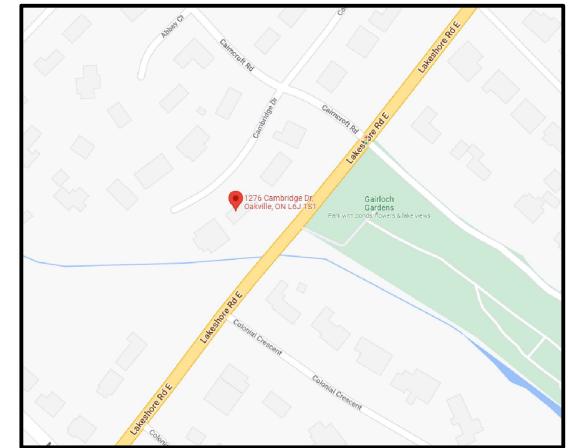

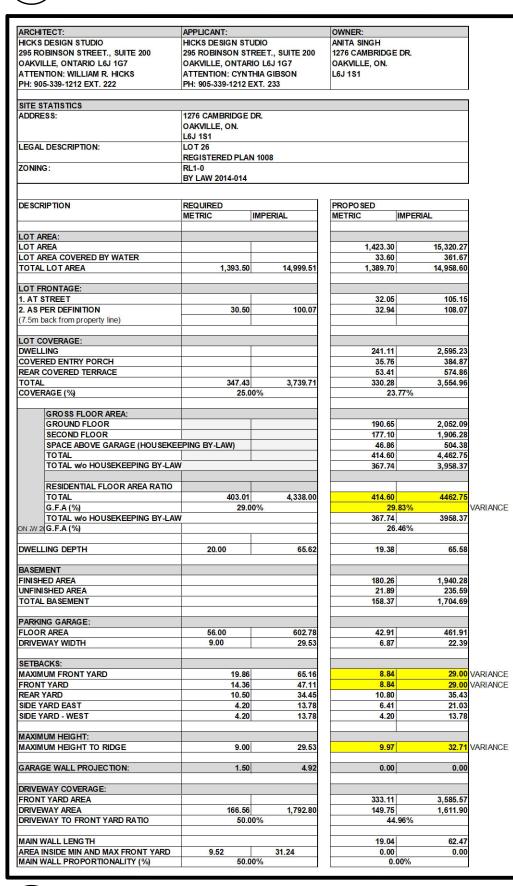


5 SITE STATS A1.2 SCALE: NTS

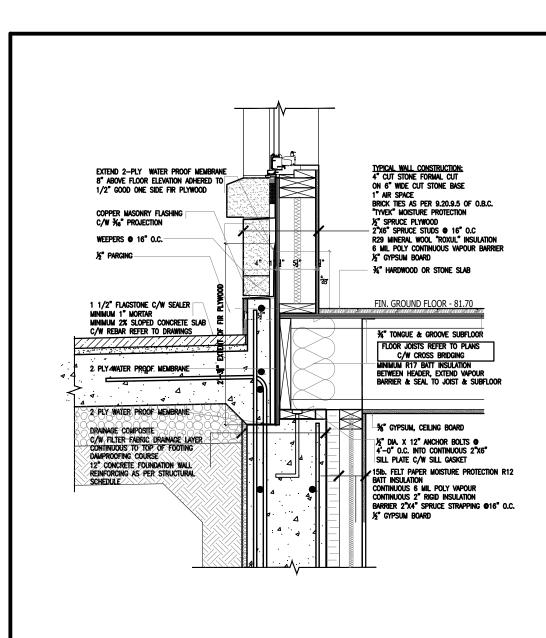

6 REVERSE LEDGE DETAIL AT PORCH
A1.2 SCALE: NTS



Drawings must NOT be scaled. Contractor must check and verify all dimensions, specifications and drawings on site and report any discrepancies to the architect prior to proceeding with any of the work.

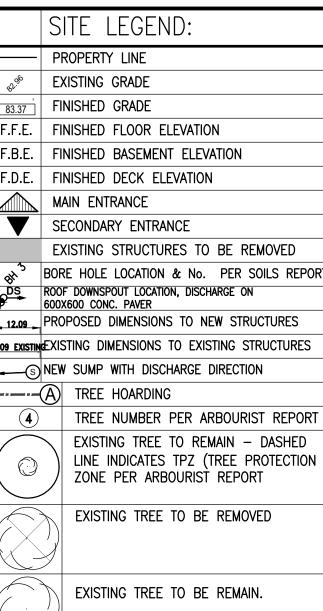

APPROVED SUBJECT TO DETAIL CONSTRUCTION CONFORMING O HALTON REGION STANDARDS AND SPECIFICATIONS AND OCATION APPROVAL FROM AREA MUNICIPALITY. Planning & Public Works Department

REGION OF HALTON CERTIFICATE

EGION DESIGN OF WATER AND/OR WASTEWATER SERVICES

The Applicant should be aware that the approval of the water system on private property is the responsibility of the Local Municipality. Regardless, the Applicant must ensure that the Region of Halton's standards and specifications are met. (The Design Criteria, Standard Drawings & Specifications manual may be obtained thru Capital Planning & Data Technologies Department at 905-825-6032).

urthermore, all water quality tests must be completed to the egion of Halton's satisfaction, before the water supply can be

| 22.05.25 | ISSUED FOR C OF A DATE: DESCRIPTION:

REVISIONS / ISSUANCE:



295 ROBINSON STREET, SUITE 200 OAKVILLE ON, CAN L6J 1G7 WWW.HICKSDESIGNSTUDIO.CA T.905.339.1212

GREWAL AND SINGH RESIDENCE

ADDRESS: 1276 CAMBRIDGE DRIVE

OAKVILLE, ON.

DRAWING TITLE: SITE PLAN

DRAWN: EO DATE: 22.03.24 SCALE: 1:150 JOB NUMBER: SHEET NUMBER:

A1.2 21-319



Drawings must  $\underline{\text{NOT}}$  be scaled. Contractor must check and verify all dimensions, specifications and drawings on site and report any discrepancies to the architect prior to proceeding with any of the work.



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# GREWAL SINGH RESIDENCE

ADDRESS: 1276 CAMBRIDGE DRIVE CITY: OAKVILLE, ON.

DRAWING TITLE: NORTH ELEVATION

21-3	19		<b>A4.1</b>
JOB NUMBER:		SHEET N	IUMBER:
DATE:	22-05-24	SCALE:	1/4"=1'-0"
DRAWN: E.O.			



Drawings must  $\underline{\text{NOT}}$  be scaled. Contractor must check and verify all dimensions, specifications and drawings on site and report any discrepancies to the architect prior to proceeding with any of the work.



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GREWAL SINGH RESIDENCE

ADDRESS: 1276 CAMBRIDGE DRIVE CITY: OAKVILLE, ON.

DRAWING TITLE: SOUTH ELEVATION

DRAWN: E.O.

DATE: 22-05-24 SCALE: 1/4"=1'-0" JOB NUMBER: SHEET NUMBER: 21-319

**A4.3** 



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GREWAL SINGH RESIDENCE

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ADDRESS: 1276 CAMBRIDGE DRIVE CITY: OAKVILLE, ON.

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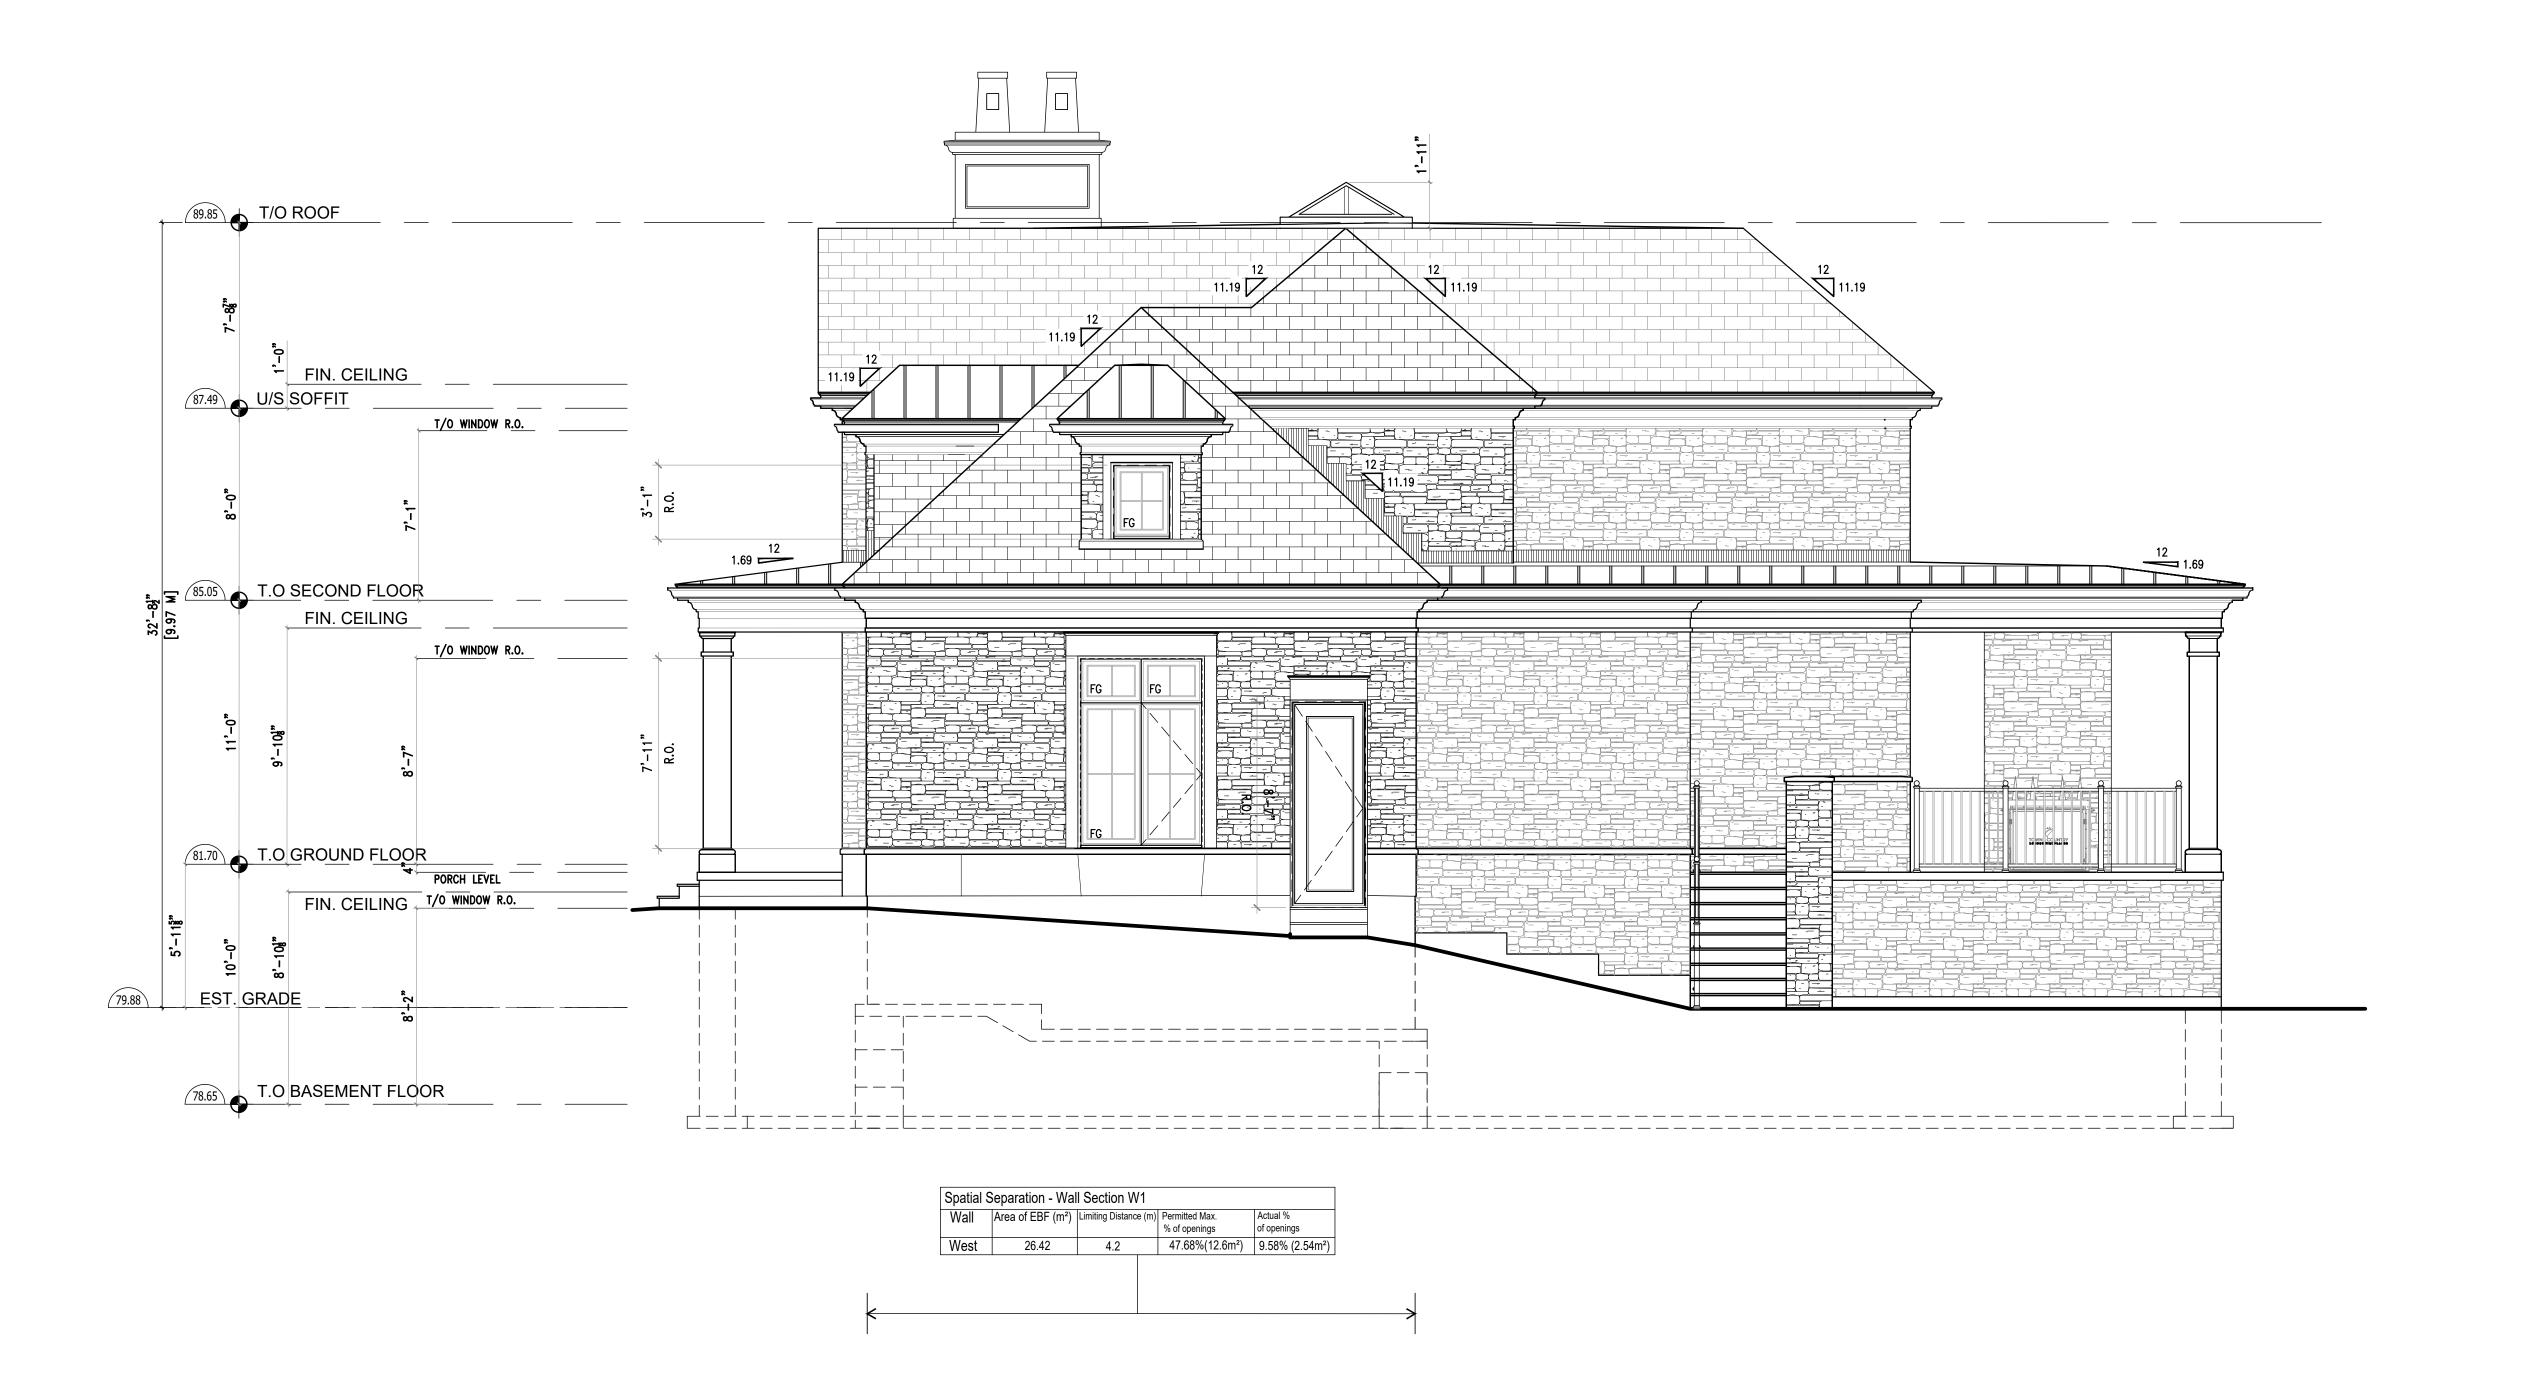
DRAWING TITLE:

EAST ELEVATION

21-3	19		Δ4 2
JOB NUMBER:		SHEET NUMBER	
DATE:	22-05-24	SCALE:	1/4"=1'
DRAWN:	E.O.		



Drawings must <u>NOT</u> be scaled. Contractor must check and verify all dimensions, specifications and drawings on site and report any discrepancies to the architect prior to proceeding with any of the work.



1 22.05.25 ISSUED FOR C OF A
REF. DATE: DESCRIPTION:
REVISIONS / ISSUANCE:



HICKS DESIGN STUDIO

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GREWAL SINGH RESIDENCE

RESIDENCE

ADDRESS: 1276 CAMBRIDGE DRIVE CITY: OAKVILLE, ON. DRAWING TITLE:

WEST ELEVATION

DRAWN:	E.O.		
DATE:	22-05-24	SCALE:	1/4"=
JOB NUMBER:		SHEET N	UMBE

21-319 **A**4



July 20th, 2022

Committee Of Adjustment, Town of Oakville 1225 Trafalgar Road, Oakville, ON

RE: Minor Variance Application, 1276 Cambridge Drive

#### Dear Committee:

We are the Architects working with the Owners on their new 2 storey dwelling at 1276 Cambridge Drive. We came before the Committee on July 19<sup>th</sup> to defer our application as we were advised prior to the Hearing that we required an additional variance for height. As such, we would like to request approval for 3 minor variances which are indicated below with their rationale. It should be noted that Planning supported the 2 variances applied for on July 19<sup>th</sup>. The height variance which we believe to be a technical variance is explained below and added to this deferral application.

#### Zoning Bylaw 2014-14, RL1-0 Variances Requested

#### Height of Dwelling-Permitted: 9.0m Proposed: 9.97m

The permitted height of the dwelling in this Zone is 9.0m. In this case, and further to that requirement, the definition for established grade is the average of the centre points of each lot line for **thru lots** which, according to our Grading Engineer was confirmed by the Town. By definition, a thru lot is a lot having separate limits on 2 separate roads and in this case, the property fronts onto Cambridge Drive and backs onto Lakeshore Road.

The grade at the rear of the property is substantially lower at the creek which lowers the established grade by nearly a metre. As a result of this, the measurement of the height from the established grade to the highest point of the structure requires a minor variance of 9.97m which we believe is a technical variance.

### Front yard setback- Min Permitted: 14.36m Proposed: 8.84m Max Permitted: 19.86 Proposed: 8.84

The Bylaw requires that a new house be located within a range of 1M in front or 5M behind an existing house. In this case we are not able to meet this required setback due to the lot shape and the lot depth which is impacted by a required rear yard setback from a top of bank feature and stream on Lakeshore Rd which is found at the back of this property.

The intent of the Bylaw is however to maintain some consistency in the front yard setbacks on established streets and in fact the proposed house does match the setback of the houses on the street





and thus our proposed location certainly meets the intent of the Bylaw and the character of the neighbourhood.

Floor to Lot Ratio-Permitted: 29% Proposed: 29.83%

The Bylaw permits a residential floor to lot ratio of 29%. In this case we are building a modest house on the site and we have taken care to create a front and side elevation that has lower roof lines and porch roof lines but within the objectives of the architectural style of the house the height of the roof over the garage is higher than 6.0 M so the area of the entire garage has to be added to the gross floor area of the home, which takes us over the permitted FAR on this lot.

In fact, the floor area of the house for the main and second floor without the area added above the garage is 3958 sq ft and this represents a FAR ratio of 26.46%, well below the permitted.

We believe the design of the house certainly complies with the infill guidelines for residential areas and the façade has been articulated appropriately and the increase in floor area to lot ratio is in fact a technical variance. We meet lot coverage, side yards, and other bylaw requirements and therefore we feel these are reasonable variances.

Thank you for your consideration.

William R. Hicks B.E.S., B.Arch., MRAIC. OAA

**HDS** | Hicks Design Studio Inc.

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