

KEY LOCATION - AERIAL

	ARCHITECTURAL SHEET LIS	ST	
Sheet Number	Sheet Name	Sheet Issue Date	Revision Number
01	CoverSheet v1	2021-07-22	01
02	ConstructionNotes_v1	2021-07-22	01
03	AreaOfWork_v1	2021-07-22	01
04	GeneralNotes_v1	2021-07-22	01
05	PartialSitePlan v1	2021-07-22	01
06	ProposedGroundFloorPlan v1	2021-07-22	01
07	ProposedSection_ProposedUniversalWashroom_v1	2021-07-22	01
08	UniversalWashroomDetails_v1	2021-07-22	01
09	LifeAndSafetyPlan v1	2021-07-22	01

Grand total: 9


0	AA MATRIX														
	FIRM NAME: <u>QBS ARCHITECTS INC.</u> 1670 BAYVIEW AVENUE, SUITE 401 <u>TORONTO, ON</u> <u>M4G 3C2</u>									ARCHITECTS Z					
	CERTIFICATE OF PRAC	CTICE NUMBER: !	<u>5235</u>											<sup>6963</sup>	munning
	NAME OF PROJECT: PROPOSED INTERIOR LOCATION: 71 SPEERS ROAD, UN		THE GRO	UND FLO	<u>OR</u>									The architect noted a responsible contro design activities. Th number is the arc	l with respect to e architect's seal
<u>No.</u>	ONTARIO'S BUILDING	CODE DATA MAT	RIX PART	9 AND P	ART 3									OBC REFERENCE References are to D noted [A] for Division Division C.	
1	PROJECT DESCRIPTIC	DN:							<u>NEW</u>			<u> </u>	<u>RT 11</u>	PART 3	X PART 9
					HANGI	E OF US	<u>E</u>		ADDIT		1	<u>11.1 T</u>	<u>0 11.4</u>	<u>2.1.1.[A]</u>	<u>2.1.1.[A]</u> <u>9.10.1.3</u>
2	MAJOR OCCUPANCY(	S): G	ROUP D	_										<u>3.1.2.1.(1)</u>	<u>9.10.2</u>
3	BUILDING AREA (UNIT	-7) (m²):		EXISTIN	IG: 42.	30	NE	EW: 42.30						<u>1.4.1.2.[A]</u>	<u>1.4.1.2.[A]</u>
4	GROSS AREA (UNIT-7)	) (m²):		EXISTIN	IG: 42.	30	NE	EW: 42.30						<u>1.4.1.2.[A]</u>	<u>1.4.1.2.[A]</u>
<u>5</u>	NUMBER OF STOREYS	S A	BOVE GR	ADE: 1	В	ELOW G	RAD	Ξ: 0						<u>1.4.1.2.[A] &amp; 3.2.1.1.</u>	1.4.1.2.[A] & 9.10.4
<u>6</u>	NUMBER OF STREET/F	FIRE FIGHTER AC	CCESS:	1										3.2.2.10 & 3.2.5	<u>9.10.20</u>
7	BUILDING CLASSIFICA	TION:												3.2.2.2083	<u>9.10.2</u>
<u>8</u>	SPRINKLER SYSTEM F	PROPOSED:					EN	ITIRE BUILDI	NG					3.2.2.2083	<u>9.10.8.2</u>
	SELECTED COMPARTMENTS     SELECTED FLOOR AREAS     BASEMENT ONLY     IN LIEU OF ROOF     RATING						DF ROOF	<u>3.2.1.5</u> <u>3.2.2.17</u> INDEX	<u>INDEX</u>						
9								3.2.9	N/A						
10	FIRE ALARM REQUIRE											NO		3.2.4	<u>9.10.18</u>
11	WATER SERVICE/SUP		E:				-	S (MUNICIPA	L)		$\square$	NO		3.2.5.7	N/A
12	HIGH BUILDING:			_			] YE					NO		3.2.6	N/A
13	CONSTRUCTION REST		NON-CON	IBUSTIBL	E			MBUSTIBLE	REQUIF	RED	$\overline{\square}$	BOTH		3.2.2.2083	<u>9.10.6</u>
	ACTUAL CONSTRUCTI		PERMITTI NON-CON		E	X	i	MBUSTIBLE			H	BOTH			
14	MEZZANINE(S) AREA (		/A											3.2.1.1.(3)-(8)	<u>9.10.4.1</u>
15	OCCUPANT LOAD BAS		m²/PERSC	ON		X		SIGN OF BU	ILDING					3.1.17	9.9.1.3
	BASEMENT:		CCUPANO			<u> </u>	-		SONS						<u> </u>
	1st FLOOR:	0	CCUPANO	CY D			LC	DAD 5 PERS	ONS						
	2nd FLOOR:	0	CCUPANO	CY			LC	DAD_PERSC	NS						
	3rd FLOOR:	0	CCUPANO	CY			LC	DAD PER	SONS						
	ROOF:	0	CCUPANO	CY _			LC	DAD PER	<u>SONS</u>						
<u>16</u>	BARRIER-FREE DESIG	<u>IN</u>	$\times$	<u>YES</u>	N	<u>0 (EX</u>	PLAIN	I) BUILDING I	S A HO	USE (E	XEM	<u>PT)</u>		<u>3.8</u>	<u>9.5.2</u>
<u>17</u>	HAZARDOUS SUBSTA	NCES		YES 2	× <u>n</u>	0								<u>3.3.1.2. &amp; 3.3.1.19</u>	<u>9.10.1.3(4)</u>
<u>18</u>	REQUIRED FIRE	HORIZON	TAL ASSE	MBLIES F		,		LISTED D	DESIGN	No. OF	R DES	CRIPTION	l <u>(SG-2)</u>	3.2.2.2083	<u>9.10.8</u>
	RESISTANCE RATING (FRR)	FLOORS				HOURS								<u>3.2.1.4</u>	<u>9.10.9</u>
		ROOF				HOURS								1	
		MEZZANINE			N/.	A HOUR	<u>s</u>								
			SUPPOR	TING MEN				LISTED D	DESIGN	No. OF	R DES	SCRIPTION	l <u>(SG-2)</u>		
		FLOORS				HOURS								4	
		ROOF				HOURS	_							4	
$\vdash$		MEZZANINE				A HOUR	<u>s</u>								
<u>19</u>	SPATIAL SEPERATION		1	RIOR W								I			
	WALL	AREA OF E.B.F.	<u>L.D.</u>		<u>L/H</u> OR	PERMI MAX %		% OF	- (HC	<u>RR</u> DURS)		ISTED SIGN OR	COMB. CONST.	COMB. CONST. NONC.	NON-COMB. CONSTR.
		<u>(sq.ft)</u> (sq.m)	<u>(ft)</u>	<u>(m)</u>	H/L	OPENI		OPENINGS (sq.m) %	<u>}</u>			CRIPTION		CLADDING	
	FRONT		. ,					. —					X		
	SIDE (SOUTH)	EXISTING TO F	REMAIN										$\overline{\times}$		
	REAR	EXISTING TO F	REMAIN										$\overline{\times}$		
	SIDE (NORTH)		-						-						

71 SF	PEERS RD.	No.	Description	Date	ARCHITECTS			
UNIT - 7,	OAKVILLE, ON							
					-			
		_				ARCHITECTS	PR	OJEC
STAGE	DRAWING NO.						DA	ΓE
BP	01	01		0004.07.00		TORONTO - CANADA	DR	AWN
		01	ISSUED FOR BUILDING PERMIT	2021-07-22	2	info@qbsarchitects.com	СН	ECKE

<u>+</u> ₹	<u>Permitted</u> <u>Max % of</u> <u>Openings</u>	PROPOSED <u>% OF</u> OPENINGS (sq.m) %	<u>FRR</u> (HOURS)	LISTED DESIGN OR DESCRIPTION	<u>COMB.</u> CONST.	<u>COMB.</u> CONST. NONC. CLADDING	<u>NON-COMB.</u> CONSTR.
					X		
					X		
					$\times$		
					X		


# CoverSheet\_v1


T NUMBER	210141	DRAWING	STATUS			
20	21-07-22	ISSUED FOR BUILDING PERMIT				
	JB					
D	SA	SCALE	12" = 1'-0"	REVISION	01	

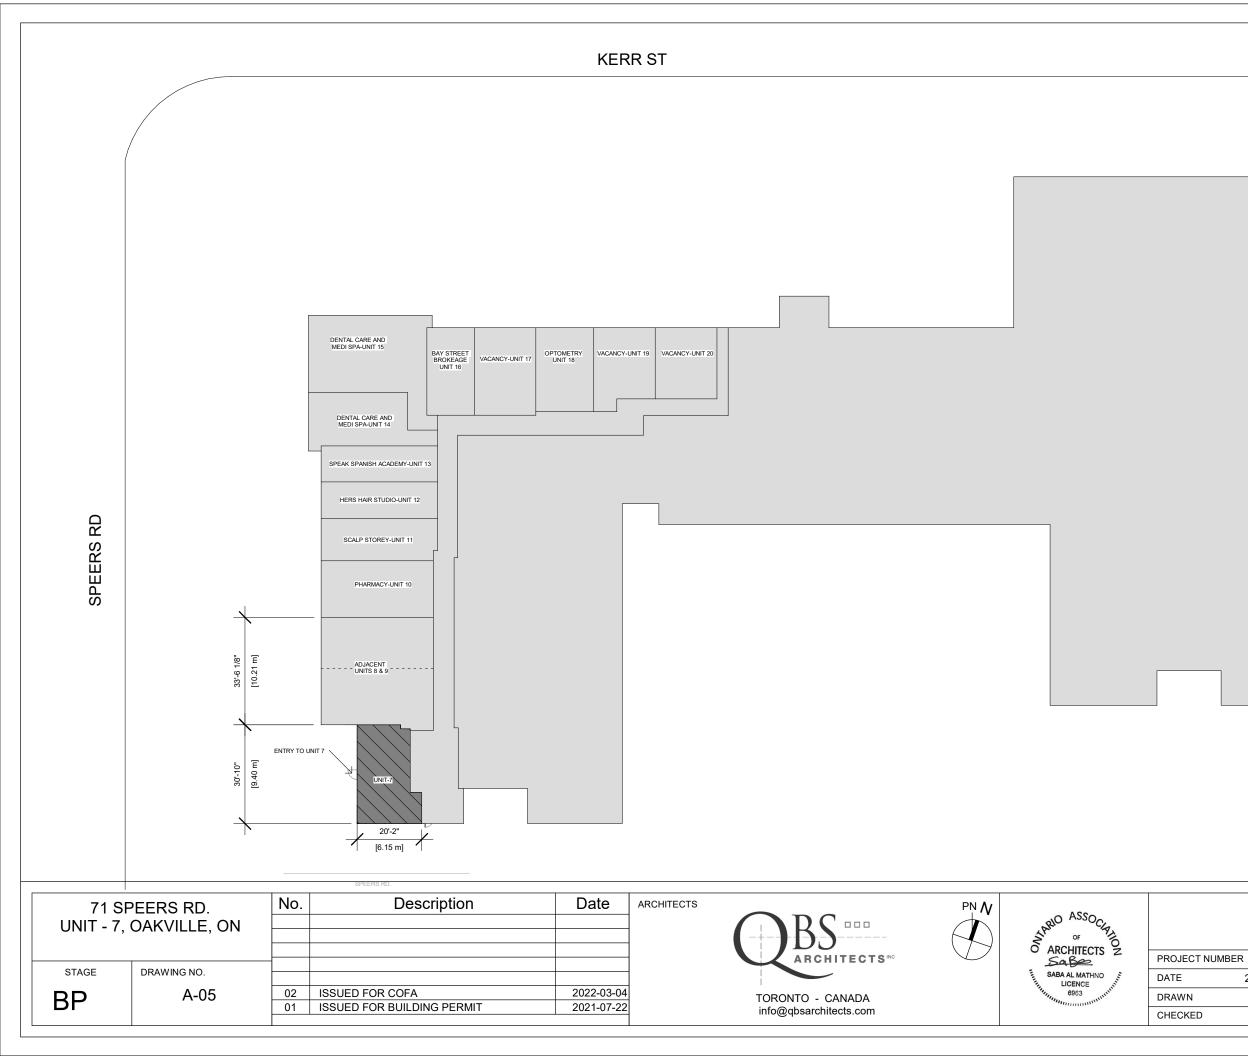

					80
R 210141	DRAWING	STATUS			4
2021-07-22	ISS	UED FOR	BUILDING	PERMIT	11
JB					0-80
SA	SCALE	1" = 30'-0"	REVISION	02	0-0-0
			•		<u> </u>

# Site Plan

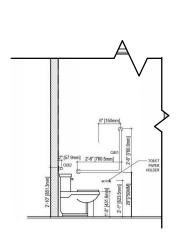

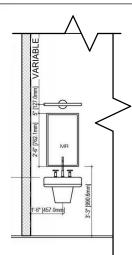

### \*3.8.3.12(2)

A UNIVERSAL WASHROOM SHALL HAVE,

(A) AN EMERGENCY CALL SYSTEM THAT CONSIST OF AUDIBLE AND VISUAL SIGNAL DEVICES INSIDE AND OUTSIDE OF THE WASHROOM THAT ARE ACTIVATED BY A CONTROL DEVICE INSIDE THE WASHROOM.

(B) AN EMERGENCY SIGN THAT CONTAINS THE WORDS IN THE EVENT OF AN EMERGENCY PUSH EMERGENCY BUTTON AND AUDIBLE AND VISUAL SIGNAL WILL ACTIVATE IN LETTERS AT LEAST 25 MM HIGH WITH A 5 MM STROKE AND THAT IS POSTED ABOVE THE EMERGENCY BUTTON

-PROVIDE WASHROOM VANITIES WITH HAND SINK. PROVIDE NEW PLUMBING FIXTURES. GRAB BARS.VANITIES.ACCESSORIES TRASH & MIRROR TO MEET BUILDING CODE REQUIREMENTS FOR WASHROOMS. PROVIDE WASHROOM SIGNS WITH ACCESSIBLE SYMBOL TO WASHROOM DOORS. VASHROOM DOURS. -ALL FIXTURES INSTALLATION TO COMPLY WITH O.B.C # 3.8.3.12. -ALL ACCESSORIES INSTALLATION HEIGHTS TO COMPLY WITH O.B.C # 3.8.3.11 AND ACCESSIBILITY AMENDMENTS ONTARIO REGULATION. 368/13 EFFECTIVE JANUARY 1.2015. -FOR BARRIER FREE WASHROOM PROVIDE PUSH\_BOTTOM WITH. POWEP OPEPATED DOOP POWER OPERATED DOOR.

OBC 3.8.3.12. UNIVERSAL WASHROOM MUST BE PROVIDED WITH: -A LIGHTING CONTROLLED BY MOTION SENSOR: AN EMERGENCY CALL SYSTEM: -AN EMERGENCY SIGN STATING IN THE EVENT OF AN EMERGENCY PUSH BUTTON, AUDIBLE AND VISUAL SIGN BE ACTIVATED.

## UNIVERSAL WASHROOM SECTIONS

### $\langle 1 \rangle$ BARRIER FREE W.C.

- SHALL BE EQUIPED WITH A SEAT LOCATED NOT LESS THAN 430MM AND NOT MORE THAN 485MM ABOVE THE FINISHED FLOOR -BE EQUIPPED WITH HAND OPERATED FLUSHING CONTROLS THAT ARE EASILY ACCESSIBLE TO A WHEELCHAIR USER OR TO BE AUTOMATICALLY OPERABLE

-BE EQUIPPED WITH A BACK SUPPORT WHERE THERE IS NO SEAT LID OR TANK

- NOT HAVE A SPRING-ACTIVATED SEAT - NOT HAVE A SPRING-ACTIVATED SEAT - HAND-OPERATED FLUSHING CONTROLS SHALL BE OPERABLE USING A CLOSED FIST AND WITH A FORCE OF NOT MORE THAN 22.2 N. -WATER CLOSET TO BE LOCATED SO THAT THE CENTRE LINE OF THE W.C. IS NOT LESS THAN 460MM AND NOT MORE THAN 480MM FROM ONE SIDE WALL AND A CLEAR TRANSFER SPACE AT LEAST 900MM WIDE AND 1500MM DEEP IS PROVIDED ON THE OTHER SIDE OF THE W.C.

### $\langle 2 \rangle \underline{\text{GRAB BAR}}$

- SHALL BE CONTINUOUS L-SHAPED WITH 750MM LONG HORIZONTAL AND VERTICAL COMPONENTS -BE WALL MOUNTED WITH THE HORIZONTAL COMPONENT 750MM ABOVE THE FINISHED FLOOR AND THE VERTICAL COMPONENT 150MM IN FRONT OF THE WATER CLOSET

### $\langle 3 \rangle$ BARRIER FREE DOOR

- MIN. 900MM CLEAR SPACE IN OPEN POSITION - CAPABLE OF BEING LOCKED FROM THE INSIDE AND RELEASED FROM THE OUTSIDE IN CASE OF EMERGENCY - CONTAIN A GRASPABLE LATCH-OPERATING MECHANISM LOCATED NOT

LESS THAN 900MM AND NOT MORE THAN 1000MM ABOVE THE FINISHED FLOOR

- IF IT IS AN OUTWARD SWING DOOR, A DOOR PULL NOT LESS THAN 140MM LONG LOCATED ON THE INSIDE SO THAT ITS MIDPOINT IS NOT LESS THAN 200MM AND NOT MORE THAN 300MM FROM THE LATCH SIDE OF THE DOOR AND NOT LESS THAN 900MM AND NOT MORE THAN 1100MM ABOVE THE FINISHED FLOOR

IF IT IS AN OUTWARD SWINGING DOOR, A DOOR CLOSER, SPRING HINGES OR GRAVITY HINGES, SO THAT THE DOOR CLOSES AUTOMATICALLY - BE EQUIPPED WITH A DOOR CLOSER AND POWER DOOR OPERATOR

## 4

-UNIVERSAL WASHROOM TO COMPLY WITH O.B.C. 3.8.3.12. - SHALL HAVE AN EMERGENCY CALL SYSTEM THAT CONSISTS OF AUDIBLE AND VISUAL SIGNAL DEVICES INSIDE AND OUTSIDE OF THE WASHROOM THAT ARE ACTIVATED BY A CONTROL DEVICE INSIDE THE

- HAVE AN EMERGENCY SIGN THAT CONTAINS THE WORDS IN THE EVENT OF AN EMERGENCY PUSH EMERGENCY BUTTON AND AUDIBLE AND VISUAL SIGNAL WILL ACTIVATE IN LETTERS AT LEAST 25 MM HIGH WITH A 5 MM STROKE AND THAT IS POSTED ABOVE THE EMERGENCY BUTTON - HAVE LIGHTING CONTROLLED BY A MOTION SENSOR CONFORMING TO SENTENCE 12.2.4.1.(2). -EQUIPPED WITH A COAT HOOK MOUNTED NOT MORE 1200mm ABOVE THE FINISHED FLOOR ON A SIDE WALL AND PROJECTING NOT MORE THAN 50mm FROM THE WALL AND A SHELF NOT MOUNTED MORE THAN 1100mm ABOVE THE FINISHED FLOOR.

### 5 BARRIER FREE LAVATORY

- TO BE LOCATED SO THAT THE DISTANCE BETWEEN THE CENTRE LINE OF THE LAVATORY AND THE SIDE WALL IS NOT LESS THAN 460MM - BE MOUNTED SO THAT THE TOP OF THE LAVATORY IS NOT MORE THAN 840MM ABOVE THE FINISHED FLOOR

- HAVE A CLEARANCE BENEATH THE LAVATORY NOT LESS THAN:

(i) 920MM WIDE (ii) 735MM HIGH AT THE FRONT EDGE

(II) 735MM HIGH AT 1HE FRONT EDGE (III) 355MM HIGH AT A POINT 205MM BACK FROM THE FRONT EDGE (III) 355MM HIGH FROM A POINT 300MM BACK FROM THE FRONT EDGE TO THE WALL - HAVE INSULATED PIPES WHERE THEY WOULD OTHERWISE PRESENT A BURN HAZARD OR HAVE WATER SUPPLY TEMPERATURE LIMITED TO A MAXIMUM OF 43 DEGRESS CELSIUS - BE COURPED WITH FAUCETS THAT HAVE LEVER TYPE HANDLES WITHOUT SPRING LOADING OR OPERATE AUTOMATICALLY AND THAT ARE LOCATED SO THAT THE DISTANCE FOR A DIVERTION OF THE OFFICE AUTOMATICALLY AND THAT ARE LOCATED SO THAT THE DISTANCE FROM THE CENTRE LINE OF THE FAUCET TO THE EDGE OF THE BASIN OR, WHERE THE BASIN IS MOUNTED IN A VANITY, TO THE FRONT EDGE OF THE VANITY, IS NOT MORE THAN 485MM

- HAVE A MINIMUM 1370MM DEEP FLOOR SPACE TO ALLOW FOR A FORWARD APPROACH, OF HAVE A MINIMUM OF 500MM CAN BE LOCATED UNDER THE LAVATORY
HAVE A SOAP DESPENSER THAT IS:
(i) LOCATED TO BE ACCESSIBLE TO PERSONS IN WHEELCHAIRS

(ii) LOCATED SO THAT THE DISPENSING HEIGHT IS NOT MORE THAN 1200MM ABOVE THE FINISH FLOOR

(iii) LOCATED NOT MORE THAN 610MM, MEASURE HORIZONTALLY, FROM THE EDGE OF THE LAVATORY

LAVATORY (w) OPERABLE WITH ONE HABD -HAVE A TOWEL DISPENSER OR OTHER HAND DRYING EQUIPMENT THAT IS (i) LOCATED TO BE ACCESSIBLE TO PERSONS IN WHEELCHAIRS (ii) LOCATED SO THAT THE DISPENSING HEIGHT IS NOT MORE THAN 1200MM ABOVE THE

FINISH FLOOR

(iii) OPERABLE WITH ONE HAND (iv) LOCATED NOT MORE THAN 610MM MEASURED HORIZONTALLY FROM THE EDGE OF THE ΙΔΊΛΔΤΟΒΥ

71 SF	PEERS RD.	No.	Description	Date	ARCHITECTS PN N	
UNIT - 7,	OAKVILLE, ON					
	1	_				PROJEC
STAGE	DRAWING NO.					DATE
BP	08			0004.07.00	TORONTO - CANADA	DRAWN
		01	ISSUED FOR BUILDING PERMIT	2021-07-22	info@qbsarchitects.com	CHECKE

WASHROOM ACCESSORIES	
DESCRIPTION	
AUTOMATIC AIR DRYER	AD
30" W X 36" H FRAMED MIRROR	MR
30" W X 30" H L-SHAPE ST. STEEL GRAB BAR W/ SAFETY GRIP	GB1
24" ST. STEEL GRAB BAR W/ SAFETY GRIP	GB2
RECESSED SANITARY NAPKIN DISPOSAL	ND
MULTI ROLL RECE. PAPER TOWEL DISPENSER	PT
WALL MOUNTED SOAP DISPENSER	SD
WATER BASED PAINT AS PER TENANT'S CHOICE	(PT-1)
PAPER TOWEL DISPENSOR/WASTE RECEPTACLE	TD
CERAMIC WALL TILE FINISH AS PER TENANT'S CHOICE	CT-1
B-211 (x 3) SURFACE MOUNTED HEAVY DUTY CLOTHES HOOK. MOUNTED 4'-0" A.F.F. ON SIDE WALL @ EVERY WASHROOM, AS SHOWN . TO COMPLY WITH O.B.C 3.8.3.8(1)(e)	ΗK

## UniversalWashroomDetails v1

T NUMBER	210141	DRAWING STATUS		
20	ISSUED FOR BUILDING PERMIT			
	JB			
D	SA	SCALE 3/16" = 1'-0"	REVISION	01



T NUMBER	210141	DRAWING STATUS			
20	21-07-22	ISSUED FOR BUILDING PERMIT			
	JB				
D	SA	SCALE As indicated	REVISION	01	