

Committee of Adjustment Town of Oakville

AGENDA

Date: November 13, 2024

Time: 7:00 pm

Location: Virtual Meeting

Live streaming video is available at <u>oakville.ca/live.html</u> or the Town's YouTube channel at youtube.com/user/townofoakvilleTV.


Making submissions to the Committee of Adjustment


To participate in the electronic hearing or to submit written correspondence regarding an application on the agenda, please email the Secretary-Treasurer at coarequests@oakville.ca, or call 905-845-6601 ext. 1829, by noon the day before the hearing date.

Pages 1. Reading of Preamble 2. Regrets 3. **Declarations of Pecuniary Interest** 4. Requests for Deferrals or Withdrawals of Applications 5. Consent Application(s) 6. Minor Variance Application(s) 3 - 11 6.1 CAV A/123/2024 - 324 Wendy Lane 12 - 19 6.2 CAV A/154/2024 - 92 Forsythe Street 20 - 30 6.3 CAV A/157/2024 - 1238 Donlea Crescent 31 - 74 6.4 CAV A/160/2024 - 14 Timber Lane 75 - 85 6.5 CAV A/161/2024 - 12 Rayne Avenue 86 - 106 6.6 CAV A/162/2024 - 262 King Street

6.7	CAV A/071/2024 - 221 Wedgewood Drive (Deferred from May 1, 2024)	107 - 168
6.8	CAV A/074/2024 - 1140 Invicta Drive (Deferred from May 15, 2024)	169 - 182
6.9	CAV A/079/2024 - 2092 Seabrook Drive (Deferred from October 2, 2024)	183 - 191

- 7. Confirmation of Minutes
- 8. Adjournment

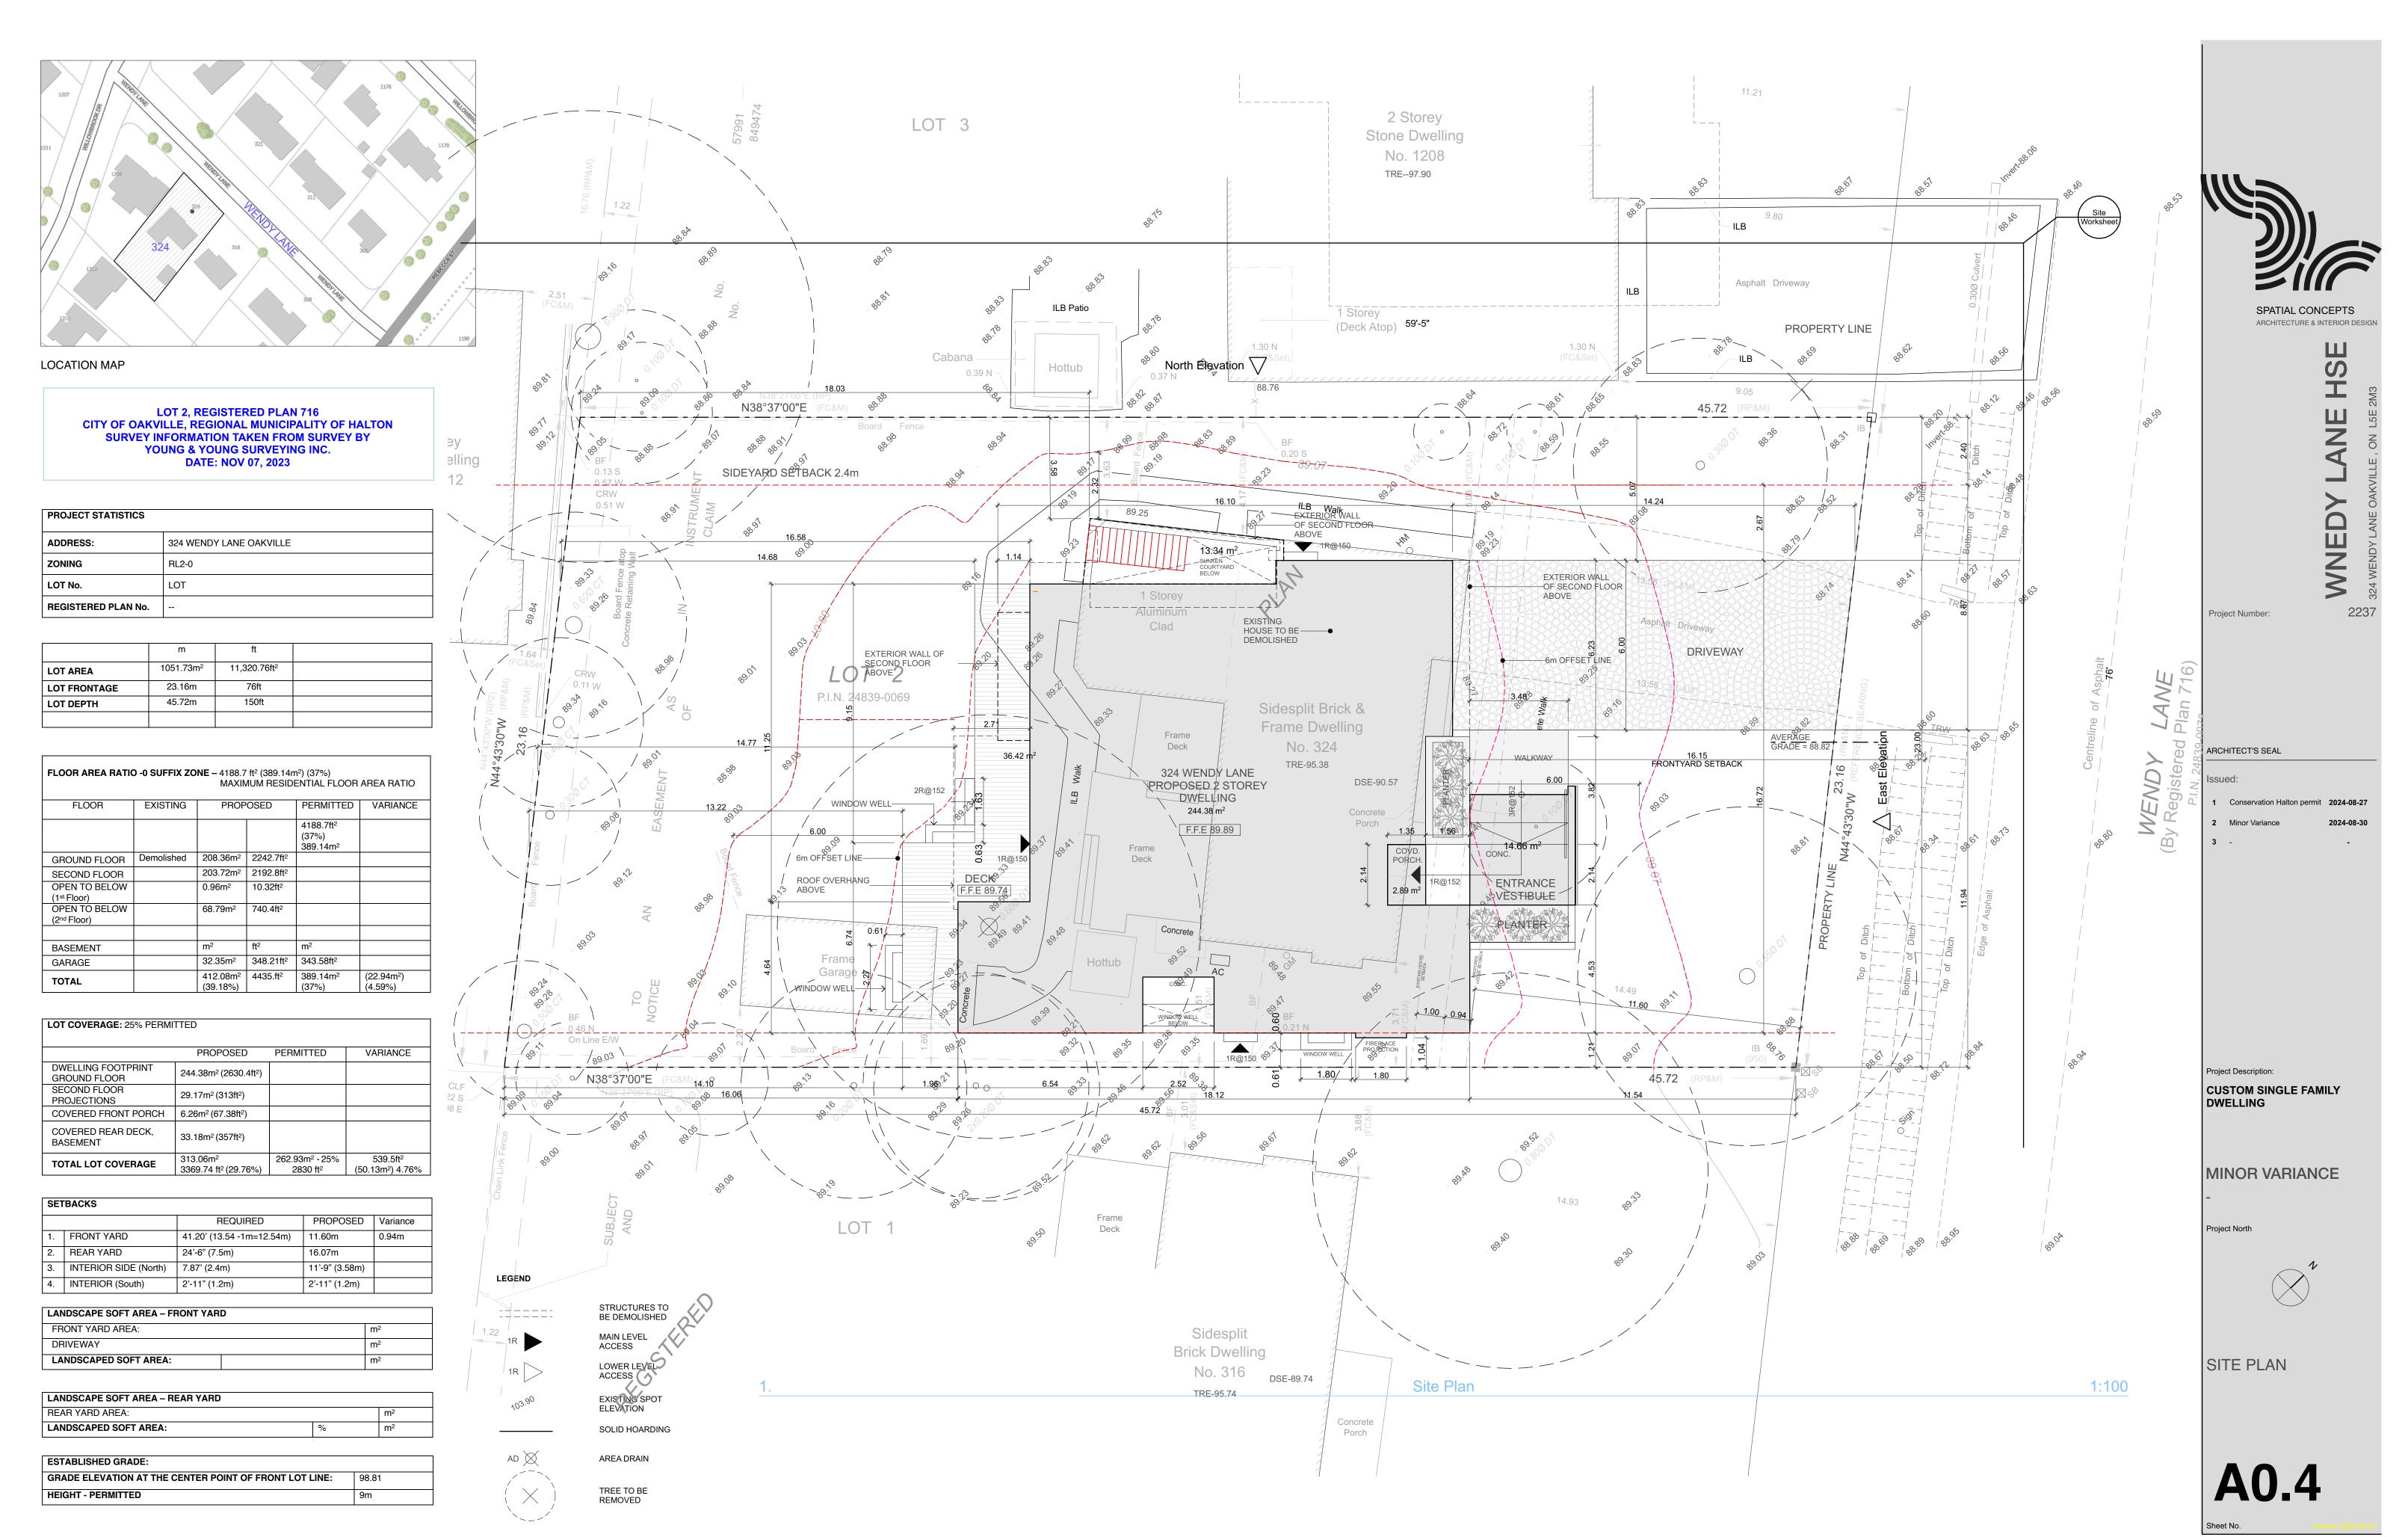

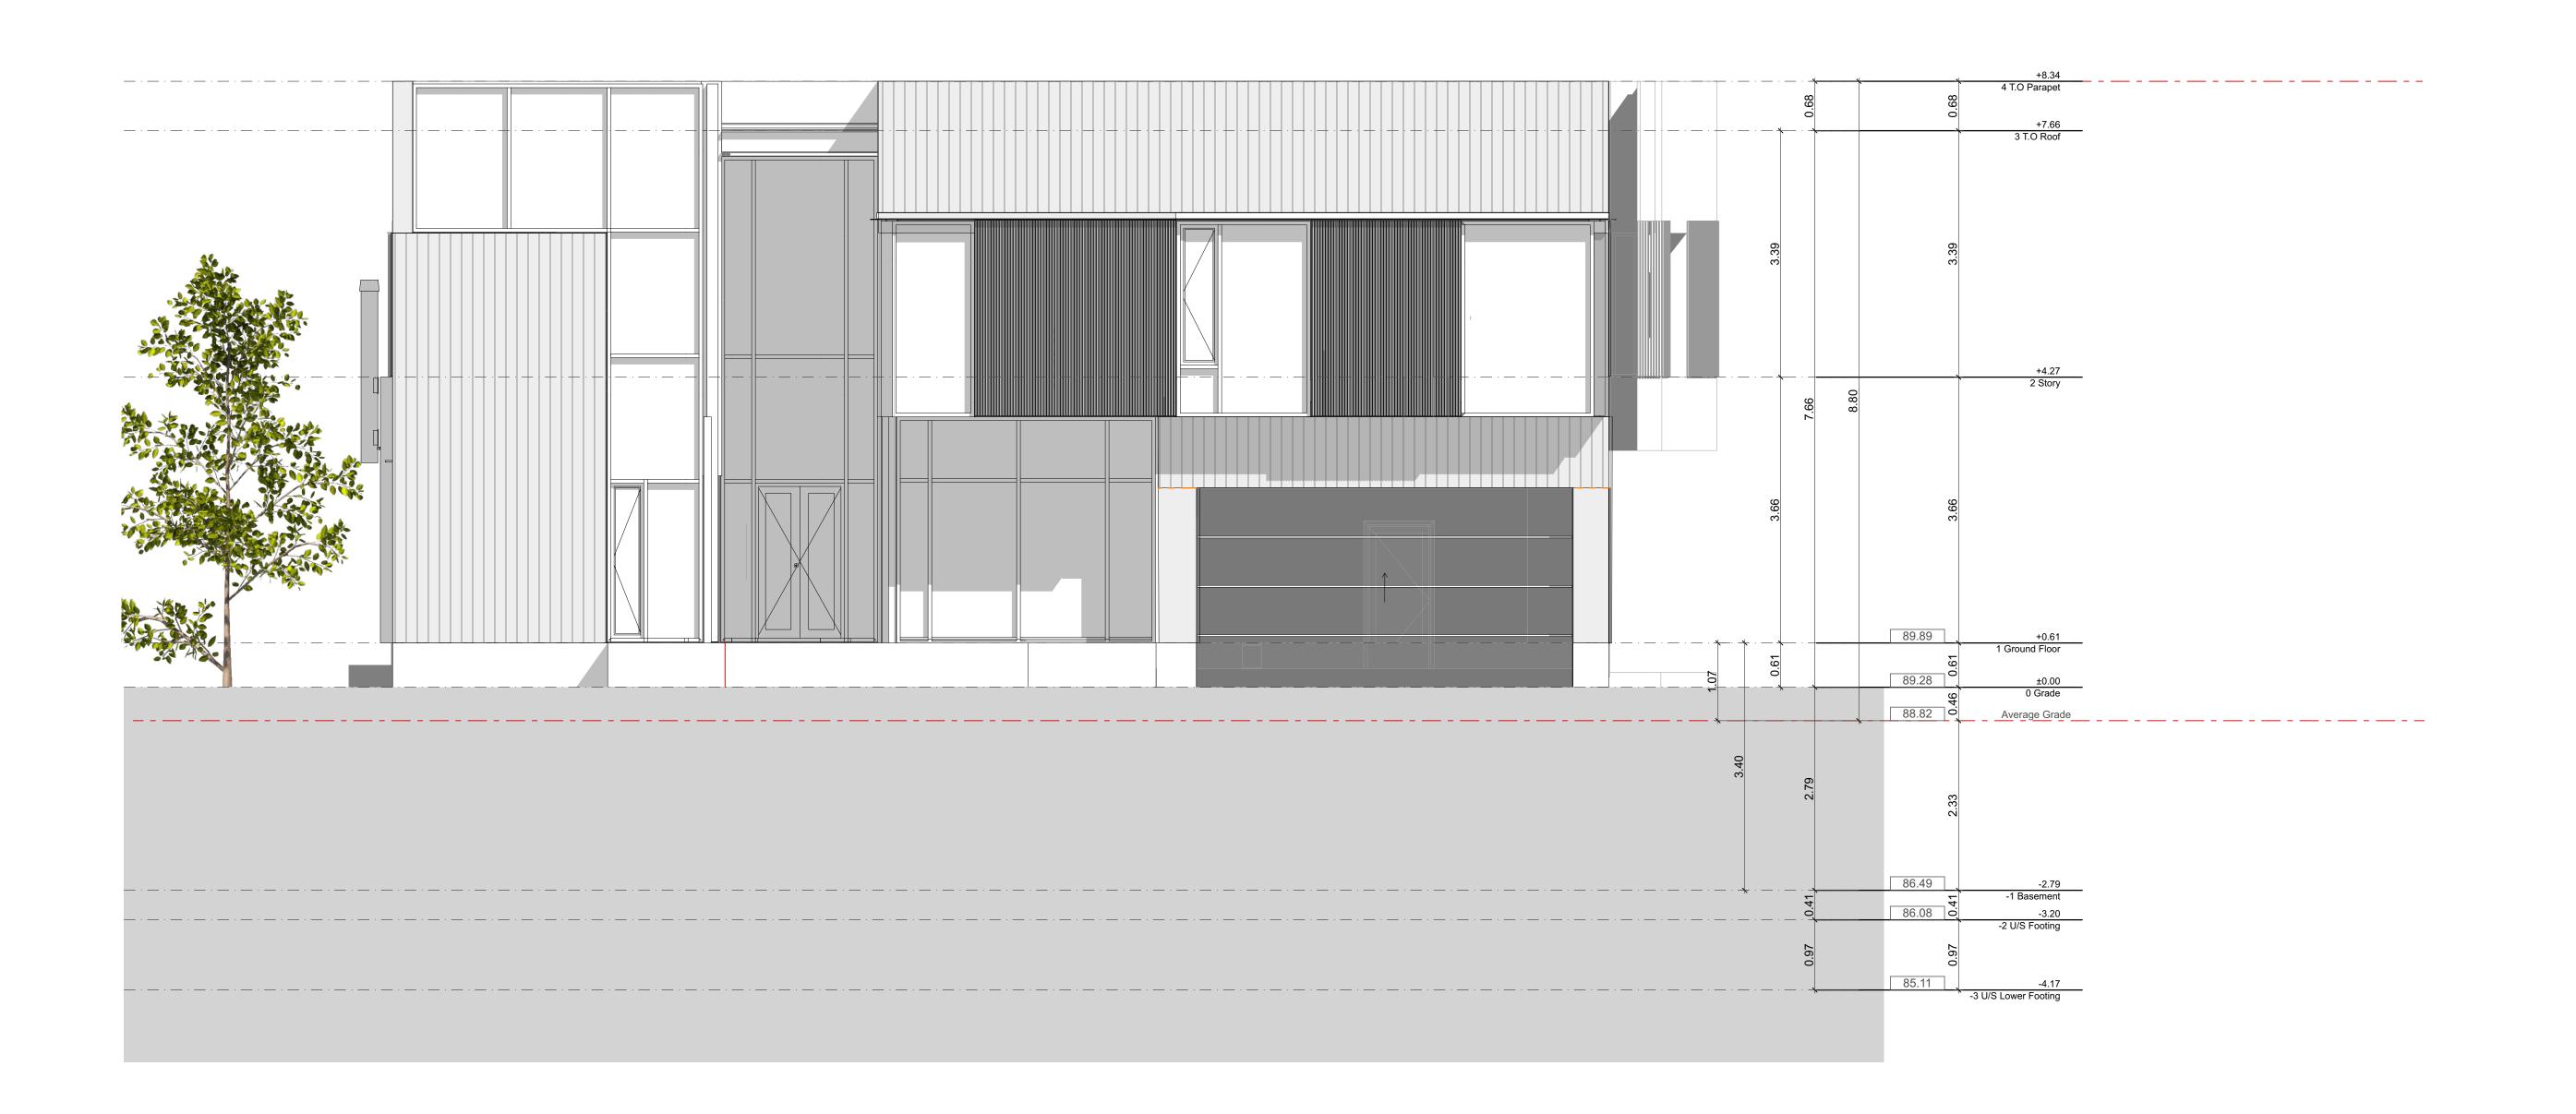



WNEDY LANE HSE
2823 WENDY LANE OAKVILLE, ON L5E 2M3

ject Number:

ARCHITECT'S SEAL

senay.

1 Conservation Halton permit 2024-08-27
2 Minor Variance 2024-08-30

Project Description:

CUSTOM SINGLE FAMILY

DWELLING


MINOR VARIANCE

Proje



E-02 EAST ELEVATION

A2.1

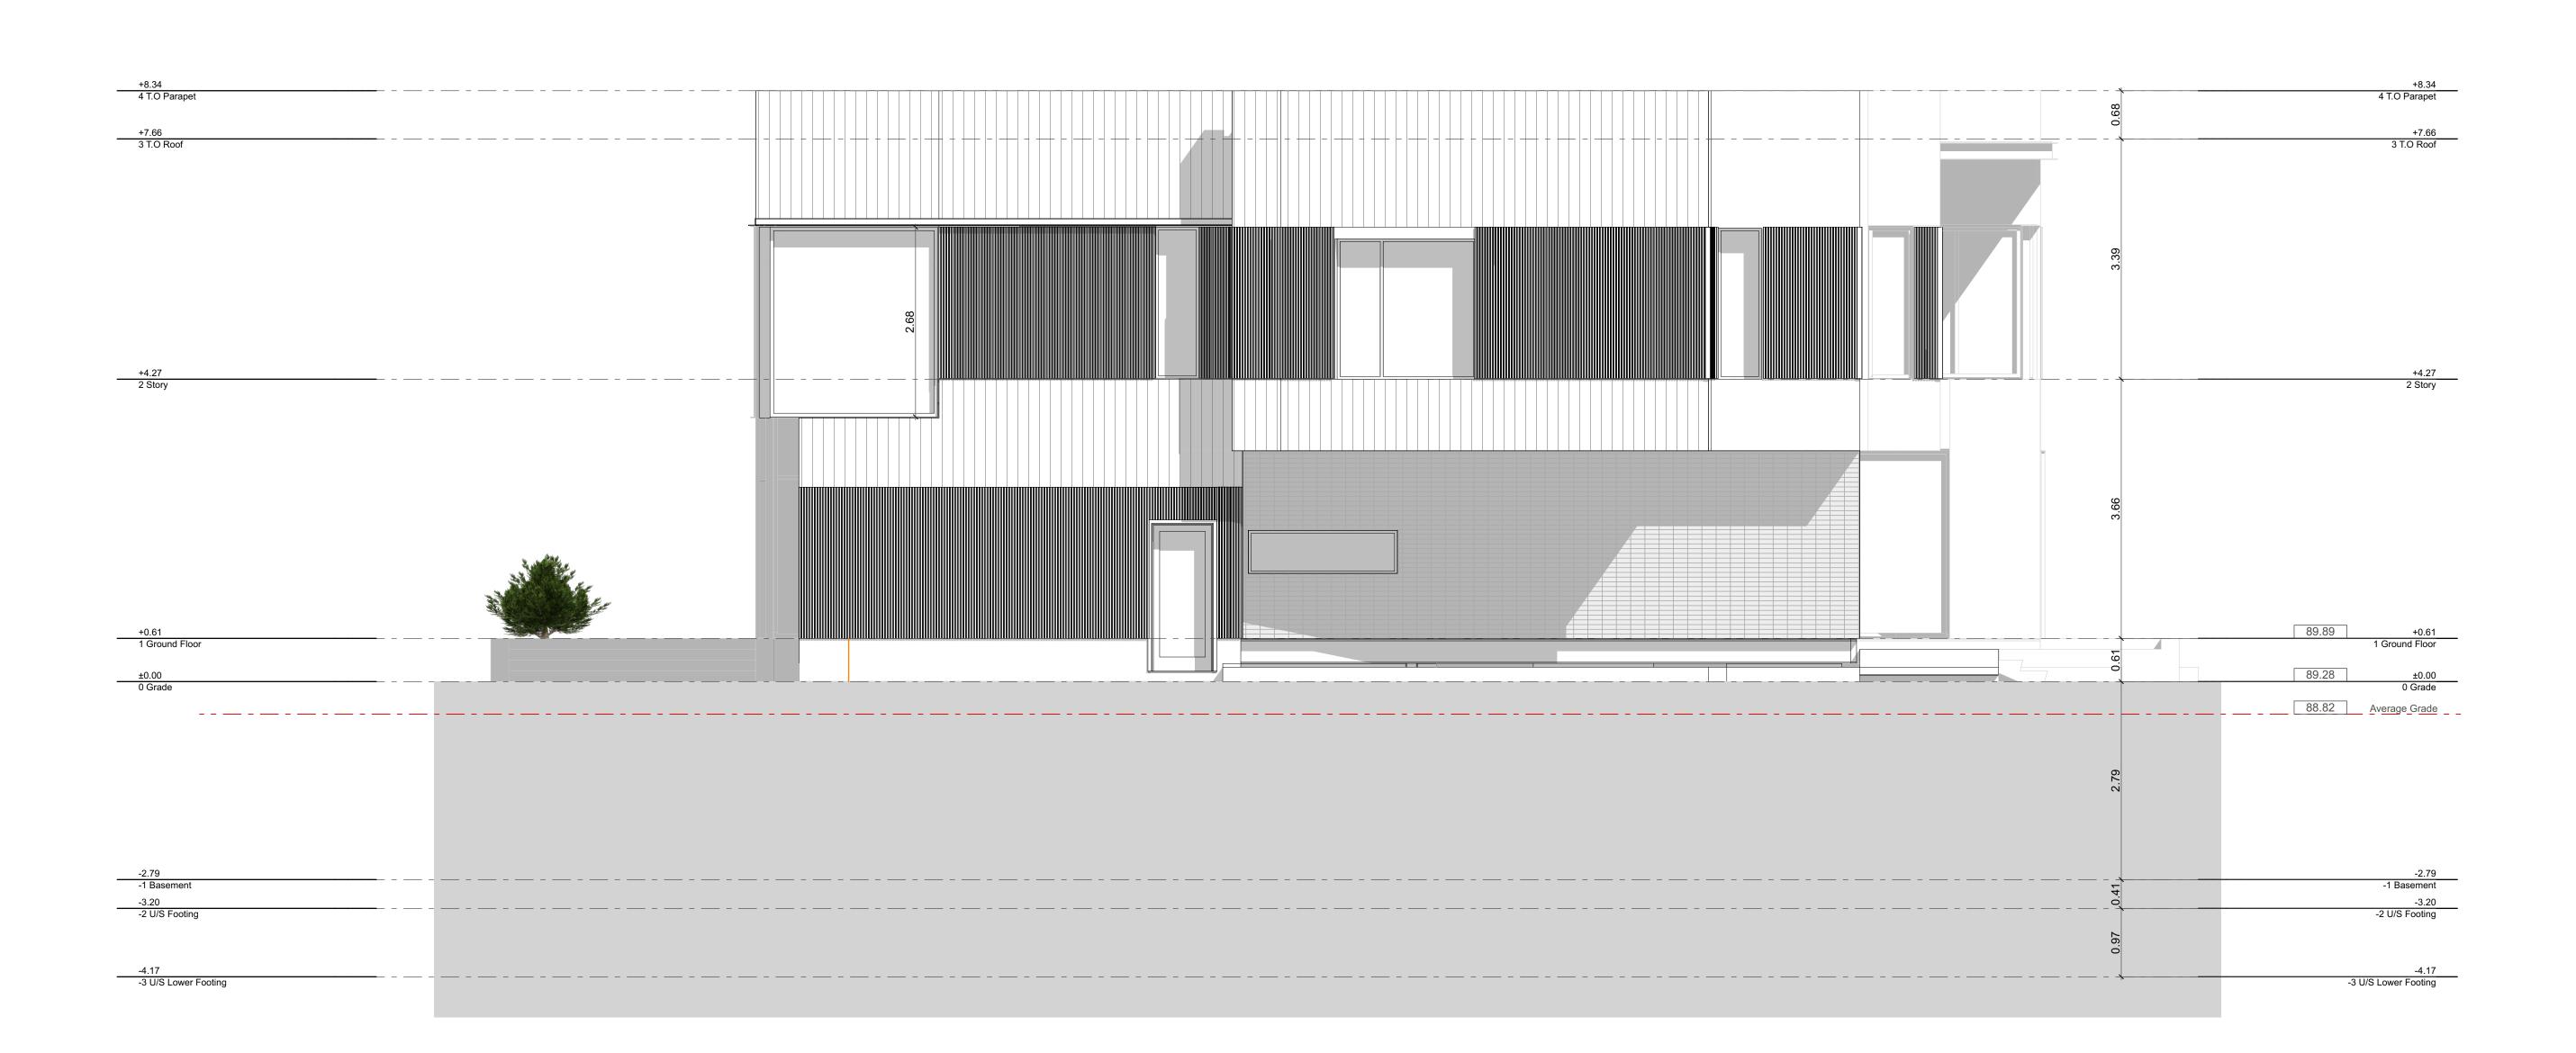



Project Description:


CUSTOM SINGLE FAMILY
DWELLING

MINOR VARIANCE

D. C. (N.


E-01 NORTH ELEVATION

A2.2

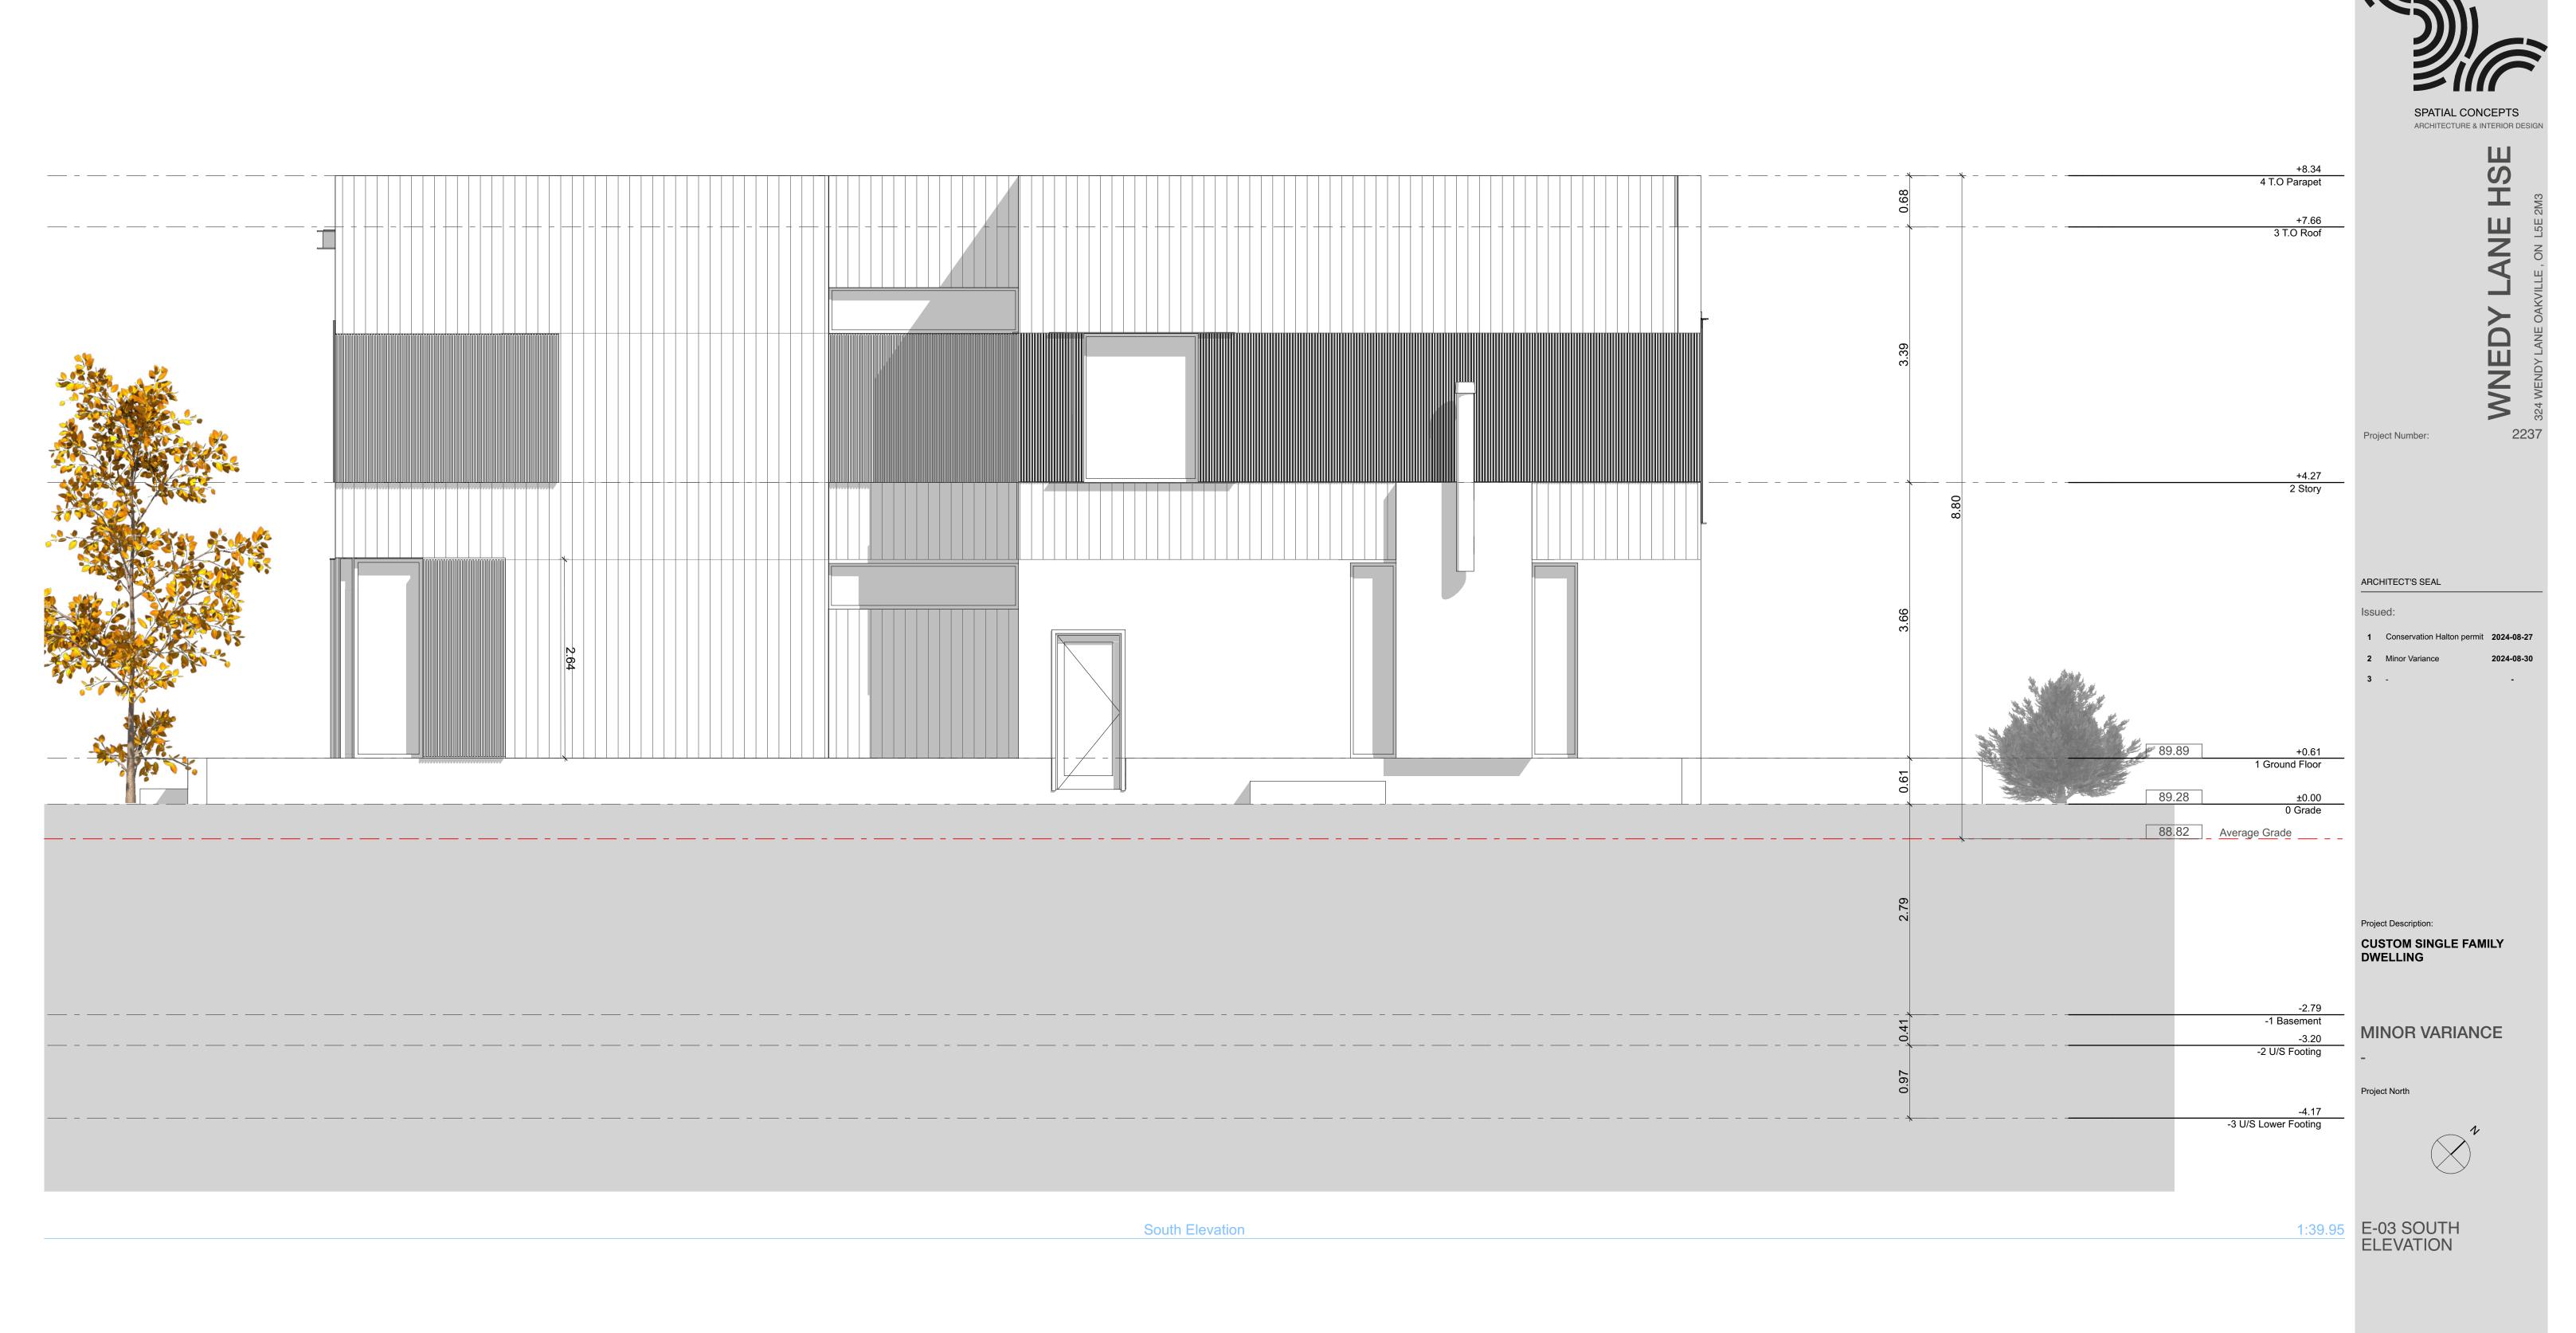



SPATIAL CONCEPTS
ARCHITECTURE & INTERIOR DESIGN ARCHITECT'S SEAL Project Description: CUSTOM SINGLE FAMILY DWELLING MINOR VARIANCE E-04 WEST ELEVATION

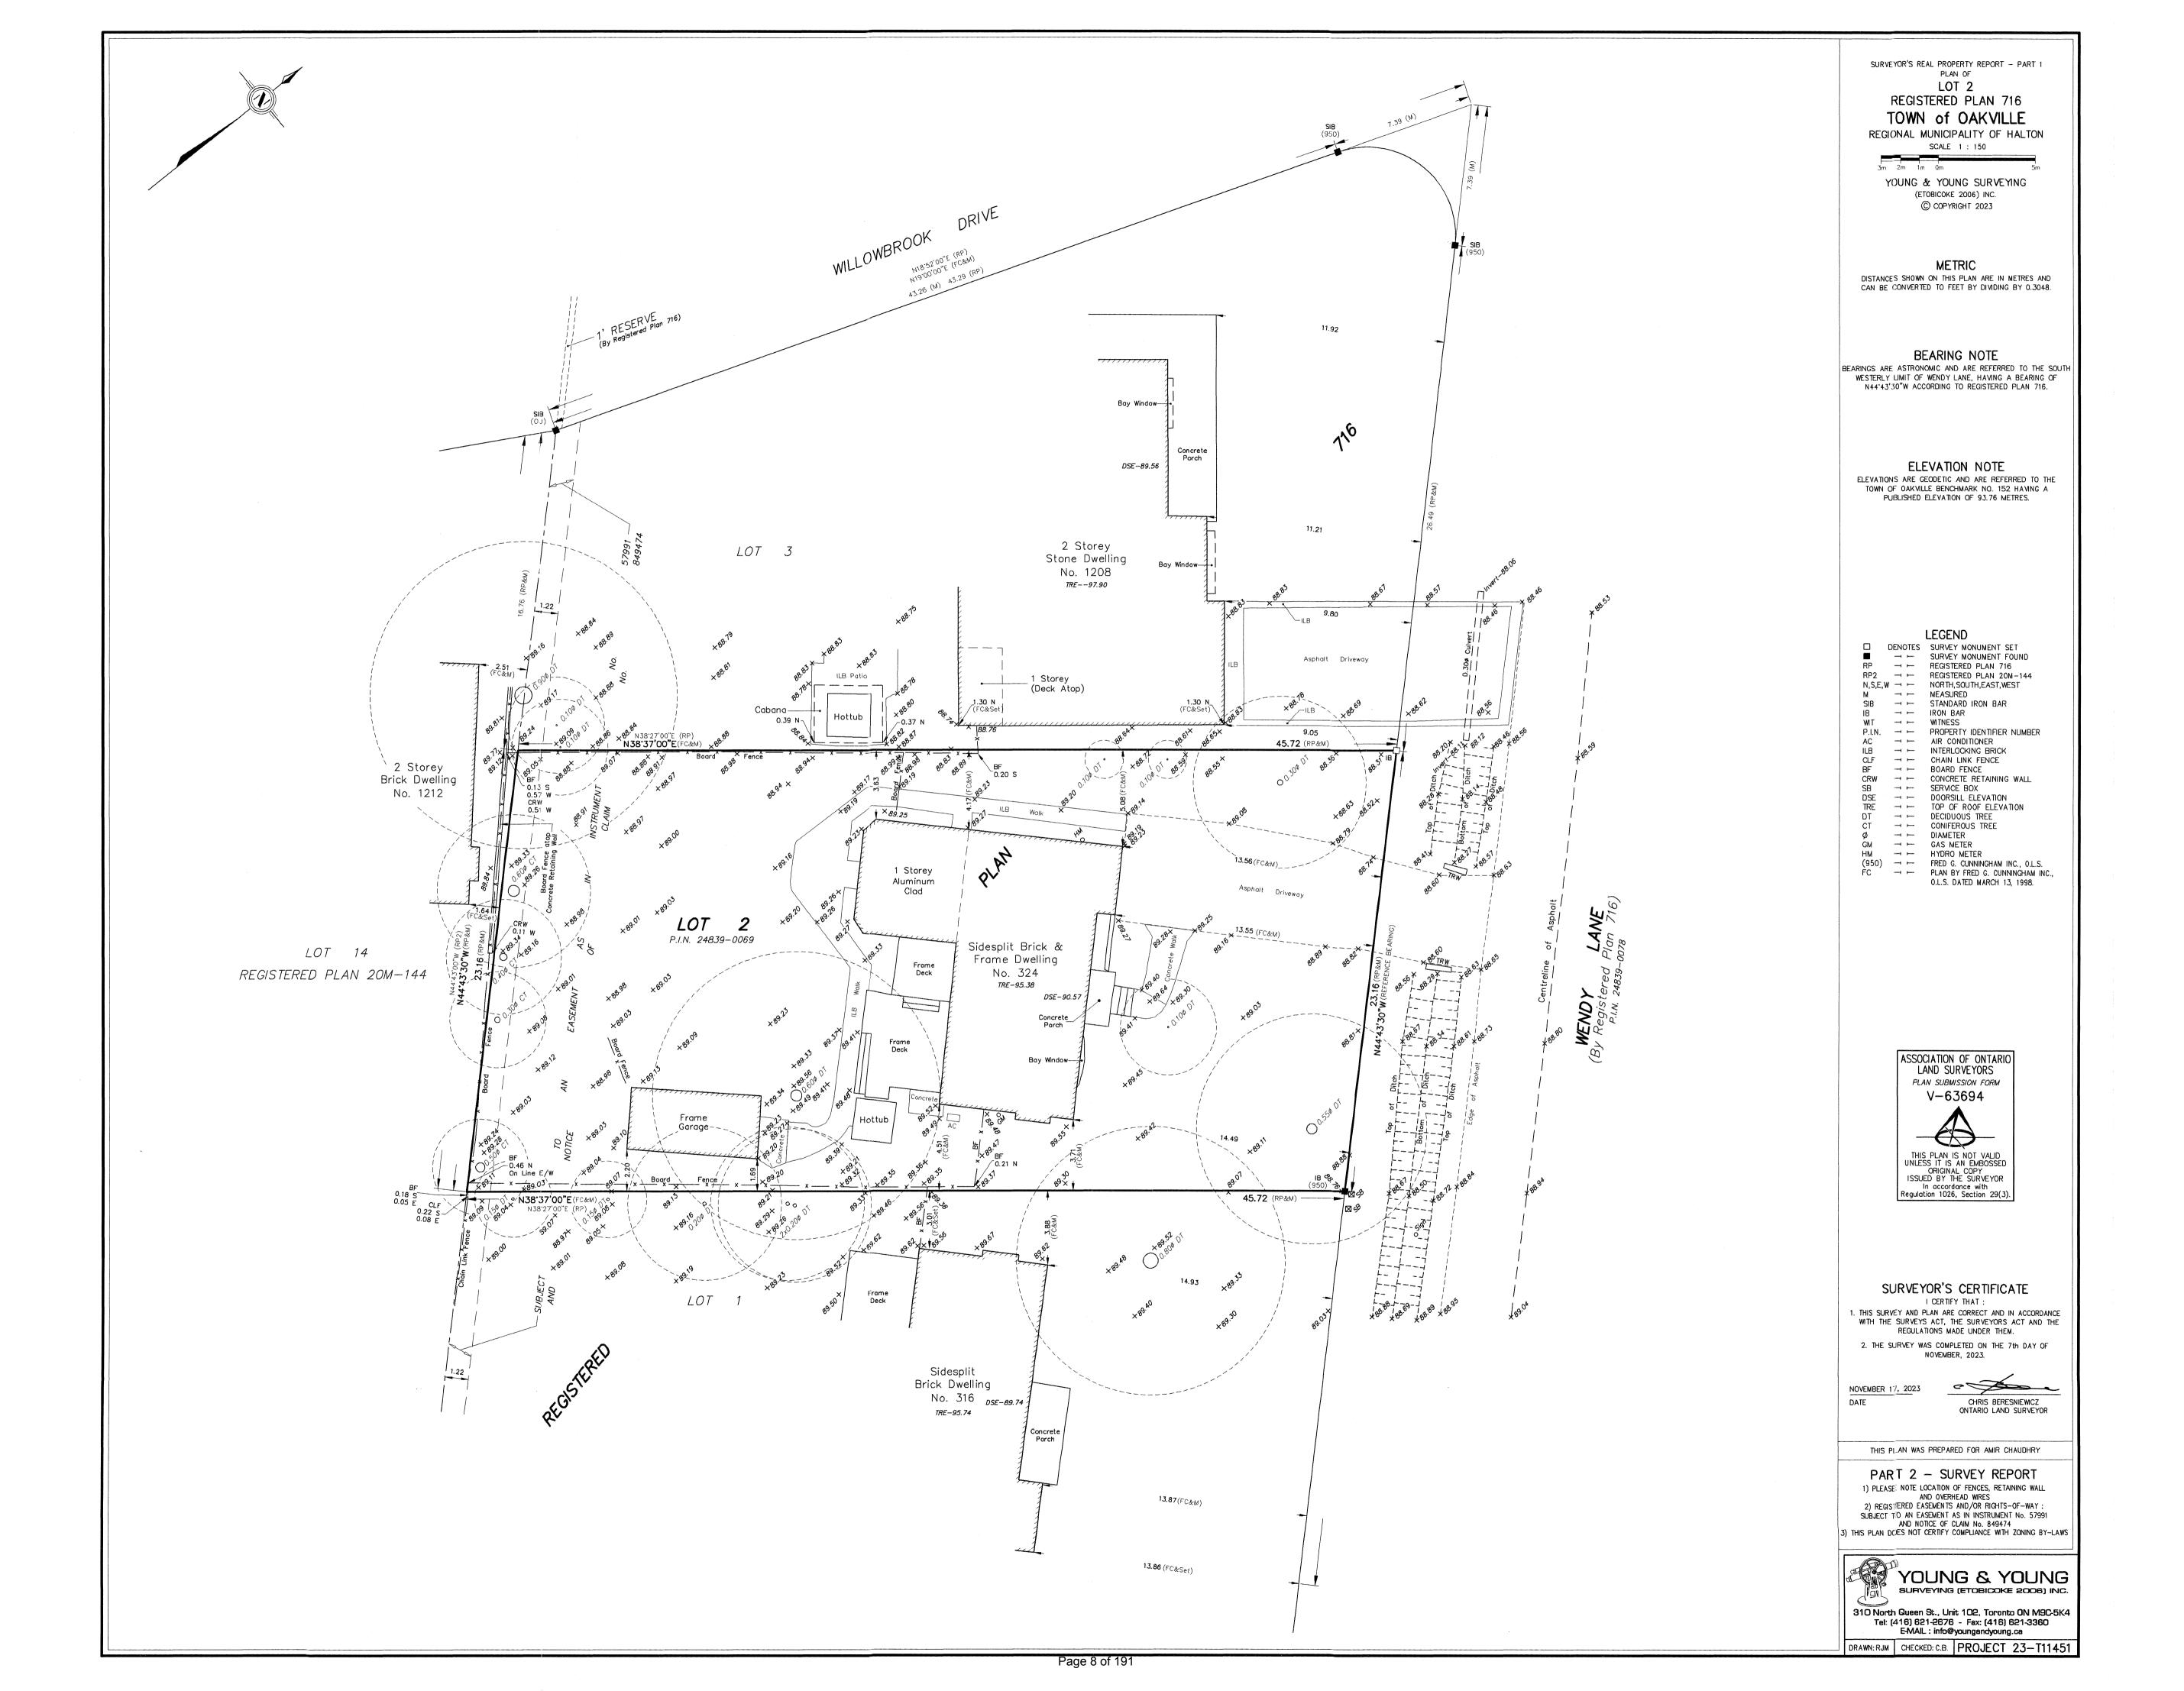

Notice of Public Hearing Committee of Adjustment Application



File # CAV A/123/2024

Electronic hearing:

By videoconference and live-streaming video on the Town of Oakville's Live Stream webpage at <u>oakville.ca</u> on November 13, 2024 at 7 p.m.

Why am I receiving this notice?

You are receiving this notice because the applicant noted below has submitted a minor variance application to the Town of Oakville. As stipulated by the *Planning Act*, notice must be provided to property owners within 60 metres (200 ft.) of the area to which the application applies. Further details of this application, including drawings, can be viewed online at <u>Agendas & Meetings</u> (oakville.ca).

Applicant and property information:

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Applicant / Owner	Authorized Agent	Subject Property
C. Latif	JONATHAN BENCZKOWSKI	324 Wendy Lane
S. Amir	SOL-ARCH 301 KEEWATIN AVE Toronto ON, CANADA M4P 2A4	PLAN 716 LOT 2

Zoning of Property: RL2-0, Residential

Variance Request:

Under Section 45(1) of the *Planning Act*, the applicant is requesting the Committee of Adjustment to authorize a minor variance to permit the construction of a two-storey detached dwelling on the subject property proposing the following variance(s) to Zoning By-law 2014-014:

No.	Current	Proposed
1	Table 6.4.1 The maximum residential floor area ratio for a detached dwelling on a lot with a lot area between 1,022.00 m² and 1,114.99 m² shall be 37%.	To increase the maximum residential floor area ratio to 39.18%.
2	Table 6.4.2 (Row RL2, Column 3) The maximum lot coverage shall be 25% where the detached dwelling is greater than 7.0 metres in height.	To increase the maximum lot coverage to 29.76%.
3	Section 6.4.3 (a) The minimum front yard on all lots shall be the yard legally existing on the effective date of this By-law less 1.0 metre. In this instance, the minimum front yard shall be 12.5 metres.	To reduce the minimum front yard to 11.60 metres.

How do I participate if I have comments or concerns?

Submit written correspondence

Although there are no third-party appeal rights, you are entitled to notice and may make written submissions before the application is considered by the Committee of Adjustment. You can send your written comments regarding the application by email (preferred) or regular mail to the Secretary-Treasurer noted below. Include your name, address and application number or address of the property in which you are providing comments. To allow all Committee of Adjustment members the opportunity to review and consider your comments, please provide your written submissions to be received no later than noon the day before the hearing date.

Please be advised that any written correspondence submitted to the Town of Oakville regarding this application will be made public pursuant to the *Planning Act* and *Municipal Freedom of Information and Protection Act*.

Participate in the electronic hearing by videoconference.

Pre-register as a delegation by contacting the Secretary-Treasurer noted below by email or telephone no later than noon the day before the hearing date. You are encouraged to pre-register as a delegation as soon as possible in order to facilitate an orderly registration process. Pre-registered delegates will be provided with access codes and instructions to enter the electronic hearing.

Watch the hearing:

If you do not wish to participate, but would like to follow along, the hearing will be publicly live-streamed on the Town of Oakville's Live Stream webpage at oakville.ca. The live-stream will begin just before 7 p.m.

More information:

Town departments and agency comments regarding this application will be available online at <u>Agendas & Meetings (oakville.ca)</u> by noon on the Friday before the hearing date.

Notice of decision:

If you wish to be notified of the decision for this application, you must make a written request by email or regular mail to the Secretary-Treasurer noted below. The written request must be received before noon the day before the hearing date. This will entitle you to be notified of any future Ontario Land Tribunal proceedings.

Contact information:


Jen Ulcar Secretary-Treasurer of Committee of Adjustment 1225 Trafalgar Road Oakville, ON L6H 0H3 Phone: 905-845-6601 ext. 1829

Email: coarequests@oakville.ca


Date mailed: October 29, 2024





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Notice of Public Hearing Committee of Adjustment Application

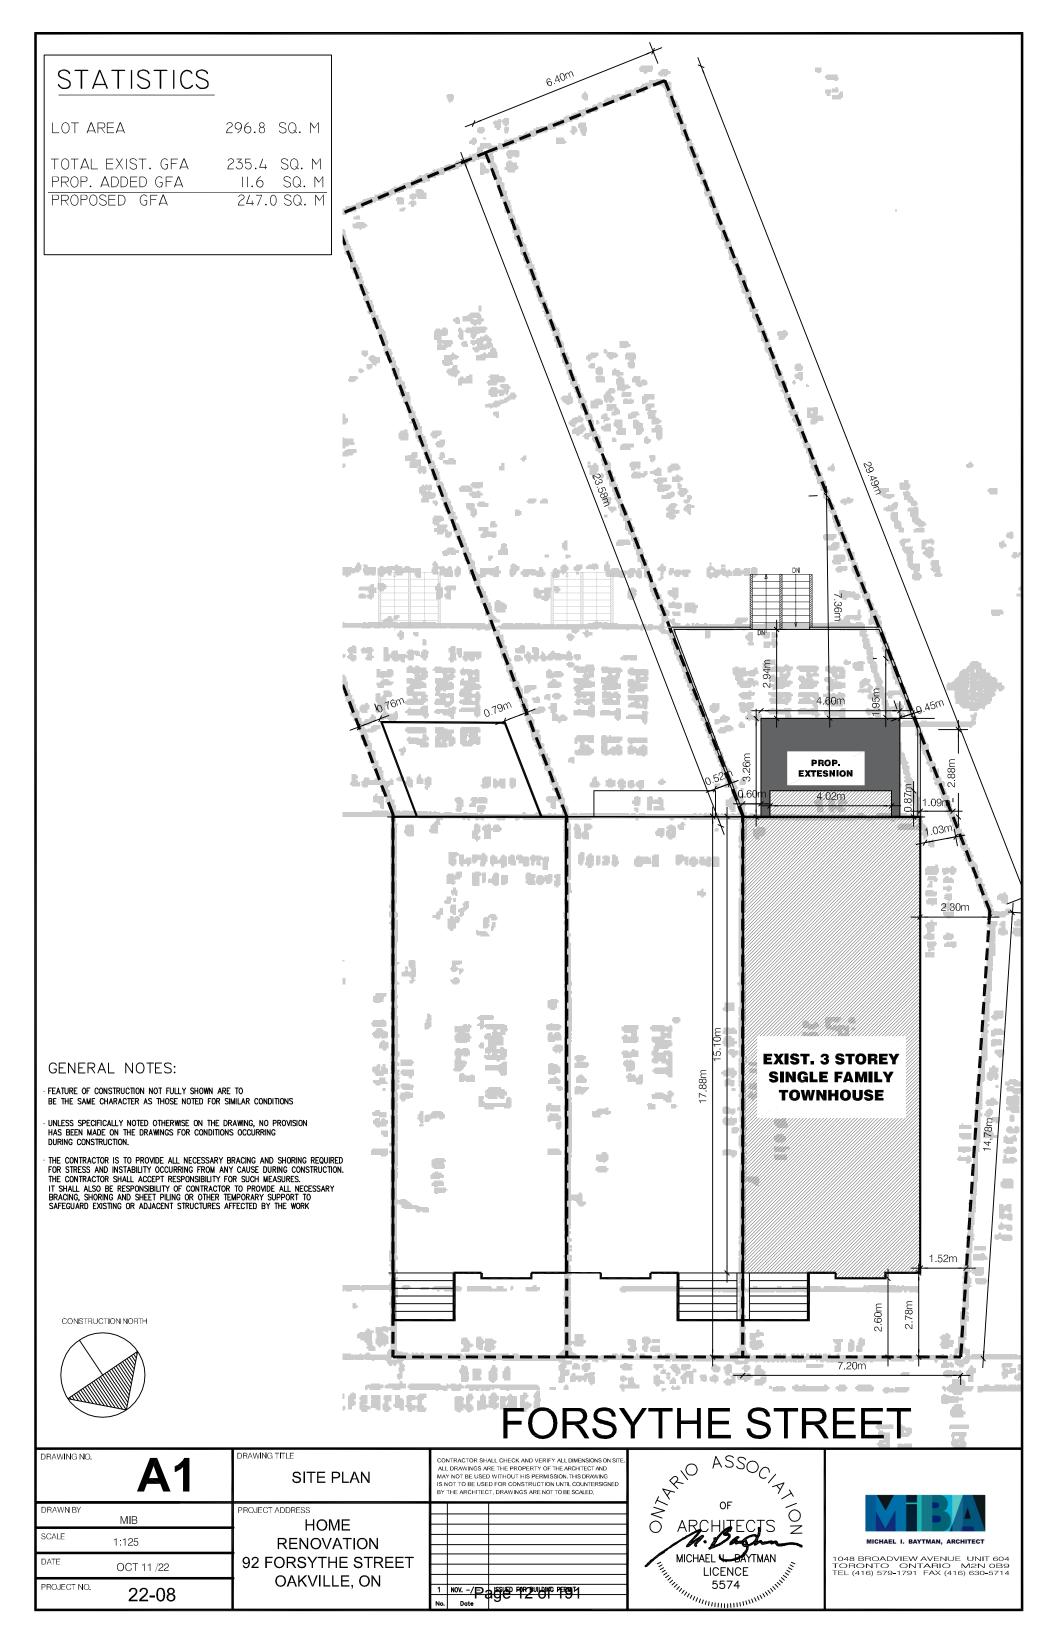

File # CAV A/154/2024

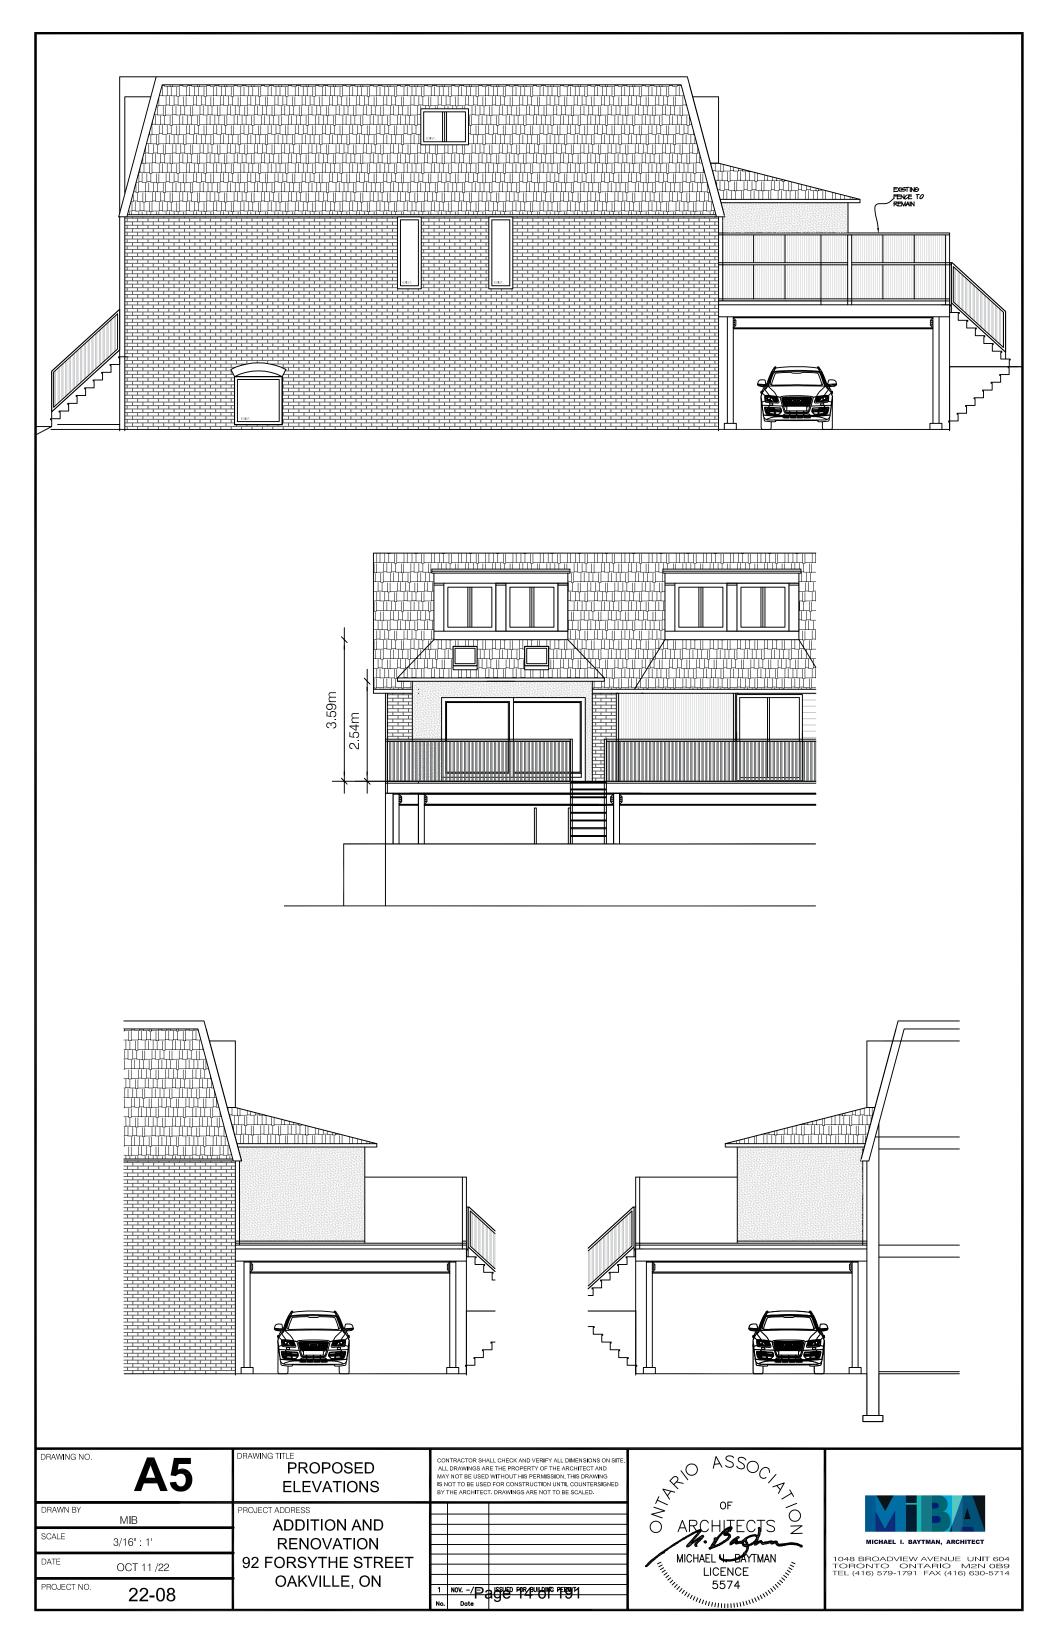Electronic hearing:

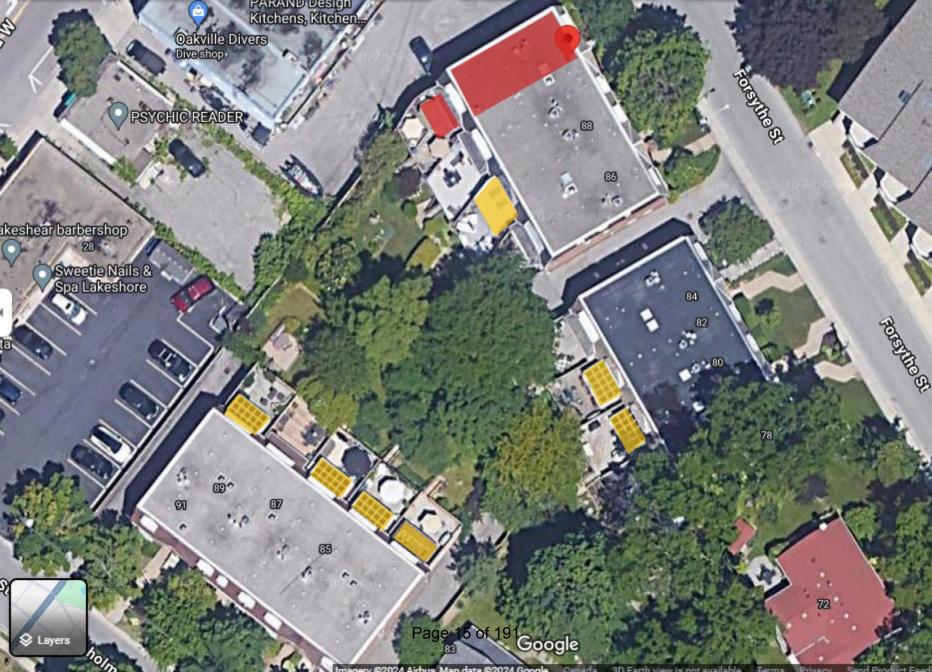By videoconference and live-streaming video on the Town of Oakville's Live Stream webpage at <u>oakville.ca</u> on November 13, 2024 at 7 p.m.

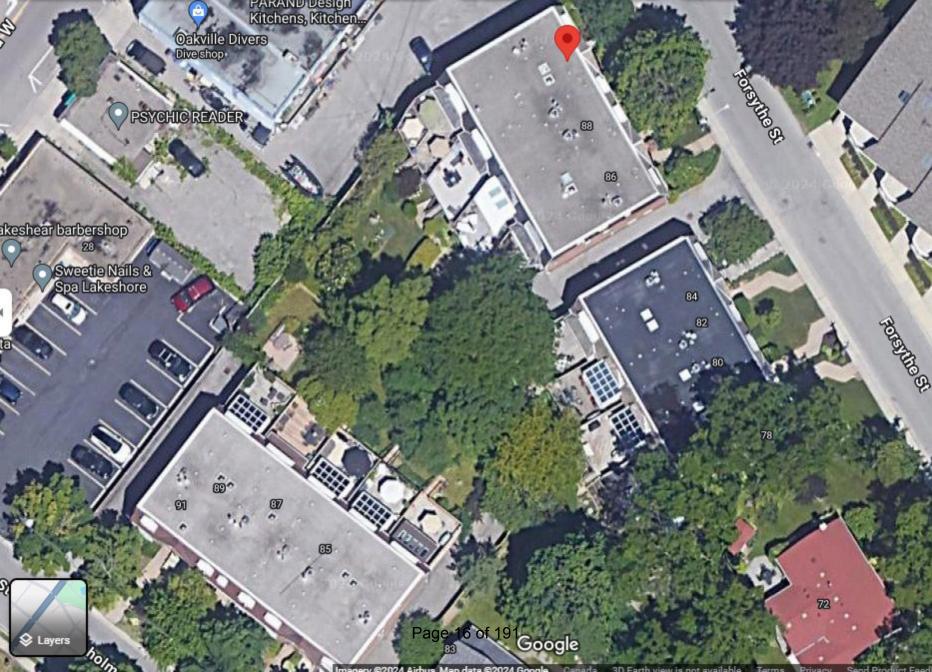Why am I receiving this notice?

You are receiving this notice because the applicant noted below has submitted a minor variance application to the Town of Oakville. As stipulated by the *Planning Act*, notice must be provided to property owners within 60 metres (200 ft.) of the area to which the application applies. Further details of this application, including drawings, can be viewed online at <u>Agendas & Meetings</u> (oakville.ca).

Applicant and property information:

Applicant / Owner	Authorized Agent	Subject Property
L. Forsyth	Michael Baytman	92 Forsythe St
	Michael I. Baytman, Architect	PLAN 1 BLK 67 PT LOTS 7,8 RP
	1048 Broadview Ave Unit 604	20R8497 PARTS 8,9,10,11
	Toronto ON, CANADA M4K 2B8	

Zoning of property: RM1 sp 148, Residential

Variance request:

Under Section 45(1) of the *Planning Act*, the applicant is requesting the Committee of Adjustment to authorize a minor variance to permit a one storey rear addition to the existing dwelling on the subject property proposing the following variances to Zoning By-law 2014-014:

No.	Current	Proposed
1	Table 6.3.8 (Row 5, Column RM1)	To reduce the minimum northerly interior side yard
	The minimum interior side yard shall be 1.2 m.	to 0.45 m.

How do I participate if I have comments or concerns?

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Contact information:

Jennifer Ulcar
Secretary-Treasurer of Committee of Adjustment
1225 Trafalgar Road
Oakville, ON L6H 0H3
Phone: 005, 245, 6601 out, 1820

Phone: 905-845-6601 ext. 1829 Email: coarequests@oakville.ca

Date mailed: October 29, 2024



ROSS DEFINA CONSULTING

Town of Oakville 1225 Trafalgar Road Oakville, On. L6H 0H3

Attention: Secretary-Treasurer, Committee of Adjustment, Town of Oakville.

Re: Minor Variance Applications Cover Letter for: 1238 Donlea Crescent, Oakville, On. L6J 1V7

Ross Defina Consulting has been retained by the owner to apply for minor variance relief to construct a new two storey single-family home.

The subject property is located at 1238 Donlea Crescent, Oakville, On. L6J 1V7. Lot #15, Registered Plan 805. The property possess a frontage of 35.52m along Donlea Crescent and comprise an area of 1,392.9 m2. The land is currently designated 'Single Family Residential (Group C)' and zoned Residential RL1-0, with an existing single storey detached dwelling and garage currently located on the lands.

The purpose of the subject applications is to obtain relief for a total of five (4) minor variances as follows.

- 1. 6.4.1, Floor Space Index: allowable 29%, proposed 32.6%.
- 2. 5.8.6(c), Garage Floor Aera: allowable 56.0m2, proposed 60.84m2.
- 3. 6.3.1, Front Yard Setback: min. allowable 10.5m, proposed 7.6m.
- 4. 6.3.1, Rear Yard Setback: min. allowable 10.5m, existing (to remain) 9.7m.

We are proposing a Floor Space Index increase of 3.6%, spread over two floors which we believe to be a reasonable and fair request and minor in nature.

The garage floor area increase is needed to help meet the owner's needs for both indoor parking and general storage. Conservation Halton (CH) will not allow any structures to be constructed within the 6.0m setback from the floodplain and stable top of bank. This limits the owner's options to reasonable storage facilities. The garage is the logical best.

Effort was made to best integrate the desired building design with the irregular geometry of the front property lot line and the rear yard natural features. The building design beginning at the west side has been stepped back toward the east side such that adjacent neighbours are unobstructed. The front yard setbacks related to the minor variance relief are specific to encroaching building corners of the proposed dwelling. Further the proposed building plains are non-monolithic and the building height street facing is transitioned through the use of projections and recesses. This serves to create a sense of openness and removes any visible concerns typically associated with reduced front yard setbacks. These protruding corners vary in setback 7.6m at the easterly open entry porch corner, 8.6m at the south east living room corner and 9.8m at the garage east corner. Stepped building face segments with small portion encroachments into the front yard setback further supported by non-monolithic forms keep the majority of the building setback 10.5m posing no visual disruption nor negative impact to the balance within the neighbourhood.

The rear yard setback is based on keeping a significant portion of the existing basement foundation walls. The rear yard setback of 9.7m is an existing condition to remain and not a new proposal. Conservation Halton (CH) suggested that maintaining the existing foundation to help facilitate outdoor living space may have potential to meet CH policies. They recommended that we proceed with a minor variance application prior to applying for a CH permit.

The proposed development will not impact natural areas or features, provides orderly development to adjacent land uses, increases opportunities for more sustainably and energy efficiency, and is appropriately located within a greater residential area.


Economic development and competitiveness are priorities as reflected in all levels of Planning policy. The proposed development will result in increased choice and better housing standards. The subject applications aim to stimulate and revitalize through the integration of new residential development addressing changing social and demographic market demands.


The proposal is in keeping with orderly development of safe and healthy communities, supports the protection of natural areas and features, is in an appropriate location of growth and development, promotes the efficient use and conservation of energy and water and represents the bases for good design practices.

The justification for the approval of the minor variance application is based on the conformity with the goals and objectives of the Planning Act, Provincial Policy Statement, Provincial Growth Plan and the Town of Oakville Official Plan.


Respectfully submitted,
ROSS DEFINA CONSULTING


Page	22	of	191
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Notice of Public Hearing Committee of Adjustment Application

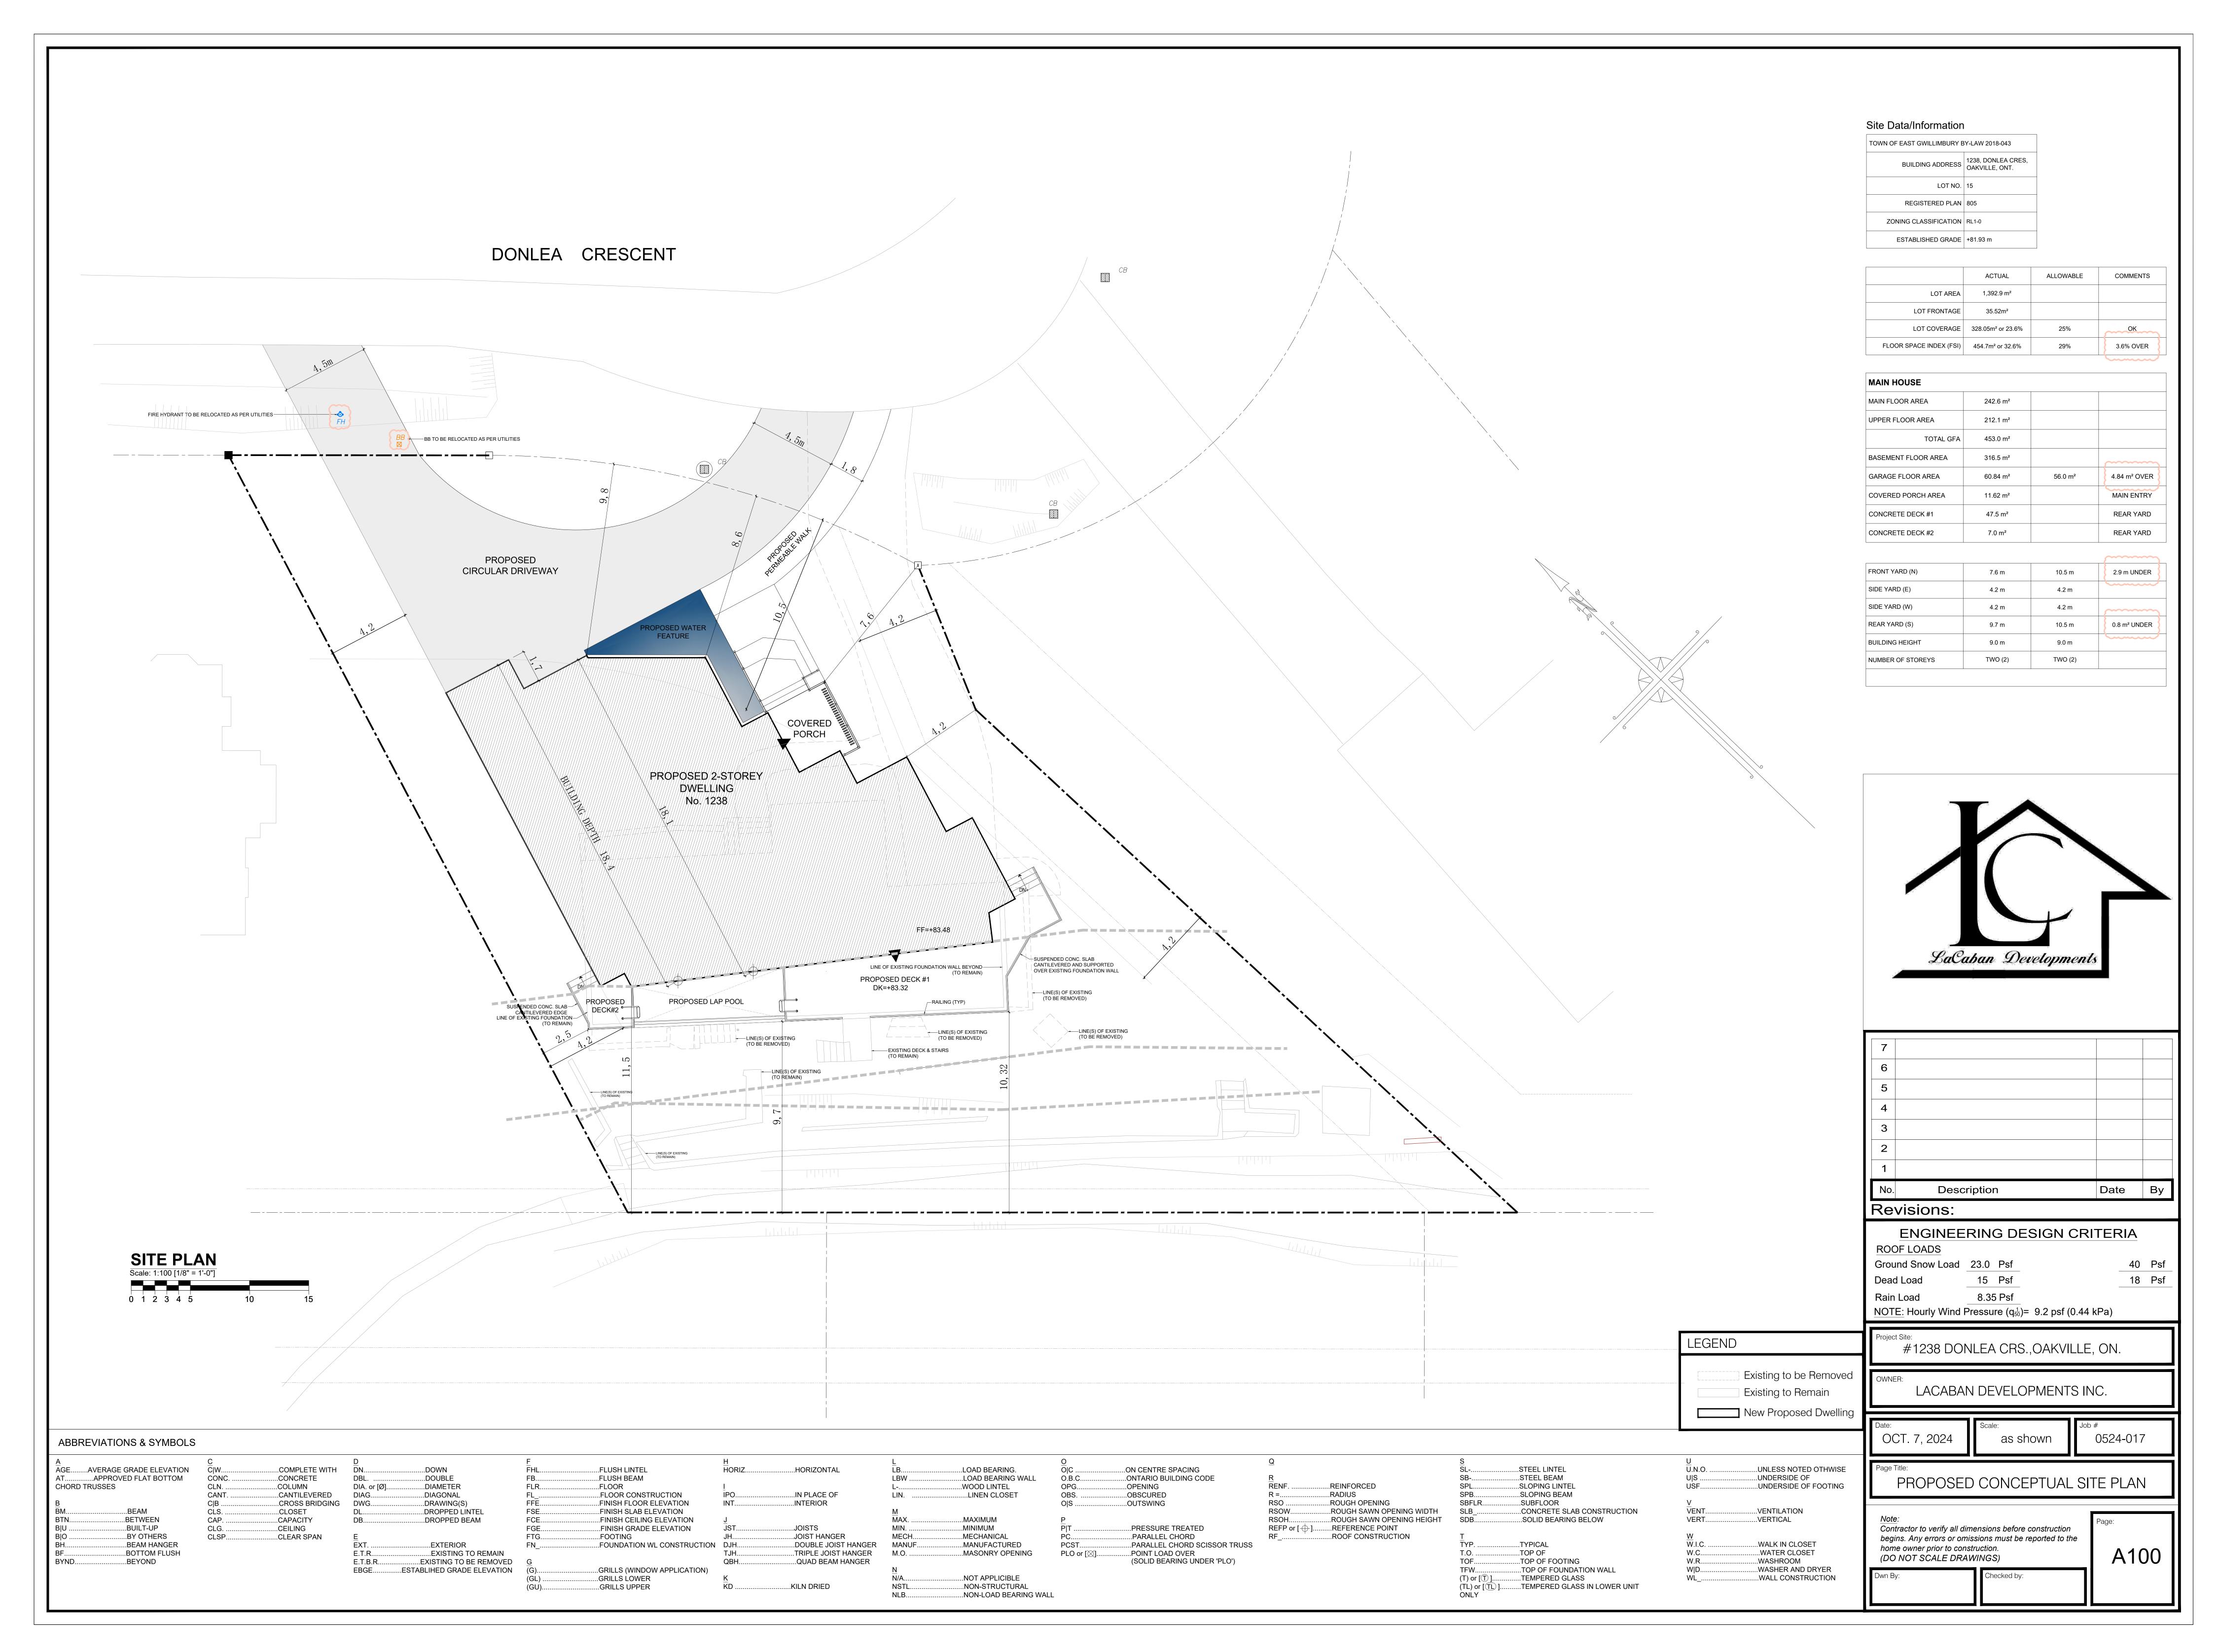

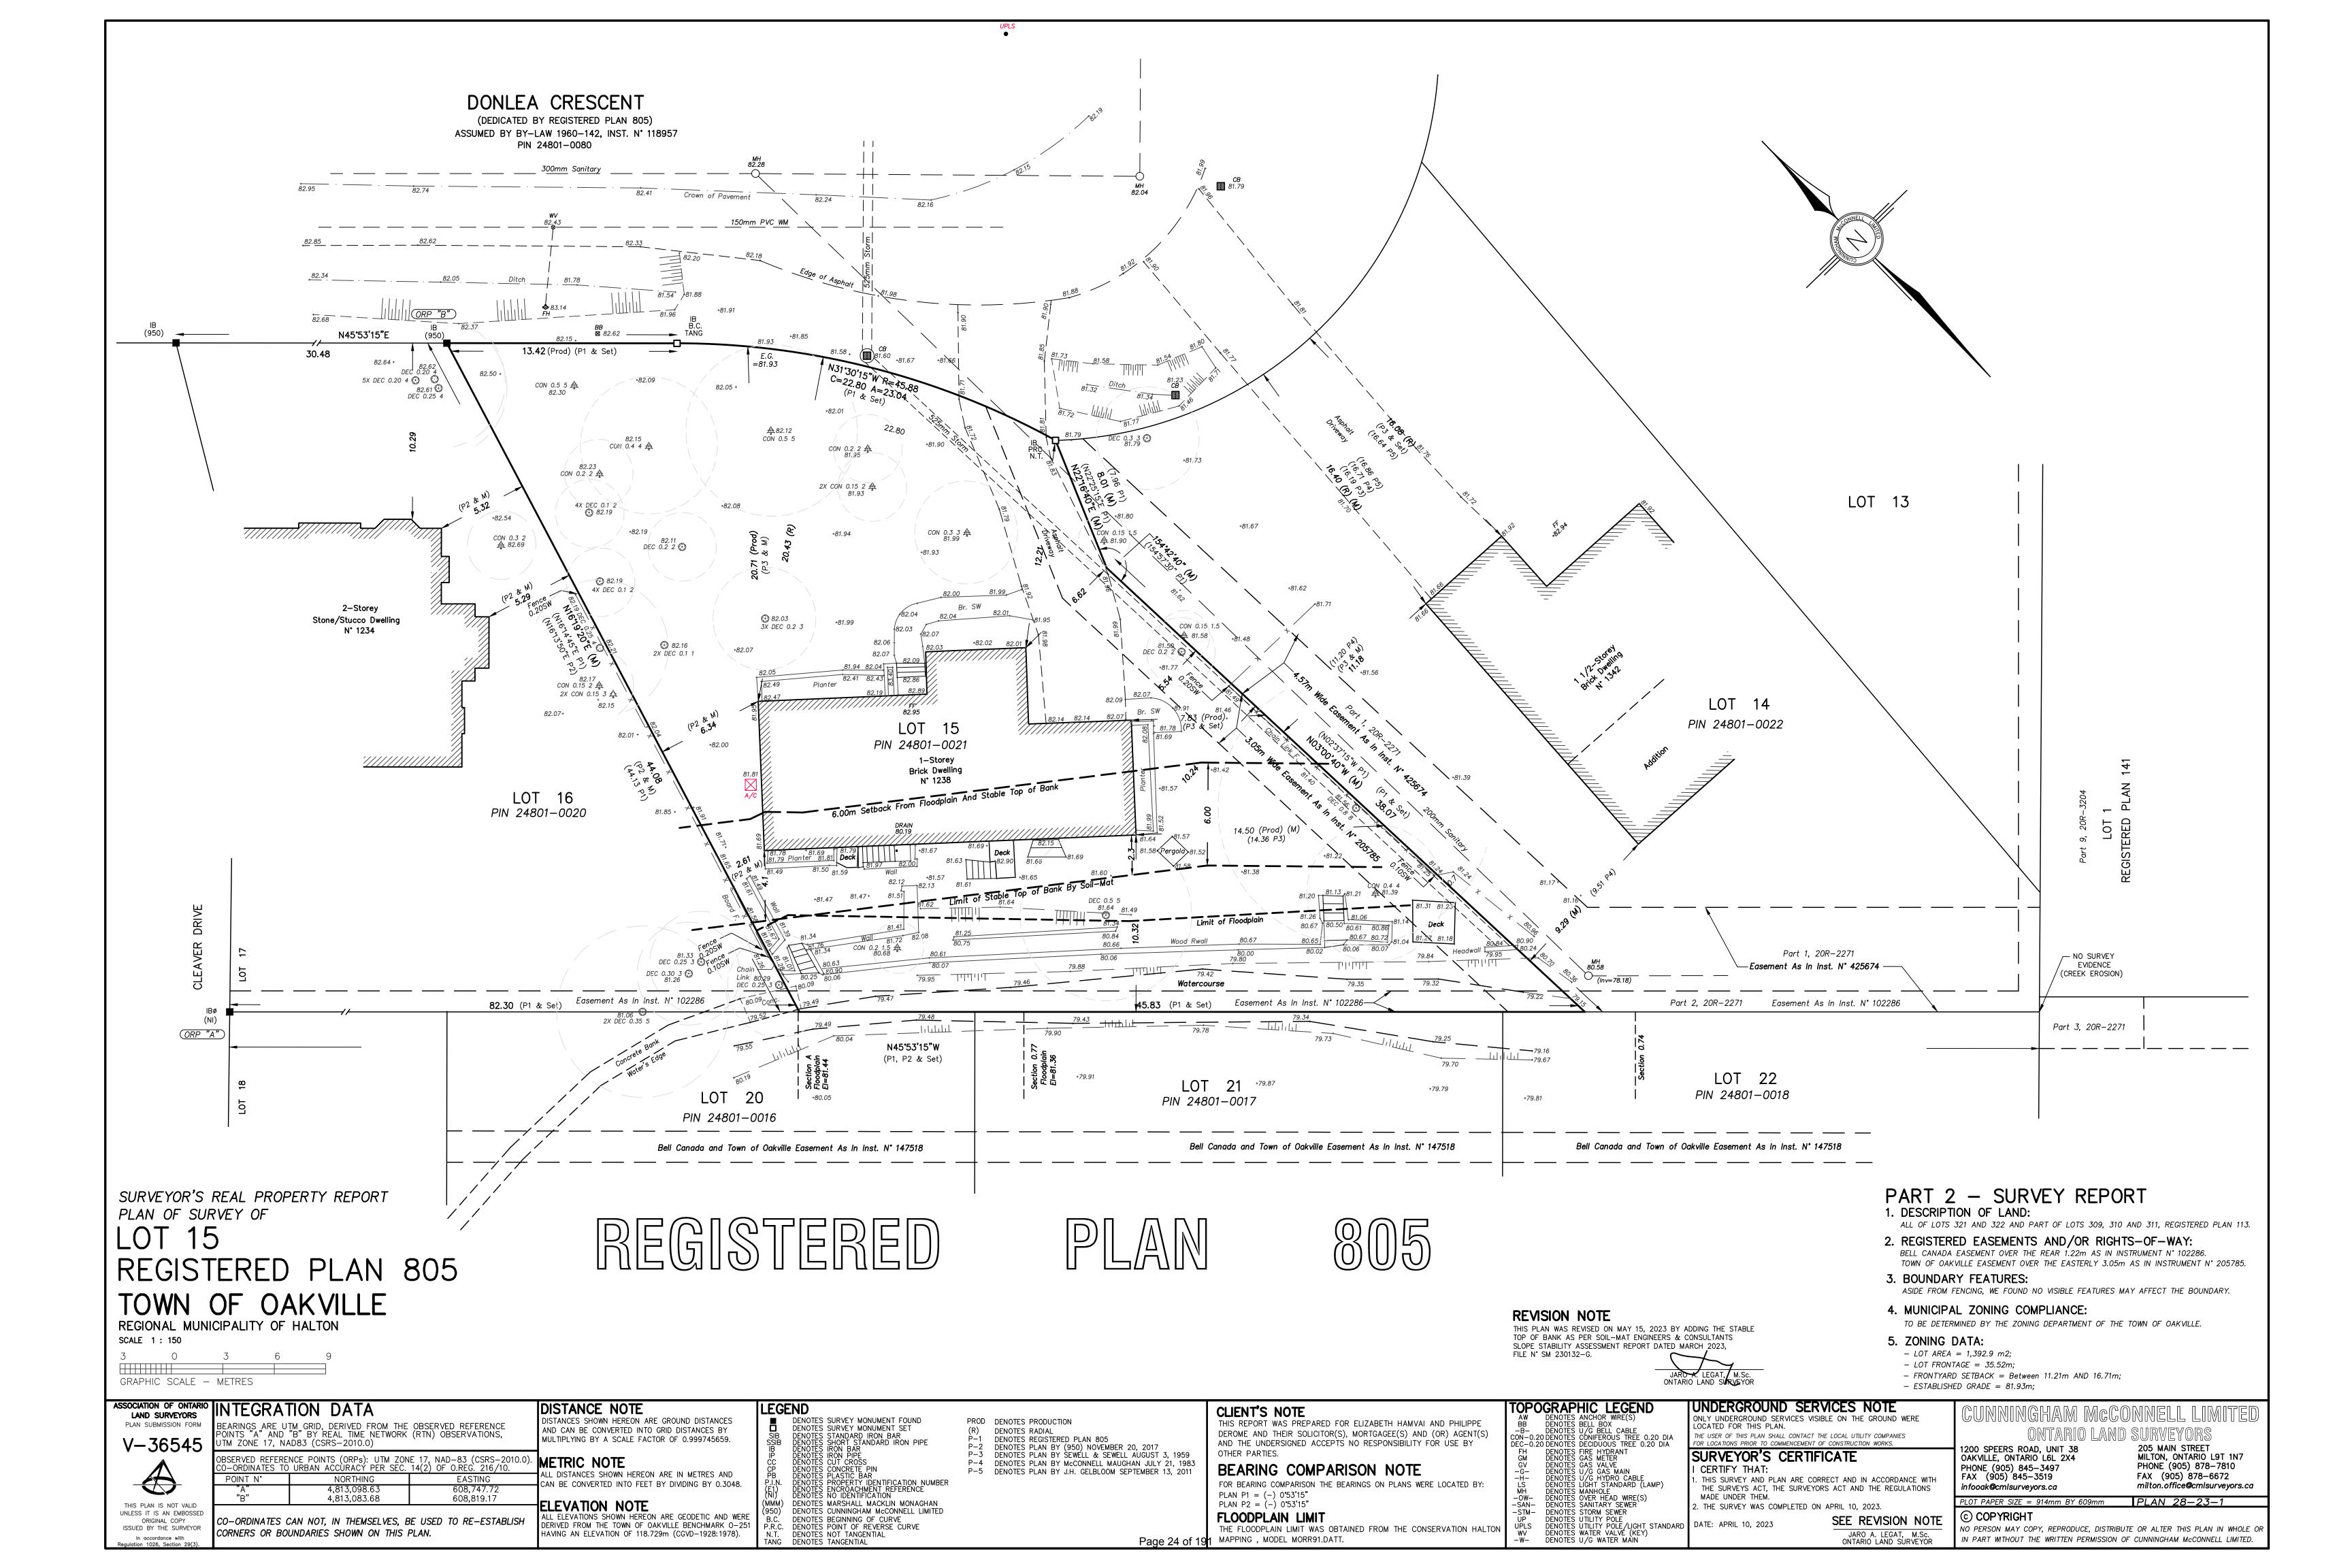File # CAV A/157/2024

Electronic hearing:

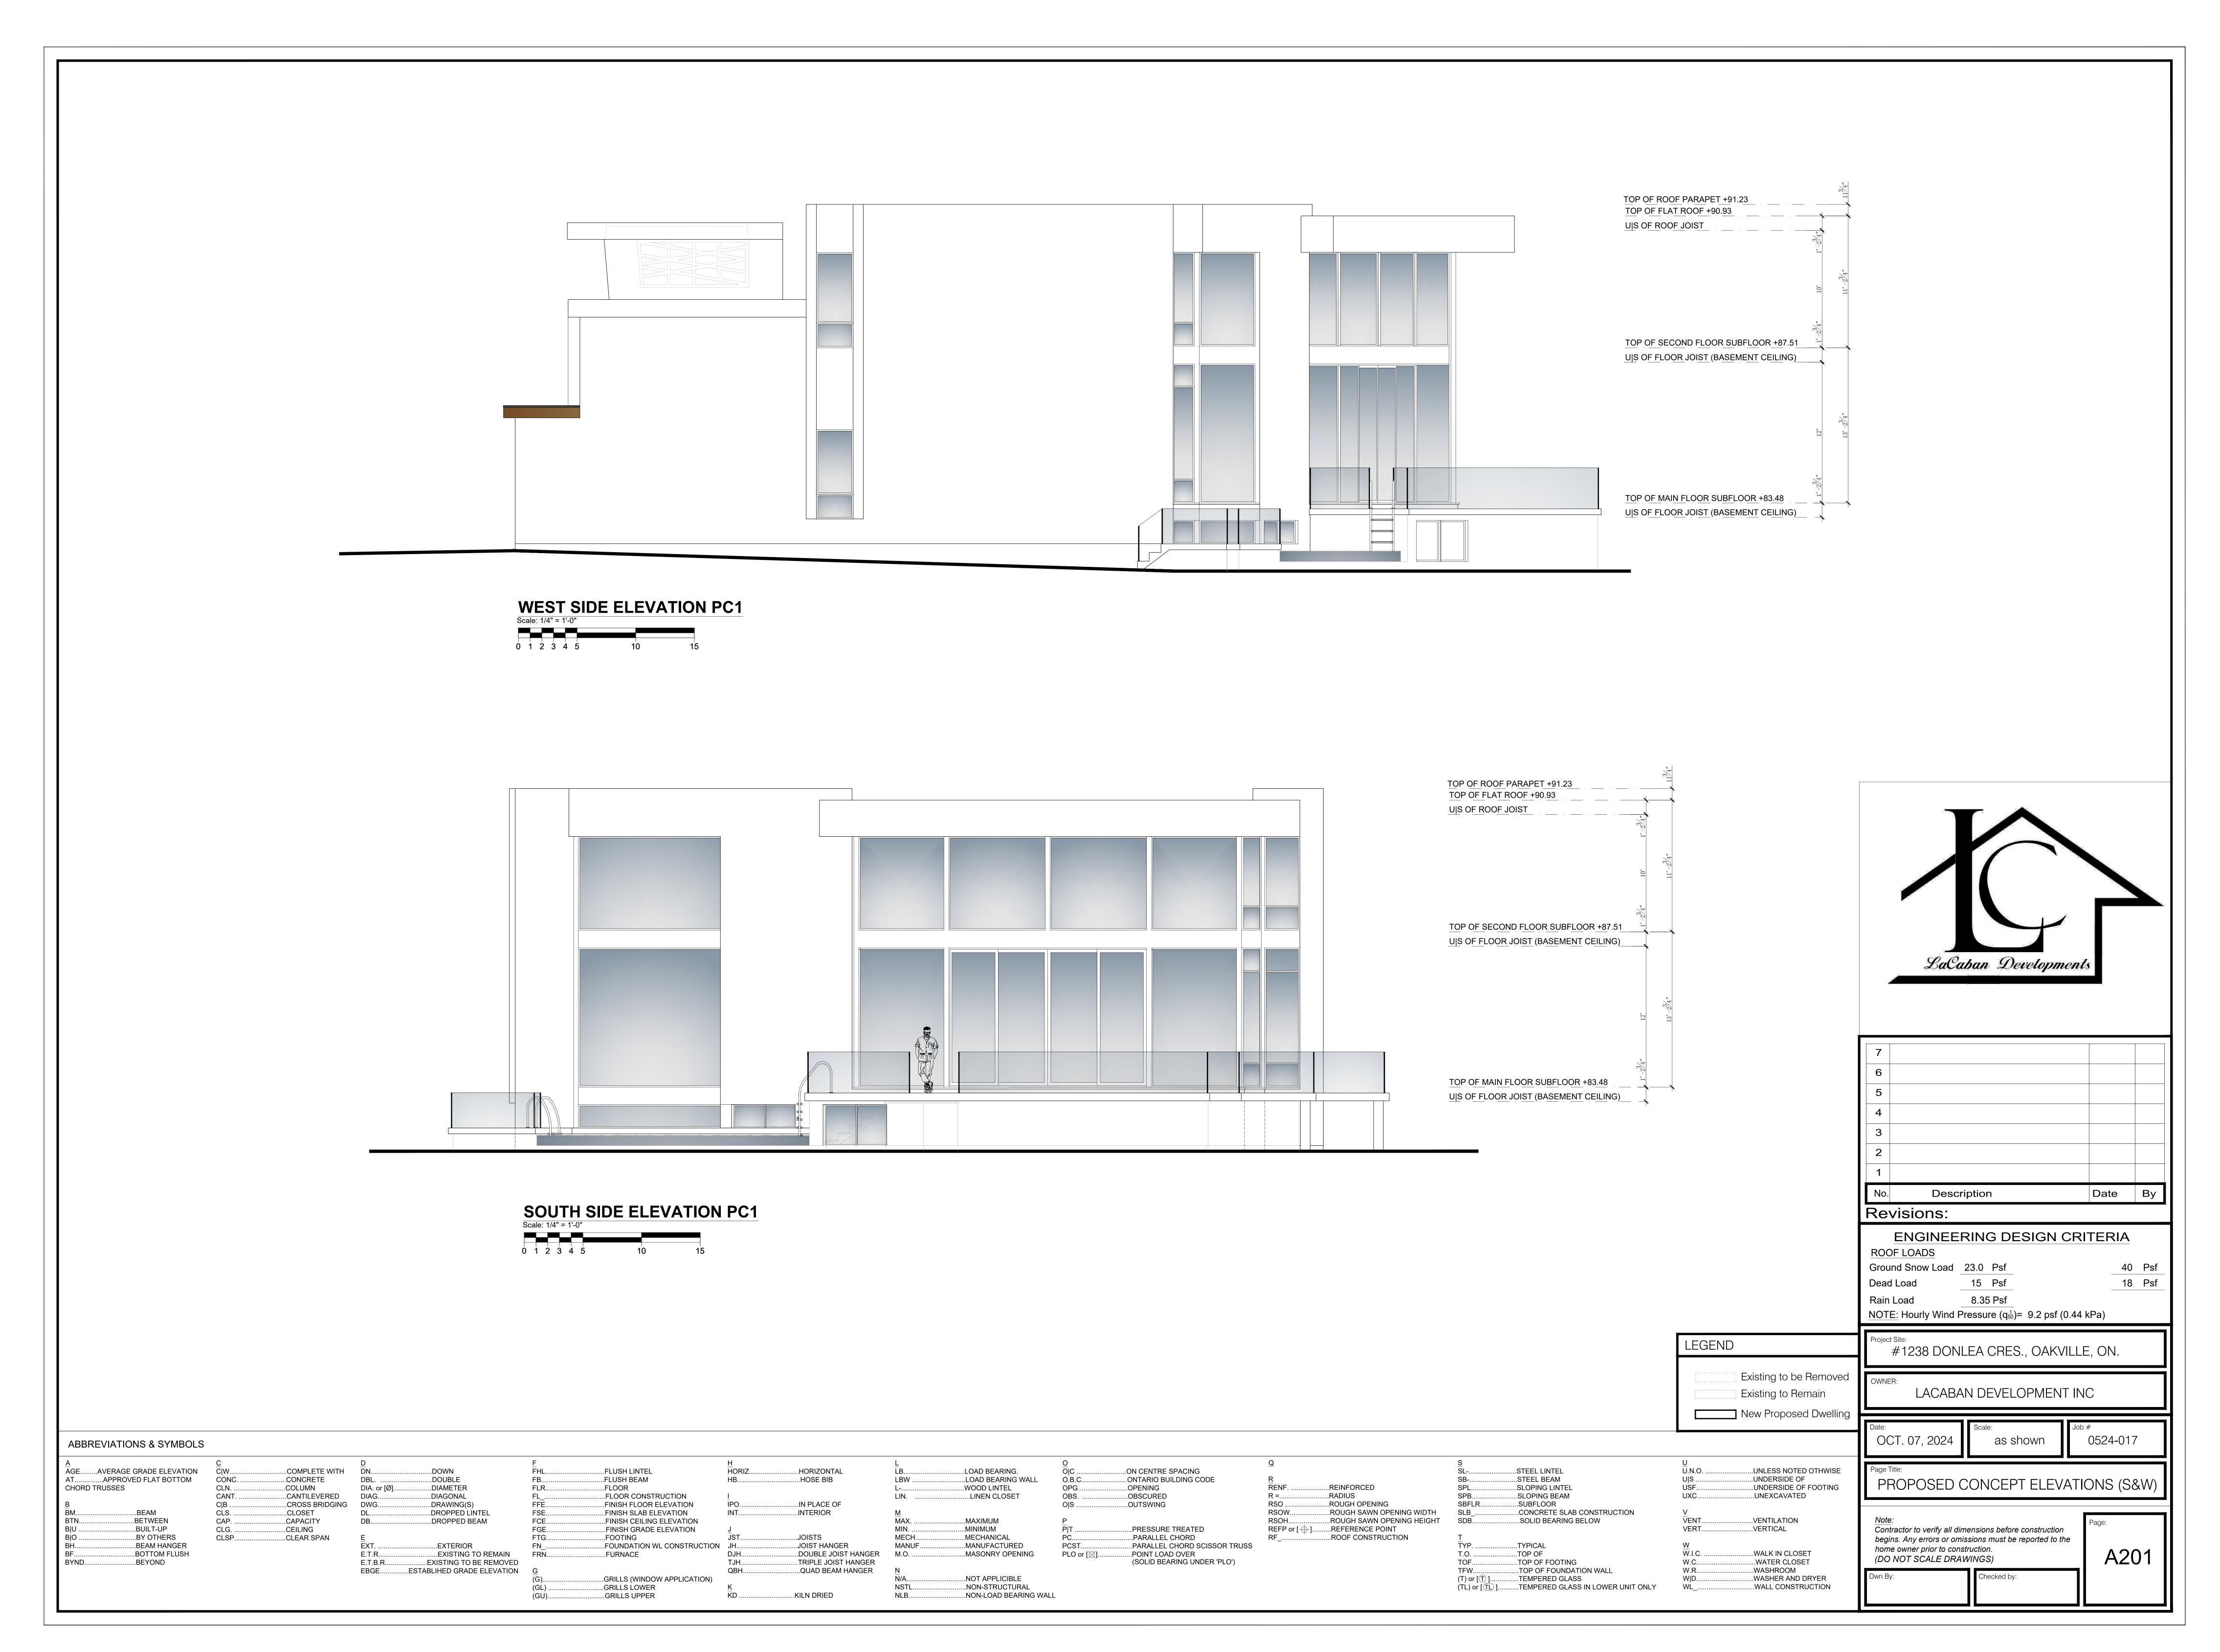By videoconference and live-streaming video on the Town of Oakville's Live Stream webpage at <u>oakville.ca</u> on November 13, 2024 at 7 p.m.
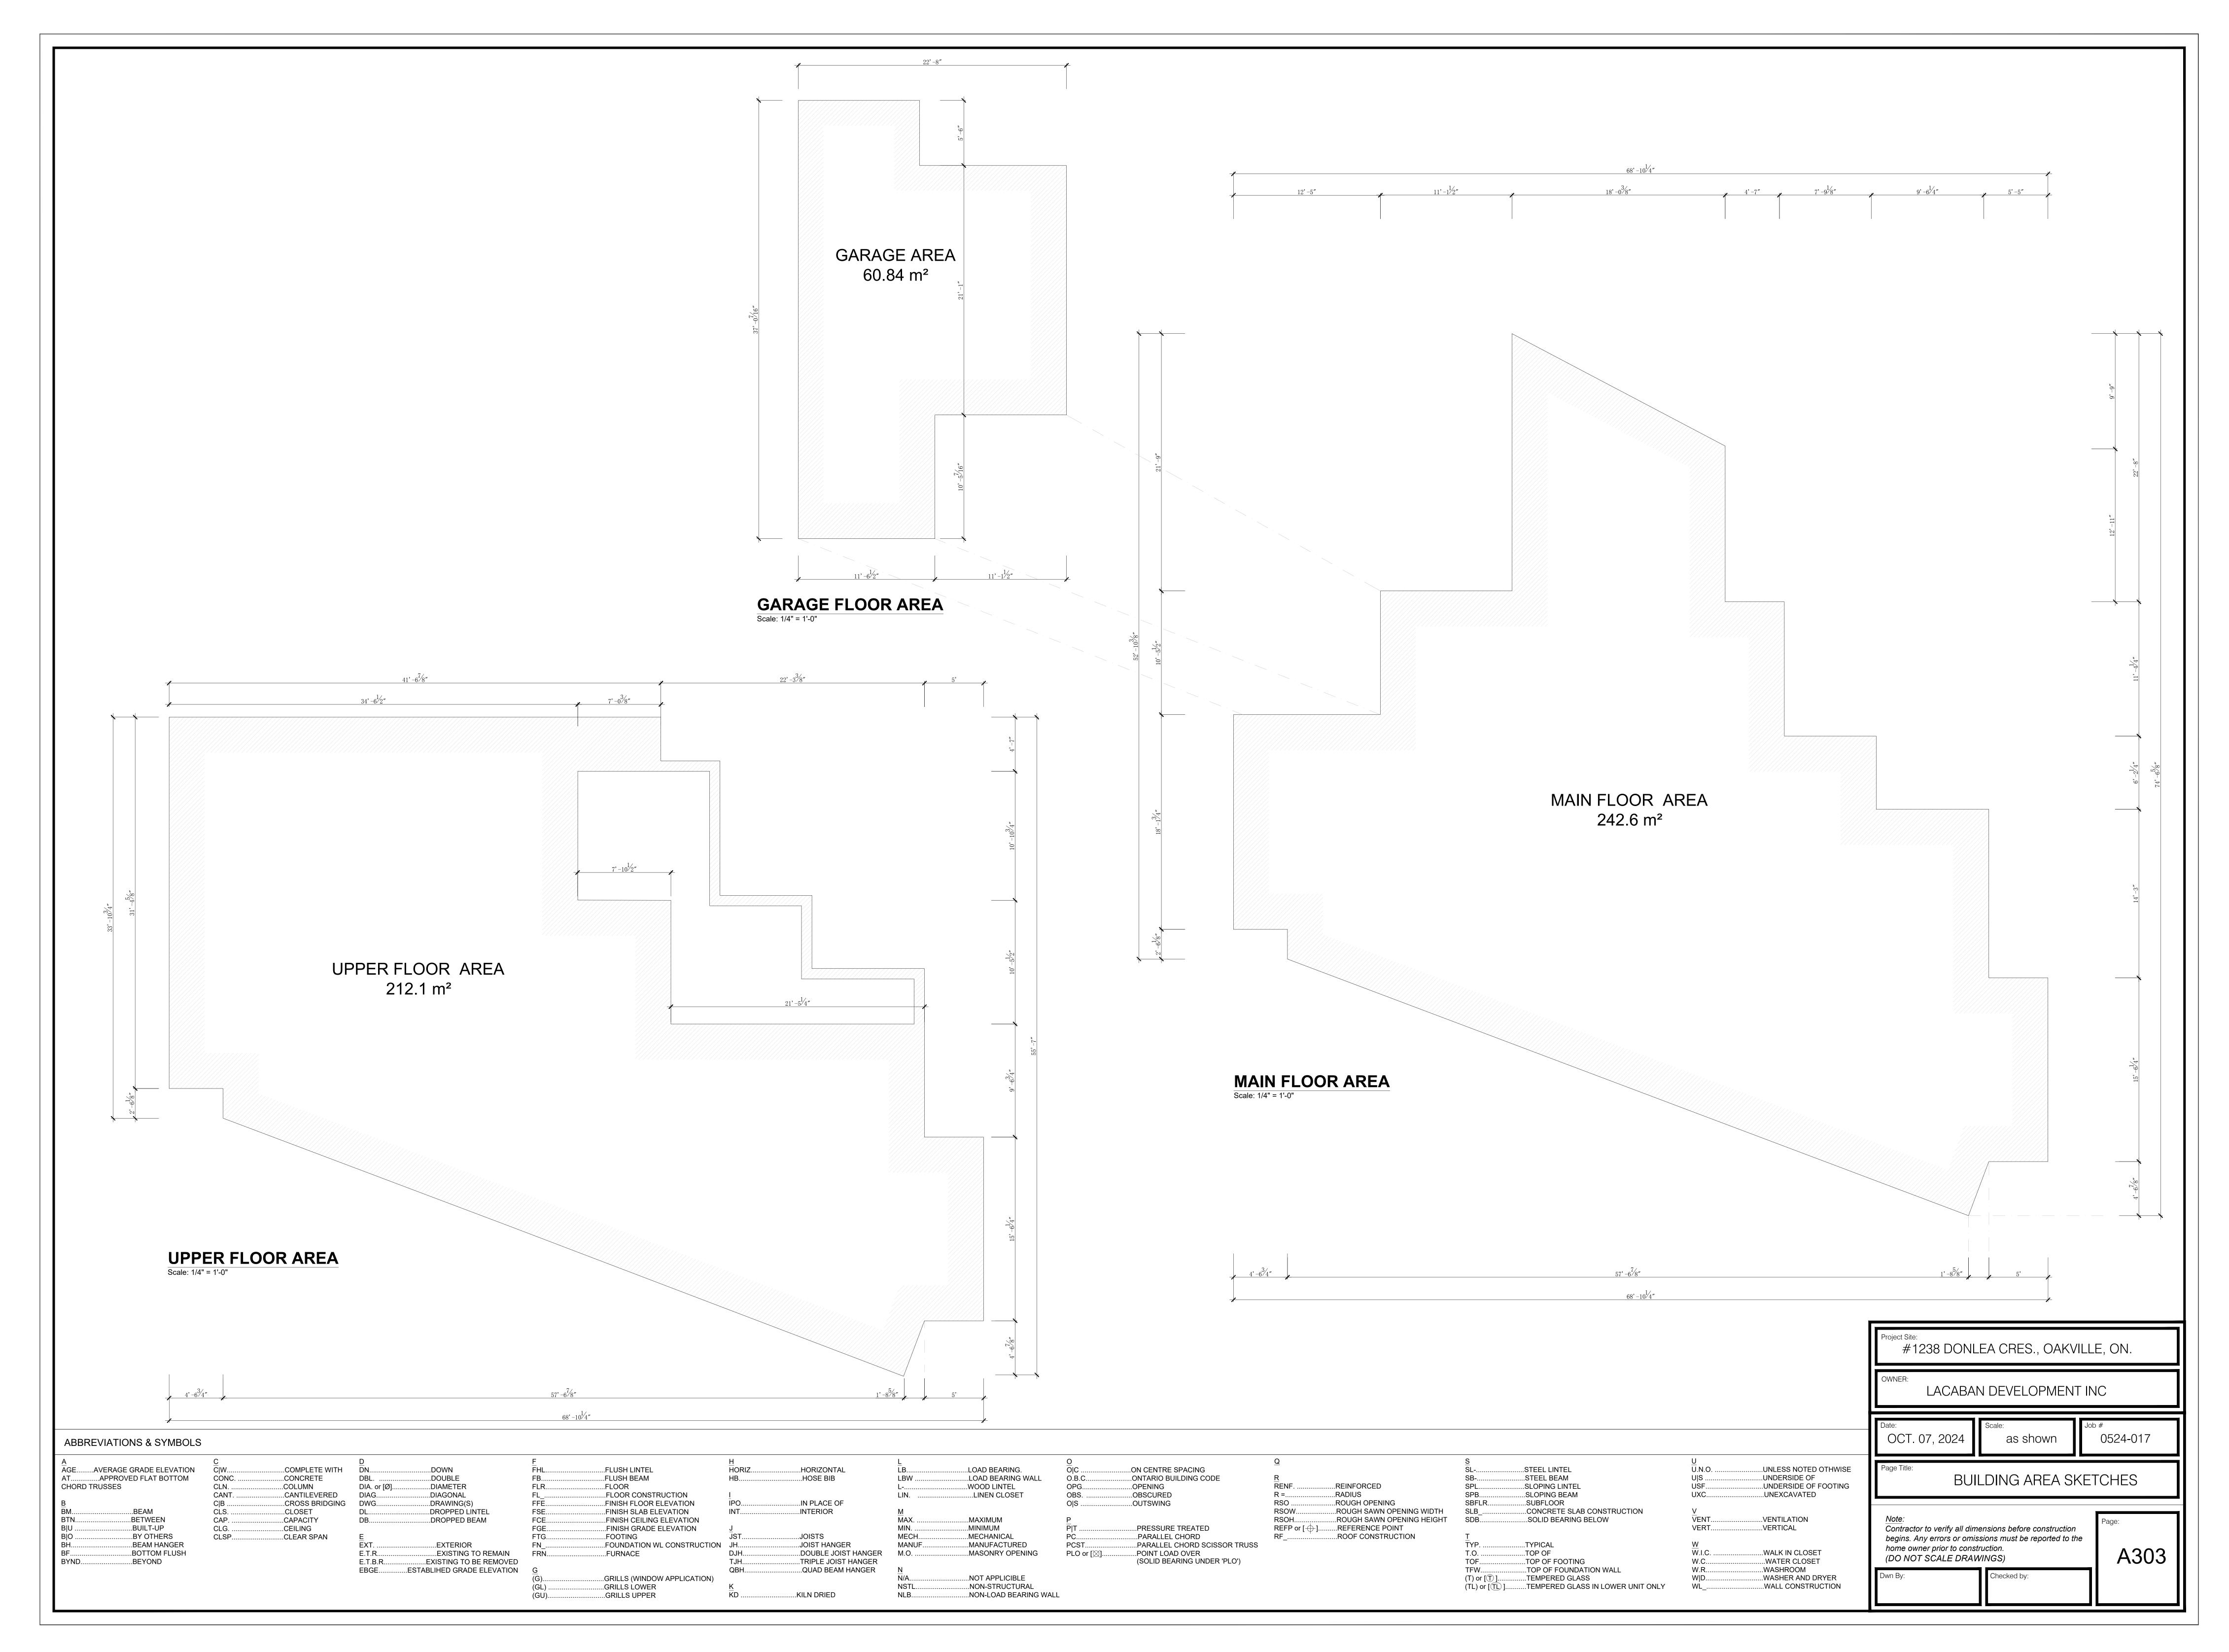
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Applicant and property information:

Applicant / Owner	Authorized Agent	Subject Property
O. Aluko	Ross Defina	1238 Donlea Cres
L. Tejuoso	Ross Defina Consulting	PLAN 805 LOT 15
	9 Wolfe Crt	
	Vaughan ON, CANADA L4J 6T9	

Zoning of property: RL1-0, Residential

Variance request:

Under Section 45(1) of the *Planning Act*, the applicant is requesting the Committee of Adjustment to authorize a minor variance to permit the construction of a two storey detached dwelling on the subject property proposing the following variances to Zoning By-law 2014-014:

No.	Current	Proposed
1	Section 5.8.6 c)	To increase the maximum total floor area for the
	For lots located within the Residential Low (RL1)	private garage to 60.84 square metres.
	Zone the maximum total floor area for a private	
	garage shall be 56.0 square metres.	
2	Table 6.3.1 (Row 6, Column RL1)	To reduce the minimum rear yard to 9.70 m.
	The minimum rear yard shall be 10.50 m.	
3	Table 6.4.1	To increase the maximum residential floor area
	The maximum residential floor area ratio for a	ratio to 32.60%.
	detached dwelling on a lot with a lot area	
	1301.00 m ² or greater shall be 29%.	
4	Section 6.4.3 (a)	To reduce the minimum front yard to 7.60 metres.
	The minimum front yard on all lots shall be the	
	yard legally existing on the effective date of this	

By-law less 1.0 metre. In this instance, the	
minimum front yard shall be 11.21 metres.	

How do I participate if I have comments or concerns?

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Notice of decision:


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Contact information:

Jennifer Ulcar Secretary-Treasurer of Committee of Adjustment 1225 Trafalgar Road Oakville, ON L6H 0H3 Phone: 905-845-6601 ext. 1829

Email: coarequests@oakville.ca

Date mailed: October 29, 2024

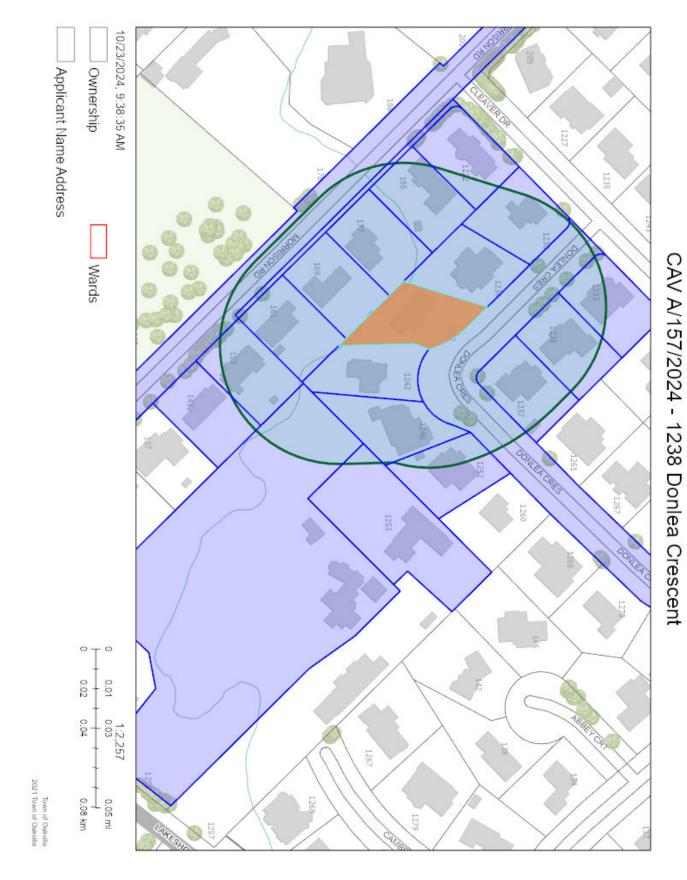


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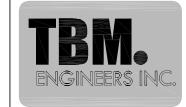
Project Address:
14 TIMBER LANE
0AKVILLE ON L6L 2Z3

Scope of Work:
Addition to existing detached dwelling.



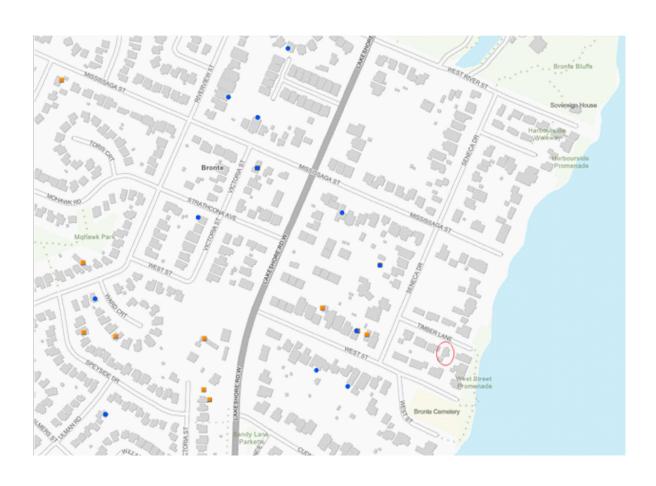


Key Plan



DESIGN. DELIVER. INNOVATE.

TBM Engineers Inc.

15 Jaylynn Crt. Woodbridge, ON (905) 893-9070 www.tbmengineers.com tbmengineers@mail.com

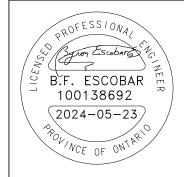

Project Address: 14 TIMBER LANE OAKVILLE ON L6L 2Z3

Addition to Detached Dwelling

Date Issued for: 2024-05-23 Building Permit


These Drawings are the sole property of TBM Engineers Inc. and must not be used for any other project and/or by any other person without written permission. All drawings must not be used for any construction before the building Permit. Do not scale this document.

Scale:

 $\frac{3}{16}$ " = 1'-0" (1:64)

Drawing No.

A-000

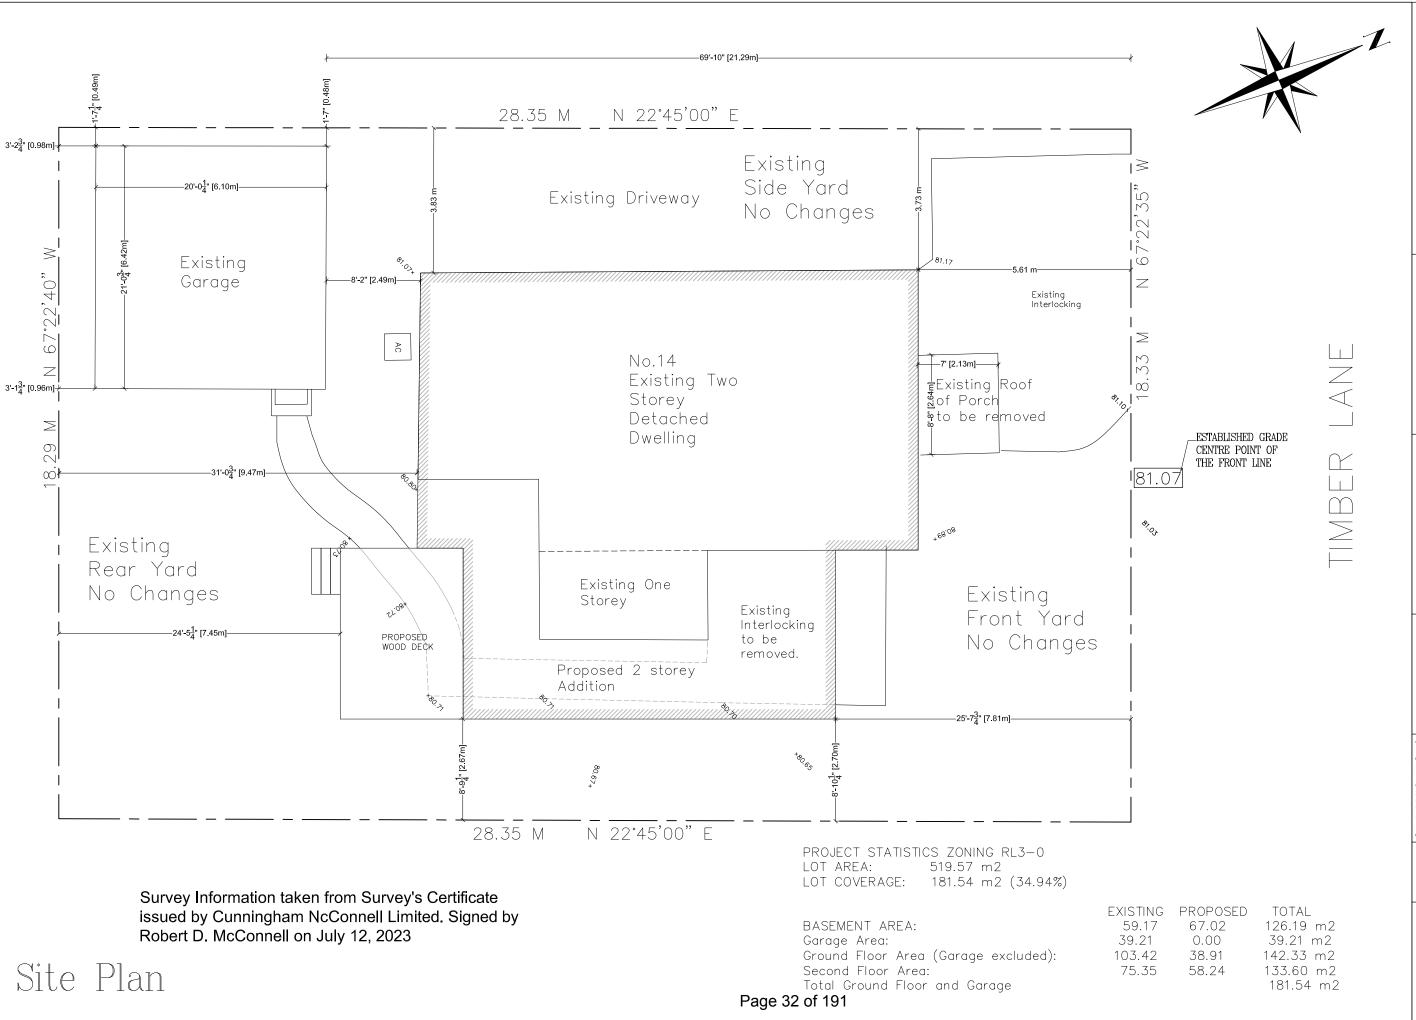



TBM Engineers Inc.

15 Jaylynn Crt. Woodbridge, ON (905) 893-9070 www.tbmengineers.com tbmengineers@mail.com



Project Address: 14 TIMBER LANE OAKVILLE ON L6L 2Z3

Addition to Detached Dwelling


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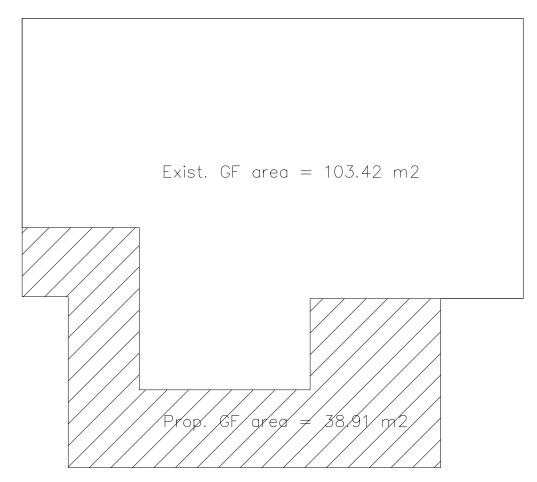
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Drawing No.


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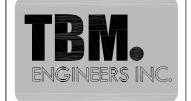






Total GF area = 142.33 m2

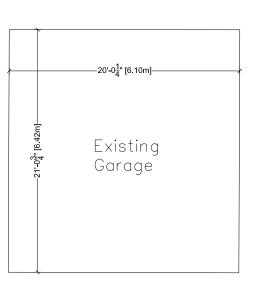

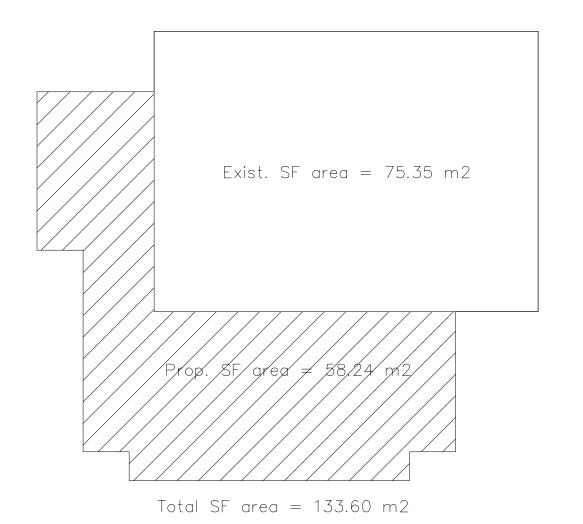

TBM Engineers Inc.

15 Jaylynn Crt. Woodbridge, ON (905) 893-9070 www.tbmengineers.com tbmengineers@mail.com



Project Address: 14 TIMBER LANE OAKVILLE ON L6L 2Z3

Addition to Detached Dwelling

Date Issued for: 2024-05-23 Building Permit

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Scale: 1:100

Drawing No.

A-101





TBM Engineers Inc.

15 Jaylynn Crt. Woodbridge, ON (905) 893-9070 www.tbmengineers.com tbmengineers@mail.com



Project Address: 14 TIMBER LANE OAKVILLE ON L6L 2Z3

Addition to Detached Dwelling

Date Issued for: 2024-05-23 Building Permit

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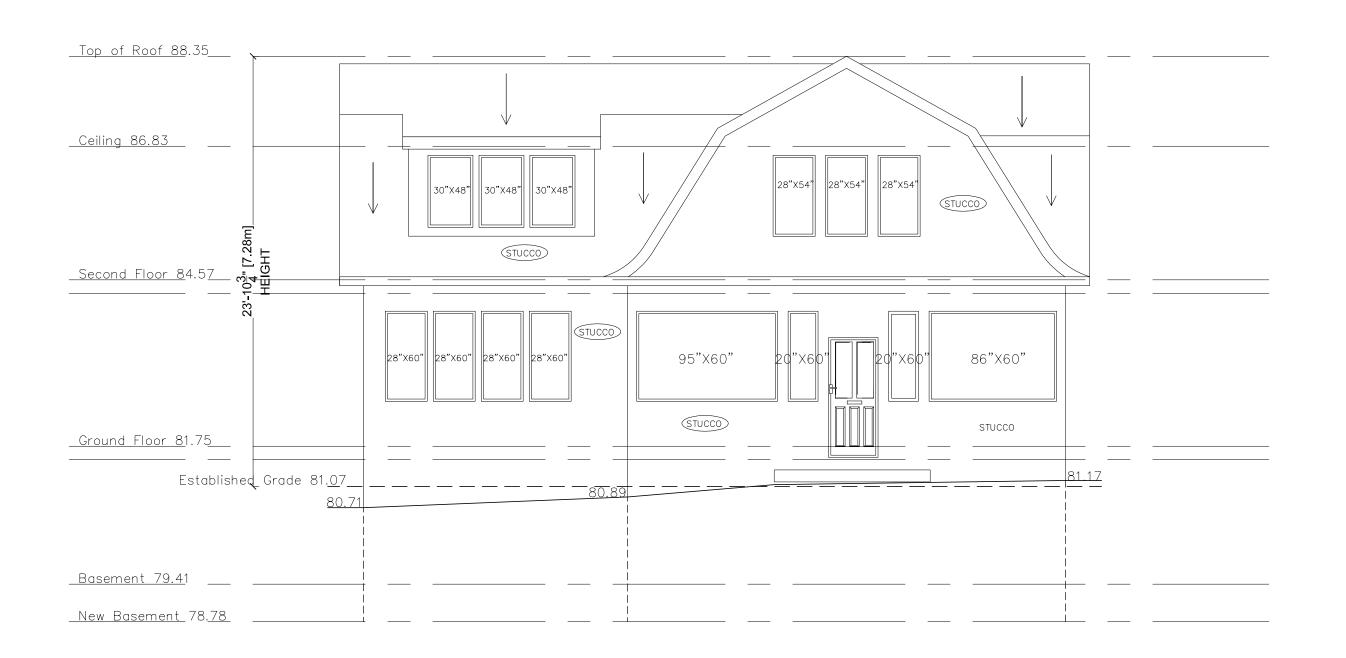
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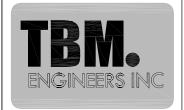
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Drawing No.

A-201


8 of 30





TBM Engineers Inc.

15 Jaylynn Crt. Woodbridge, ON (905) 893-9070 www.tbmengineers.com tbmengineers@mail.com

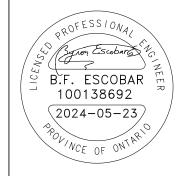

Project Address: 14 TIMBER LANE OAKVILLE ON L6L 2Z3

Addition to Detached Dwelling

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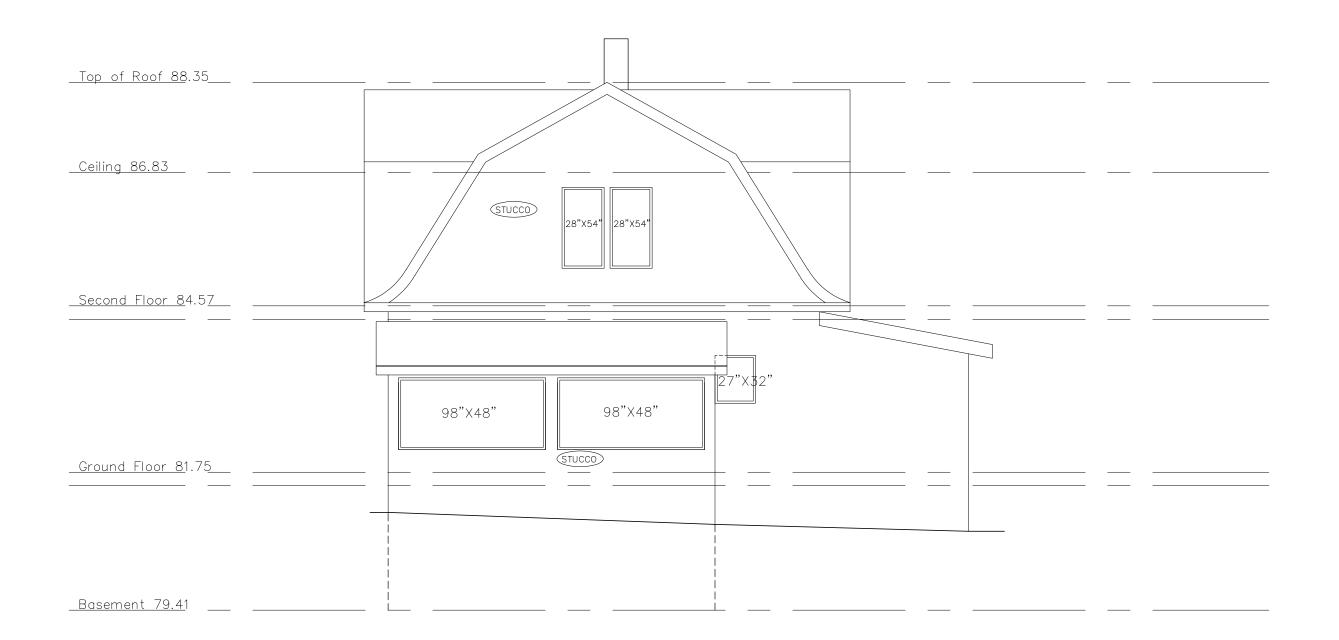
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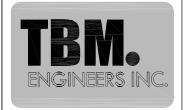
Drawing No.

A-205

20 of 30

Proposed Front (North) Elevation





TBM Engineers Inc.

15 Jaylynn Crt. Woodbridge, ON (905) 893-9070 www.tbmengineers.com tbmengineers@mail.com



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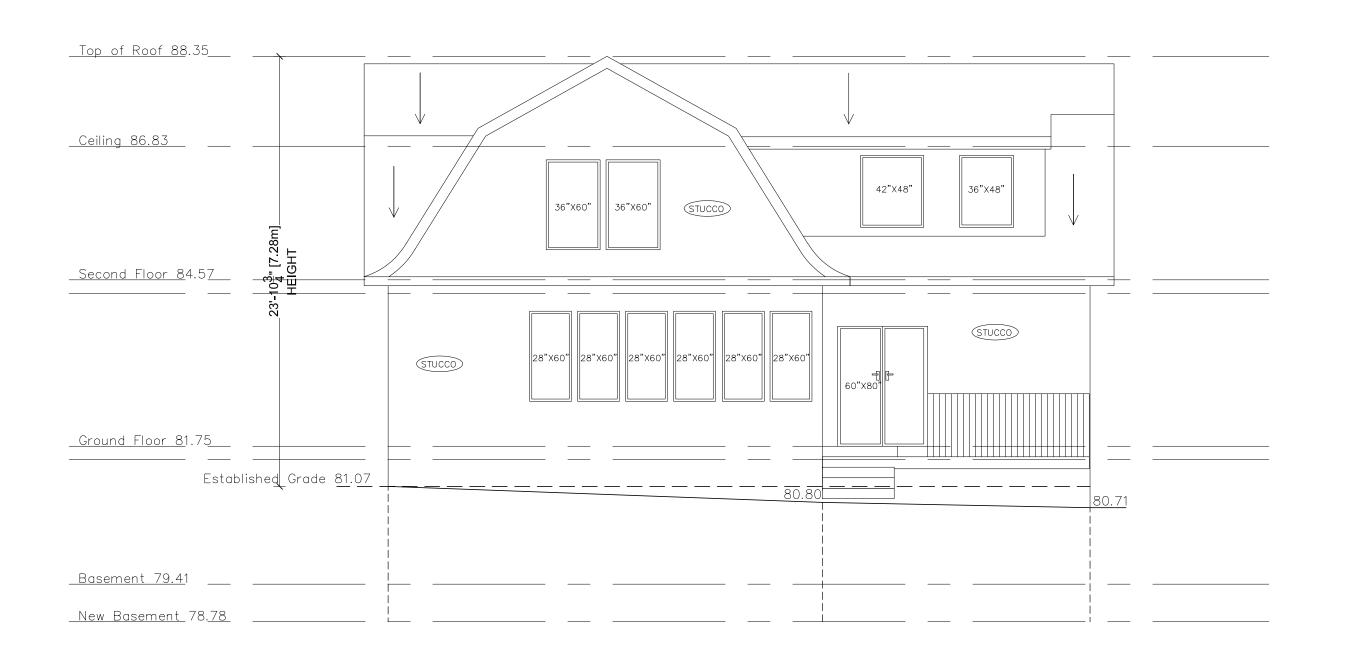
Scale:

 $\frac{3}{16}$ " = 1'-0" (1:64)

Drawing No.

A-202


9 of 30





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Project Address: 14 TIMBER LANE OAKVILLE ON L6L 2Z3

Addition to Detached Dwelling

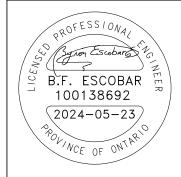
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Scale:

 $\frac{3}{16}$ " = 1'-0" (1:64)

Drawing No.



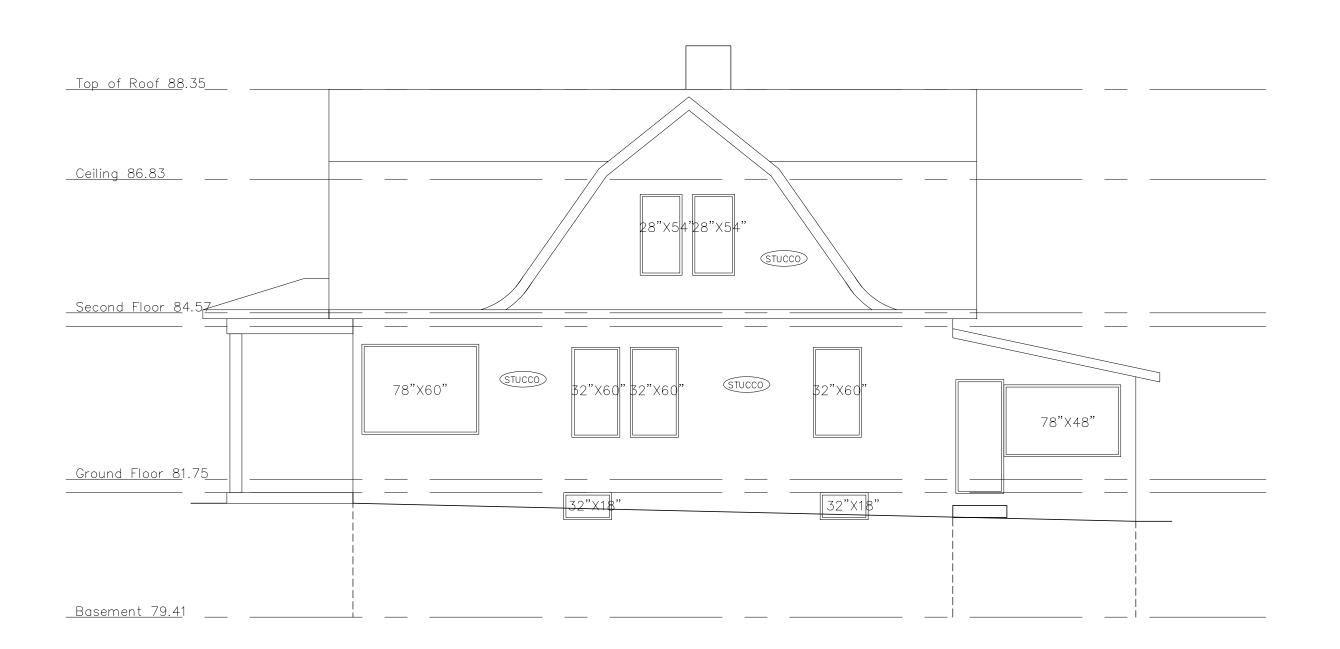

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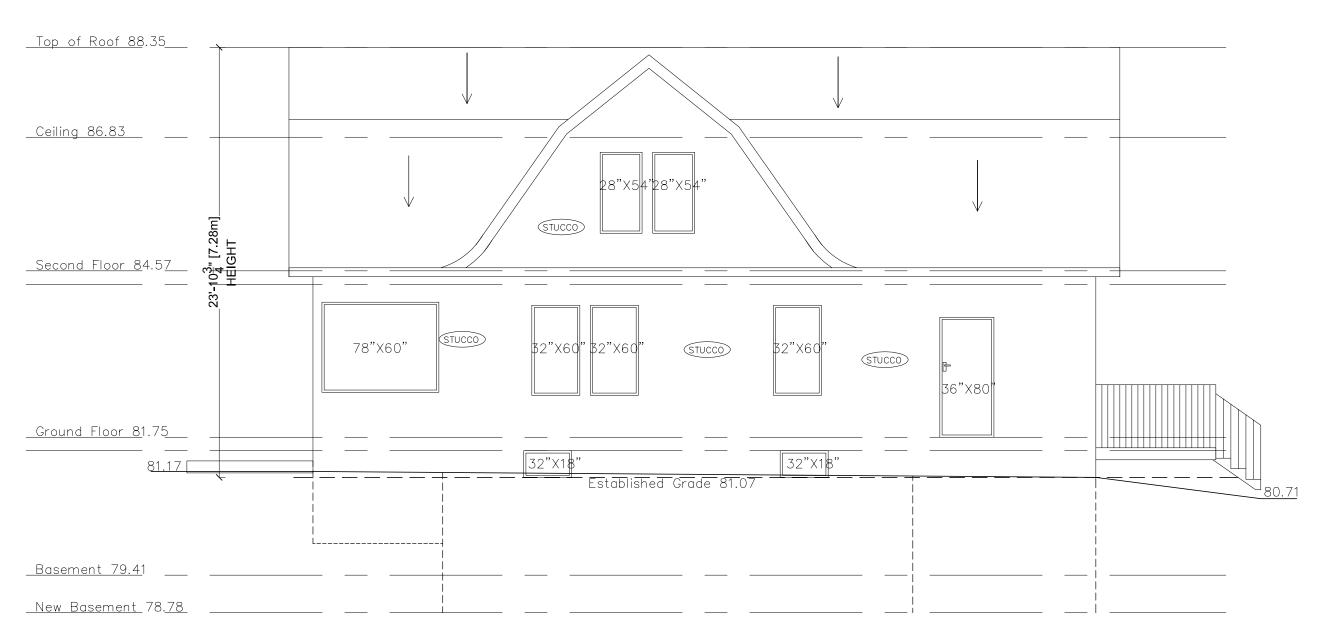
Date Issued for: 2024-05-23 Building Permit


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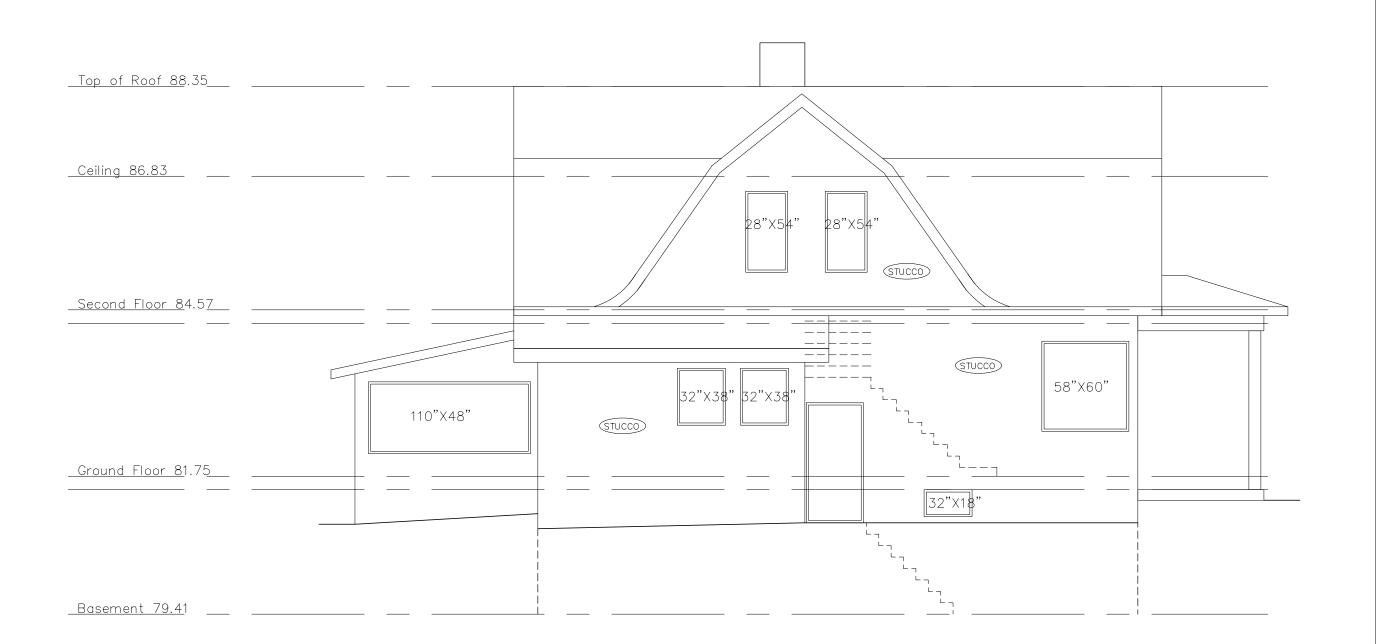
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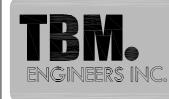
 $\frac{3}{16}$ " = 1'-0" (1:64)

Drawing No.

A-207

Proposed Right (West) Elevation



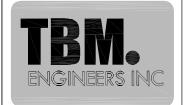

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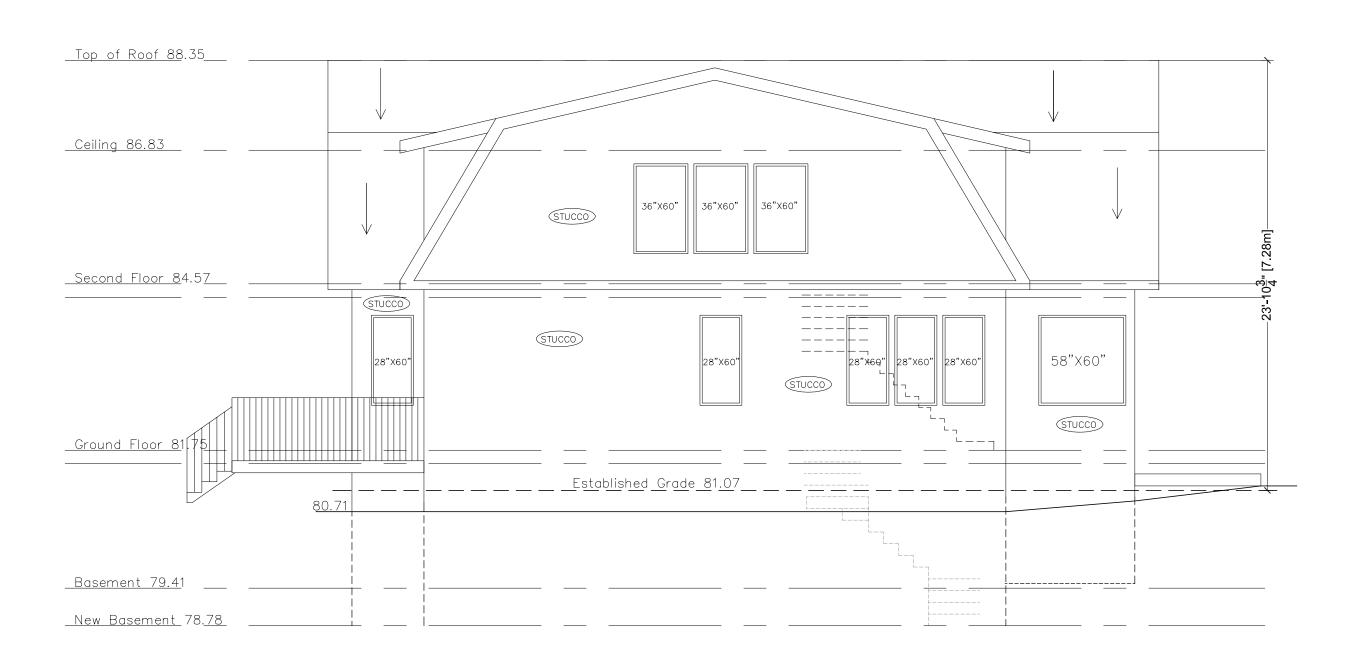
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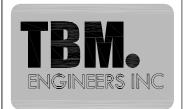
 $\frac{3}{16}$ " = 1'-0" (1:64)

Drawing No.

A-204

Existing Left (East) Elevation





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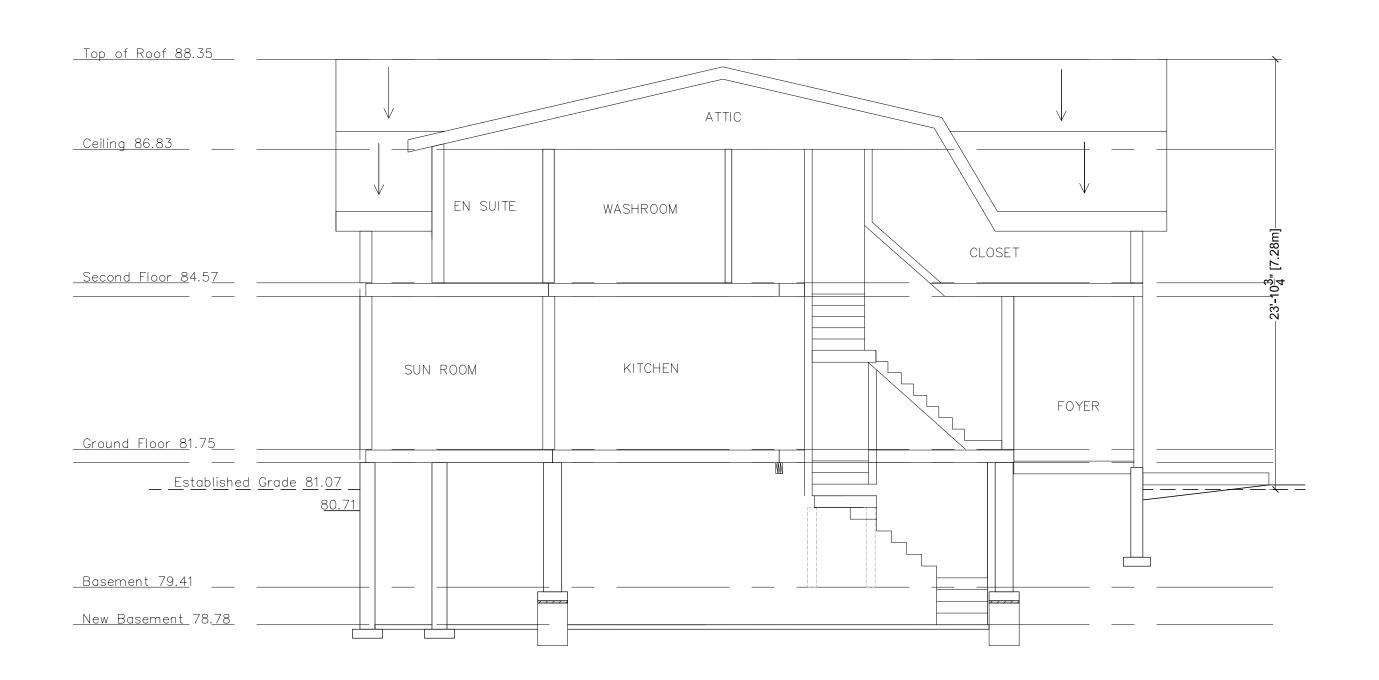
Date Issued for: 2024-05-23 Building Permit


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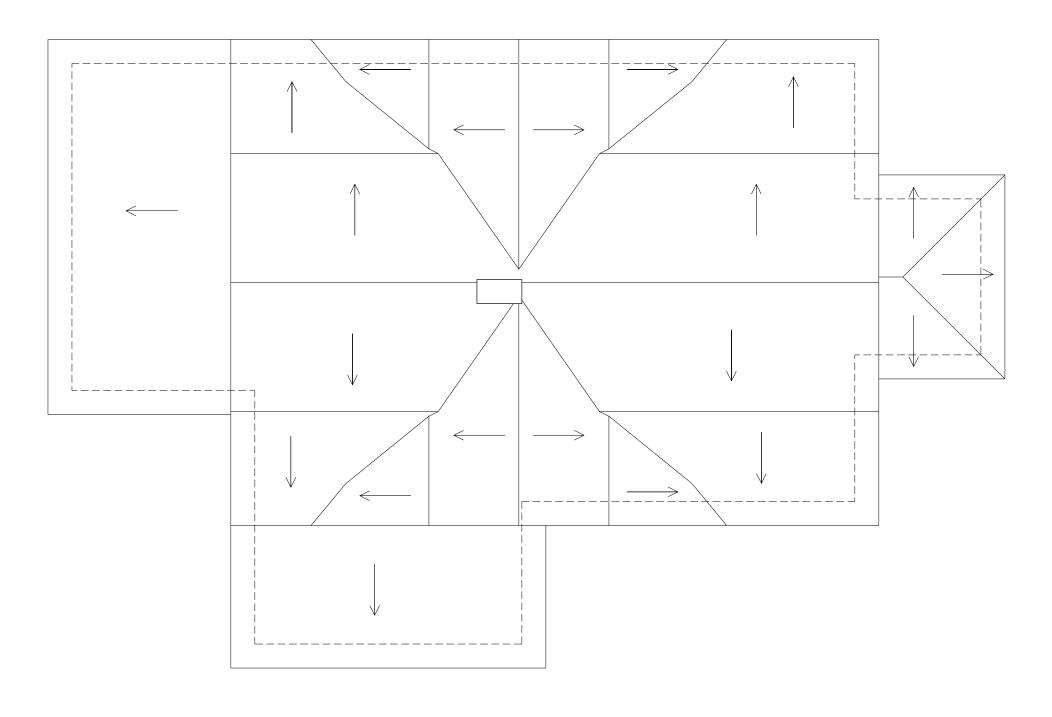
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Drawing No.








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Drawing No.

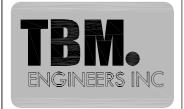GENERAL NOTES:

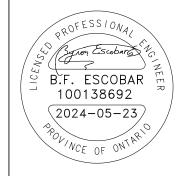- All work must comply with Ontario Reg. 332/12 (Building Code) and Ontario Reg. 213/91 (Construction Projects).
- All dimensions, locations, existing structural elements to be verified on site prior construction.
- Contractor to provide all temporary bracing and shoring necessary for the safe execution of this work
- All lumber to be No. 1 & 2 spruce or better
- All plywood shall be stamped exterior grade
- Interior Door Lintels:

Up to 4' $2-2"\times8"$

Up to 5' 2-2"x10"

Up to 6' 2-2"x12"

- Design loads are:

Live Load = 40 PSF, Dead Load = 20 PSF

- All members shall be so framed, fastened, tied, braced, and anchored to provide the necessary strength, rigidity, and stability OBC 9.23.2.1 and 4.1.1.3
 All loads must be supported and transferred to foundation or adequate support
- All guards and handrails to comply with OBC 9.8.7 and 9.8.8 requirements typical
- All exterior wood to be pressure treated

CONCRETE:


Unreinforced and reinforced concrete shall be designated, mixed, placed, cured and tested in accordance with the requirements for "R" class concrete stated in Clause 8.13 of CSA A23.1, "Concrete Materials and Methods of Concrete Construction", with a maximum aggregate size of 19 mm. For strip footings, footing pads and foundation walls, use 20 MPa. For concrete exposed to cold weather, use 32 MPa concrete with 5%-8% air entrainment.


STEEL REINFORCEMENT:

Reinforcement shall conform to CAN/CSA-G30.18-M "Billet-Steel Bars for Concrete Reinforcement" with a minimum specified yield strength of 400 MPa, and be lapped a minimum of 450 mm for 10M bars and 650 mm for 15 M bars.

STRUCTURAL STEEL:

Structural steel shall conform to CAN/C.S.A.—G40.20/G40.21 Grade 350W to be shop painted (primed). Structural steel connections to be welded on site. Contractor to submit stamped shop drawings for approval prior fabrication. Structural elements to be supported on steel, concrete, or masonry walls. Do not support steel on wood, LVL, or combustible materials.

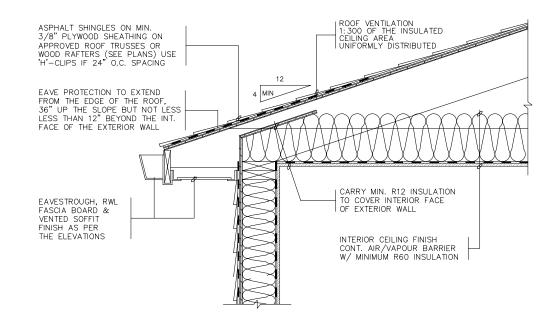

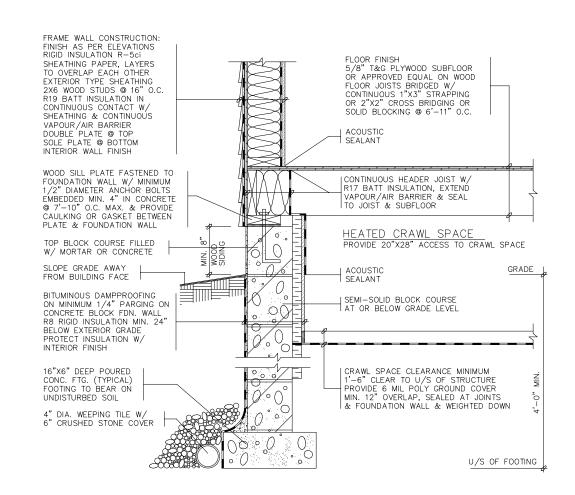



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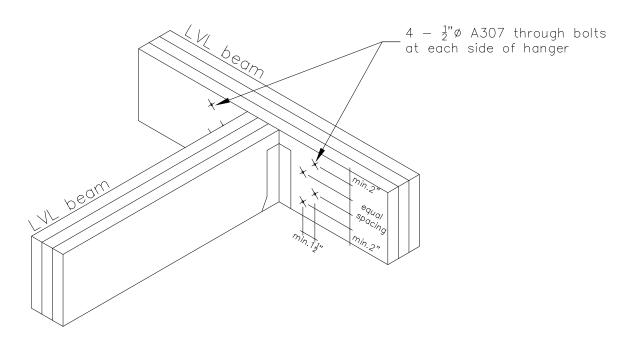
 $\frac{3}{16}$ " = 1'-0" (1:64)

Drawing No.

S-501

25 of 30

Specifications



8-Bolt Beam-Beam Connection


3100F_b-2.0E 1¾" WEST FRASER™ LVL

Maximum Factored Uniform Load (PLF) Applied to Either Outside Member		PLF) her	2 - PLY LVL	2° 3-PLY IVL	2° 4-PLY LVL*
Connector	Spacing	Rows	Nails On One Side or Through Bolts	Nails Both Sides or Through Bolts	Through Bolts Only
	12" o.c.	2 Rows	885	663	Not Applicable
		3 Rows	1327	995	Not Applicable
16d (3½") Common	6" o.c.	2 Rows	1770	1326	Not Applicable
Wire Nails		3 Rows	2654	1990	ногирисане
	4" o.c.	2 Rows	2655	1989	Not Applicable
		3 Rows	3981	2985	norApplicable
½" A307	24" o.c.	2 Rows	671	503	448
Through	12" o.c.	2 Rows	1342	1006	895
Bolts	6" o.c.	2 Rows	2684	2012	1790
* 4-ply beams should only be side-loaded when loads are applied to both sides of the member. 2. Bolts are to be material conforming to ASTM Standard A307. Bolt holes are to be the same diameter as the holt and located 2* from the top and bottom of the member Washers chould					

4-ply beams should only be side-loaded when loads are applied to both sides of the member.

Nails to be located a minimum of 2* from the top and bottom of the member. Start all nails

Residence of 24 of from another.

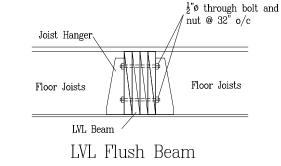

Floor Joists Floor Joists LVL beam LVL Dropped Beam

Specifications

WOOD CONSTRUCTION

Wood framing design and construction shall conform to CAN/CSA-086 "Engineering Design in Wood". Wood trusses and manufactured framing members are to be designed and certified by Professional Engineer for loads conditions indicated on drawings. Framed walls are to be wind braced at all corners in both directions. Lumber to be SPF No. 1 / 2 or better unless noted otherwise. Moisture content to be 19% or less. Lumber not to be drilled or notched without permission of consultant. Roof sheathing to be minimum 1/2" plywood conforming CSA O151 "Canadian Softwood Plywood". Wall sheathing to be minimum 3/8" plywood conforming CSA O151 "Canadian Softwood Plywood" or $\frac{7}{16}$ " O-2 OBS conforming CSA O0452 "Design Rated OSB". Floor sheathing to be 5/4" T&G plywood conforming CSA O151 "Canadian Softwood Plywood". Subfloor to be glued and nailed / screwed to every supporting member. Bolted connections shall be made using grade A307 bolts unless otherwise noted. Use pressure treated lumber (CWPB approved) or apply suitable wood preservative to all wood in contact with soil. Wood shall not be installed directly on masonry or concrete without protection: provide 6 MIL (0.152 mm) polyethylene sheet. Solid horizontal blocking shall be provided @ 48" o.c. in the first two joists spaces adjacent to exterior walls and attached to exterior walls to provide lateral stability. Provide 2"x2" diagonal cross bridging @ 96" o.c. for all sawn joist locations. All nails conforming steel wire nails and spikes as defined in CAS Standard B111 "Wire, Nails, Spikes, and Staples". Laterally support all steel beams by pre-drilling flanges for $\frac{1}{2}$ "Ø bolted attachments for wood nailers with $\frac{9}{16}$ "Ø holes staggered at 24" o.c.. Use joist hangers where framing members connect into the sides of supporting members. All steel connectors (uplift clips, brackets, joists hangers, etc.) to be Simpson Strong Tie connectors unless otherwise noted. All nails and fasteners in contact with pressure treated wood are to be hot dip galvanized as per CSA-G164 or stainless steel. For built up members, (trusses, beams, lintels) provide a built up post with equal or greater thickness. All built up posts to be continuous (including transfer blocking at floors) down to the foundation or adequate support. All built up members to be fastened together with two 3" spiral nails at 12" o.c. for every ply.

CONSTRUCTION JOINTS:

Construction joists shall be made and located so as not to impair the strength of the structure. If construction joists are not specifically located on drawings, Engineer must be consulted. Construction joints must line up with other building joints (expansion, masonry, concrete, etc.) where possible.



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Addition to Detached Dwelling

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Drawing No.

S-502


26 of 30


CONCRETE:


Unreinforced and reinforced concrete shall be designated, mixed, placed, cured and tested in accordance with the requirements for "R" class concrete stated in Clause 8.13 of CSA A23.1, "Concrete Materials and Methods of Concrete Construction", with a maximum aggregate size of 19 mm. For strip footings, footing pads and foundation walls, use 20 MPa. For concrete exposed to cold weather, use 32 MPa concrete with 5%—8% air entrainment.

STEEL REINFORCEMENT:


Reinforcement shall conform to CAN/CSA-G30.18-M "Billet-Steel Bars for Concrete Reinforcement" with a minimum specified yield strength of 400 MPa, and be lapped a minimum of 450 mm for 10M bars and 650 mm for 15 M bars.

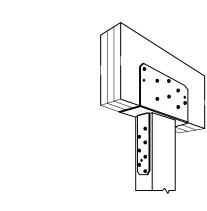

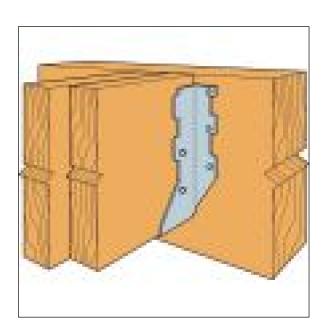


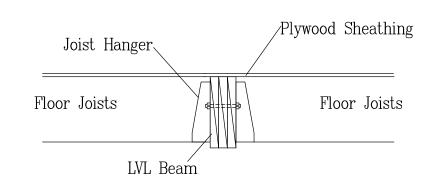

WOOD BEAM CONNECTION

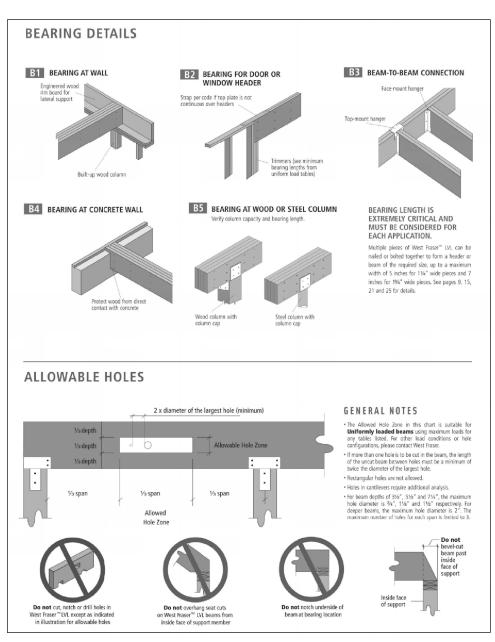

SUPPLIER SPECIFICATIONS

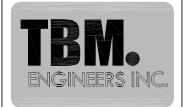

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27 of 30

Drawing No.

S-503

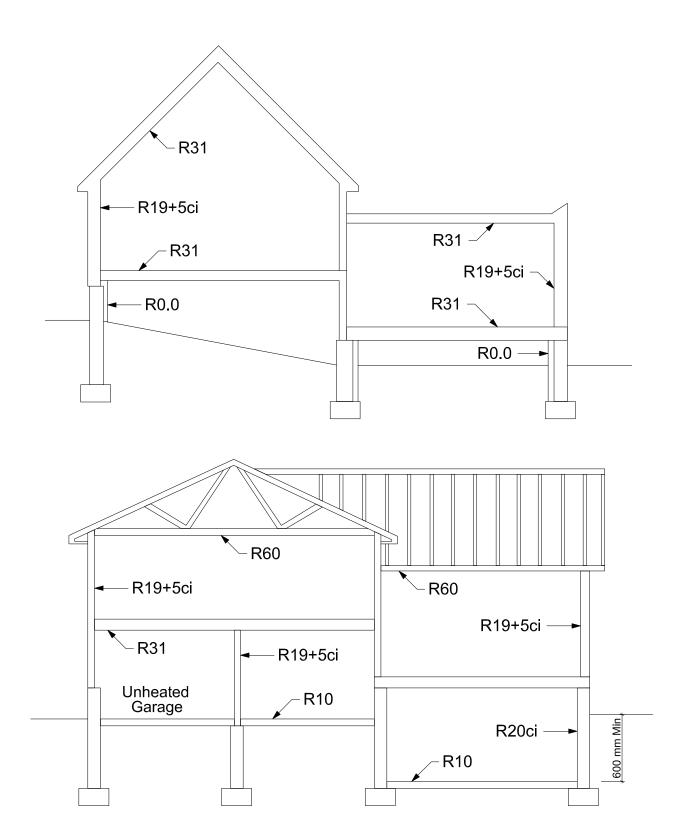


Table 3.1.1.11. (IP)
Thermal Performance Requirements for Additions to Existing Buildings(3)
Forming Part of Sentence 3.1.1.11.(2)

		Compliance Package			
Component	Thermal Values(7)	Zone 1	Zone 2	Electric Space Heating	
		Less than 5000 Degree Days	5000 or more Degree Days	Zones 1 and 2	
	Min. Nominal R(1)	60	60	60	
Ceiling with Attid	Max. U(2)	0.017	0.017	0.017	
Ораво	Min. Effective R(2)	59.22	59.22	59.22	
	Min. Nominal R(1)	31	31	31	
Ceiling Without Attic Space	Max. U(2)	0.036	0.036	0.036	
/ Killo Opaco	Min. Effective R(2)	27.65	27.65	27.65	
	Min. Nominal R(1)	31	31	31	
Exposed Floor	Max. U(3)	0.034	0.034	0.034	
	Min. Effective R(3)	29.80	29.80	29.80	
	Min. Nominal R(1)	19 + 5 ci	22 + 7.5 ci	22 + 10 ci	
Walls Above Grade	Max. U(3)	0.049	0.042	0.038	
Ciado	Min. Effective R(3)	20.32	23.90	26.40	
	Min. Nominal R(1)	20 ci	20 ci	20 ci	
Basement Walls(6)	Max. U(4)	0.047	0.047	0.047	
	Min. Effective R(4)	21.12	21.12	21.12	
Heated Slab or	Min. Nominal R(1)	10	10	10	
Slab ≤ 600 mm	Max. U(4)	0.090	0.090	0.090	
Below Grade	Min. Effective R(4)	11.13	11.13	11.13	
Edge of Below Grade Slab ≤ 600 mm Below Grade	Min. Nominal R(1)	10	10	10	
Windows and	Max. U(5)	0.28	0.25	0.25	
Sliding Glass Doors	Energy Rating	25	29	29	
Column 1	2	3	4	5	

Notes to Table 3.1.1.11:

- (1) The values listed are minimum Nominal R values for the thermal insulation component only.
- (2) U-Value and effective R value shall include entire ceiling assembly components, from interior air film to vented space air film above insulation.
- (3) U-Value and effective R value shall include entire exposed floor or above grade wall assembly components, from interior air film to exterior air film.
- (4) U-Value and effective R value shall include entire basement wall or slab assembly components and interior air film.
- (5) U-Value is the overall coefficient of heat transfer for a window assembly, sliding glass door assembly or skylight assembly expressed in Btu/(h•ft²•F).

 (6) In the case of basement wall assemblies, where R20 ci is required R12 + 10 ci is permitted to be used or vice versa; or where R12+ 5 ci is required, R15 ci is permitted to be used or vice versa.
- (7) Nominal and effective R values are expressed in (h•ft²•F)/Btu. U-Values are expressed in Btu/(h•ft²•F).



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Drawing No.

S-504

(1) EXCAVATION AND BACKFILL

- Excavation shall be undertaken in such a manner so as to prevent damage to existing structures, adjacent property and utilities
- The topsoil and vegetable matter in unexcavated areas under a building shall be removed. The bottom of excavations for foundations shall be free of all organic material
- If termites are known to exist, all stumps, roots and wood debris shall be removed to a minimum depth of 11 3/4"in excavated areas under a building, and the clearance between untreated structural wood elements and the ground shall be no less than $17 \ 3/4$ "
- Backfill within 23 5/8" of the foundation walls shall be free of deleterious debris and boulders over 9 7/8" in diameter

) DAMPPROOFING AND DRAINAGE

- In normal soil conditions, the exterior surfaces of foundation walls enclosing basements and crawl spaces shall be dampproofed. Where hydrostatic pressure occurs, a waterproofing system is
- Masonry foundation walls shall be parged with 1/4" of mortar coved over the footing prior to dampproofing
- 4" foundation drains shall be laid on level. undisturbed ground adjacent to the footings at or below the top of the basement slab or crawl space floor, and shall be covered with 6" of crushed stone. Foundation drains shall drain to a storm sewer, drainage ditch, dry well or sump
- Window wells shall be drained to the footing
- Downspouts not directly connected to a storm sewer shall have extensions to carry water away from the building, and provisions shall be made to prevent soil erosion
- Concrete slabs in attached garages shall be sloped to drain to the exterior
- The building site shall be graded so that surface, sump and roof drainage will not accumulate at or near the building and will not adversely affect adjacent properties

(3) FOOTINGS

- minimum 15 MPa poured concrete
- minimum 48" below finished grade
- Footings shall be founded on natural undisturbed soil, rock or compacted granular fill with minimum bearing capacity of 100 kPa

(4) FOOTING SIZE

Floors	Supporting	Supporting	Column
Supported	Ext. Wall	Int. Wall	Area
· · 1	9 7/8"	9 7/8"	4.3 ft2
2	13 3/4"	13 3/4"	8.1 ft2
3	17 3 [′] /4"	19 3′/4"	10.9 ft2

- Increase footing width by 2 5/8" for each storey of brick veneer supported, and by 5 1/8" for each storey of masonry
- The projection of an unreinforced footing beyond the wall supported shall not be greater than its thickness

(5) STEP FOOTINGS

 Vertical Rise 23 5/8"Max. for firm soils 15 3/4" Max. for sand or gravel Horizontal Run = 23.5/8"Min.

FOUNDATION WALLS

- To be poured concrete, unit masonry or preserved wood (see drawings for type and thickness)
- Dampproofing shall be a heavy coat of bituminous material.
- Foundation wall to extend minimum 5 7/8" above finished grade.
- A drainage layer is required on the outside of a foundation wall where the interior insulation extends more than 2'-11" below exterior grade. A drainage layer shall consist of
- Min. 3/4" mineral fibre insulation with min. Density of 3.6 lb/ft²
- Min. 4" of free drainage granular material,
- An approved system which provides equivalent performance
- Foundation walls shall be braced or have the floor joists installed before backfilling

CONCRETE FLOOR SLABS

- Garage, carport and exterior slabs and exterior steps shall be 4650psi concrete with 5-8%air entrainment
- Other slabs 3600psi concrete
- Minimum3" thick, placed on a minimum4" of coarse, clean, granular material
- All fill other than coarse clean material placed beneath concrete slabs shall be compacted to provide uniform support

(R) MASONRY WALLS

- Where constructed of 3 1/2"brick, wall shall be bonded with header course every 6th course
- Provide 2" solid masonry or continuous 1 1/2" plate under all roof and floor framing members
- Provide 7 1/2" solid masonry under beams and
- Masonry wall to be tied to each tier of joists with 1 9/16" x 3/16" corrosion resistant steel straps. kevéd minimum4" into masonry. When joists are parallel to wall, ties are to extend across at least 3 joists @ 6'-7" o.c.
- Inside back of wall to be parged and covered with No.15 breather-type asphalt paper
- For reduced foundation walls to allow a brick facing while maintaining lateral support, tie minimum 3 1/2" brick to minimum 3 1/2" backup block with corrosion resistant ties at least 0.028in ² in cross sectional area, spaced 7 7/8" vertically and 2'-11"horizontally, with joints completely filled with mortar
- Masonry over openings shall be supported on corrosion resistant or prime painted steel lintels with a minimum of 5 7/8" end bearing

(G) MASONRY VENEER

- Minimum2 3/4" thick if joints are not raked and 3 1/2"thick if joints are raked
- Minimum1" air space to sheathina
- Provide weep holes @ 31 1/2" o.at the bottom of the cavity and over doors and windows
- Direct drainage through weep holes with 20 mil poly flashing extending minimum 5 7/8" up behind the sheathing paper
- Veneer ties minimum 0.030" thick x 7/8" wide corrosion resistant straps spaced @ 23 5/8 vertically and 15 3/4" horizontally
- Fasten ties with corrosion resistant 0.125" diameter screws or spiral nails which penetrate at least 1-3/16 into studs

WOOD FRAME CONSTRUCTION

- All lumber shall be spruce-pine-fir No. 1 &2, and shall be identified by a grade stamp
- Maximum moisture content19% at time of
- Wood framing members which are supported on concrete in direct contact with soil shall be separated from the concrete with 6 mil polyethylene

(11) WALLS

- Exterior walls shall consist of:
- cladding
- sheathing paper lapped 4"at joints
- 3/8" fibreboard or gypsum board or 1/4" plywood sheathing
- 2x6 studs @16" o.c.
- 2x6 bottom plate and double 2x6 top plate
- 2x4 studs @16"o.c. can be utilized provided the combined R value of the batt insulation and exterior rigid insulation achieves R-17.
- Interior loadbearing walls shall consist of:
- 2x4 studs @16" o.c.
- 2x4 bottom plate and double 2x4 top plate
- 2x4 mid-airts if not sheathed
- 1/2" gypsum board sheathing

- See S04 for floor joist size and spacing requirements
- Joists to have minimum 1 1/2" of end bearing
- Joists shall bear on a sill plate fixed to foundation with 1/2"anchor bolts @ 7' 10" o.c
- Header joists between 3' 11"and 10' 6" in length shall be doubled. Header joists exceeding 10' 6" shall be sized by calculations
- Trimmer joists shall be doubled when supported header is between 2' 7" and 6' 7". Trimmer joists shall be sized by calculations when supported header exceeds 6'7"
- 2x2 cross bridging required not more than 6'11" from each support and from other rows of bridging
- Joists shall be supported on joist hangers at all flush beams, trimmers, and headers.
- Joists located under parallel non-loadbearing partitions shall be doubled
- See S04 for subflooring requirements

(13) ROOF AND CEILINGS

- See S04 for rafter, roof joist and ceiling joist size and spacing requirements
- Hip and valley rafter shall be 2" deeper than common rafters
- 2x4 collar ties @ rafter spacing with 1x4 continuous brace at mid span if collar tie exceeds
- See S04 for roof sheathing requirements

(14) NOTCHING & DRILLING OF TRUSSES, JOISTS, RAFTERS

- Holes in floor, roof and ceiling members to be maximum 1/4 x actual depth of member and not less than 2" from edges
- Notches in floor, roof and ceiling members to be located on top of the member within 1/2 the actual depth from the edge of bearing and not greater than 1/3 joist depth
- Wall studs may be notched or drilled provided that no less than 2/3 the depth of the stud remains, if load bearing, and 1 9/16 if non-load
- Pagwedkened unless accommodated in the design

(15) ROOFING

- Fasteners for roofing shall be corrosion resistant. Roofing nails shall penetrate through or at least 1/2" into roof sheathing
- Every asphalt shingle shall be fastened with at least 4 nails
- Eave protection shall extend 2' 11"up the roof slope from the edge, and at least 11 3/4 rom the inside face of the exterior wall, and shall consist of Type M or Type S Roll Roofing laid with minimun4" head and end laps cemented together, or glass Fibre or Polyester Fibre coated base sheets, or self sealing composite membranes consisting of modified bituminous coated material. Eave protection is not required for unheated buildings, for roofs exceeding a slope of 1 in 1.5or where a low slope asphalt shingle application is provided
- Open valleys shall be flashed with 2 layers of roll roofing, or 1 layer of sheet metal min. 23 5/8" wide
- Flashing shall be provided at the intersection of shingle roofs with exterior walls and chimneys
- Sheet metal flashing shall consist of not less than 1/16"sheet lead, 0.013" galvanized steel, 0.018" copper, 0.018" zinc, or 0.019" aluminum

(16) COLUMBS, BEAMS & LINTELS

- Steel beams and columns shall be shop primed.
- Minimum 3 1/2" end bearing for wood and steel beams, with 7 7/8" solid masonry beneath the
- Steel columns to have minimum outside diameter of 2.7/8" and minimum wall thickness of 3/16'
- Wood columns for carports and garages shall be minimum $3 \frac{1}{2}$ " x $3 \frac{1}{2}$ "; in all other cases either $5 \frac{1}{2}$ " x $5 \frac{1}{2}$ " $7 \frac{1}{4}$ " round, unless calculations based on actual loads show lesser sizes are adequate. All columns shall be not less than the width of the supported member
- Masonry columns shall be a minimum of 1 3/8" x 11 3/8°r 9 1/2" x 15"
- Provide solid blocking the full width of the supported member under all concentrated loads

(17) INSULATION & WEATHERPROOFING

Ceiling with attic	R-60
Ceiling without attic space	R-31
Exposed Floor	R-31
Walls above Grade	R-19+5ci
Basement Walls	R-20ci
Heated Slab or Slab< 600 mm Below Grade	R-10
Edge of Below Grade Slab < 600 mm Below Grade	R-10

Supply Ducts in unheated space R-20


- Insulation shall be protected with gypsum board or an equivalent interior finish, except for unfinished basements where 6 mil poly is sufficient for fibreglass type insulations
- Ducts passing through unheated space shall be made airtight with tape or sealant
- Caulking shall be provided for all exterior doors and windows between the frame and the exterior
- Weatherstripping shall be provided on all doors and access hatches to the exterior, except doors from a garage to the exterior
- Exterior walls, ceilings and floors shall be constructed so as to provide a continuous barrier to the passage of water vapour from the interior and to the leakage of air from the exterior



DESIGN, DELIVER, INNOVATE,

TBM Engineers Inc.

15 Javlvnn Crt. Woodbridge, ON (905) 893-9070 www.tbmengineers.com tbmengineers@mail.com

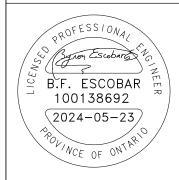

Project Address: 14 TIMBER LANE **OAKVILLE ON L6L 2Z3**

Addition to Detached Dwelling

Issued for: 2024-05-23 Building Permit

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Scale: $\frac{3}{16}$ " = 1'-0" (1:64)

Drawing No.

S-505

29 of 30

(18) NATURAL VENTILATION

- Every roof space above an insulated ceiling shall
 be ventilated with unobstructed openings equal to not less than 1/300 of insulated area
- Insulated roof spaces not incorporating an attic shall be ventilated with unobstructed openings equal to not less than 1/150of insulated area.
- Roof vents shall be uniformly distributed and designed to prevent the entry of rain, snow or insects
- Unheated crawl spaces shall be provided with 1.1 ft of ventilation for each 5382 ft
- Minimum natural ventilation areas, where mechanical ventilation is not provided, are:
 Bathrooms: 0.97 ft²
 other rooms: 3 ft²
 Unfinished basement: 0.2% of floor area

(19) DOORS AND WINDOWS

- Every floor level containing a bedroom and not served by an exterior door shall contain at least 1 window having an unobstructed open area of 3.8 ft2 and no dimension less than 15", which is openable from the inside without tools
- Exterior house doors and windows within 6' 7" from grade shall be constructed to resist forced entry. Doors shall have a deadbolt lock
- The principal entry door shall have either a door viewer, transparent glazing or a sidelight

20 EXTERIOR WALLS

- No windows or other unprotected openings are permitted in exterior walls less than 3' 11" from property lines
- 5/8" fire rated drywall shall be installed on the inside face of attached garage exterior walls and gable ends of roofs which are less than 3' 11" from property lines
- Non combustible cladding shall be installed on all exterior walls less than 23 5/8" from property lines

(21) CERAMIC TILE

When ceramic tile applied to a mortar bed with adhesive, the bed shall be a minimum of1/2" thick & reinforced with galvanized diamond mesh lath, applied over polyethylene on subflooring on joists at no more than 16"o.c. with at least 2 rows cross bridging

22 ACCESS TO ATTICS AND CRAWL SPACES

• Access hatch minimum 19 3/4"x 2' 4"to be provided to every crawl space and every roof space which is 108 ft² or more in area and more than 23 5/8"in height

GARAGE GASPROOFING

- The walls and ceiling of an attached garage shall be constructed and sealed so as to provide an effective barrier to exhaust fumes
- All plumbing and other penetrations through the walls and ceiling shall be caulked
- Doors between the dwelling and attached garage may not open into a bedroom and shall be weatherstripped and have a self-closer

24) ALARMS AND DETECTORS

- At least one smoke alarm shall be installed on or near the ceiling on each floor and basement level 2' 11" or more above an adjacent level
- Smoke alarms shall be interconnected and located such that one is within 16' 5"of every bedroom door and no more than 49' 3" travel distance from any point on a floor
- A carbon monoxide detector shall be installed on or near the ceiling in every room containing a solid fuel burning fireplace or stove

25 STAIRS

Maximum Rise
Minimum Run
Maximum Run
Maximum Run
10"
Maximum Run
14"

Minimum Head Room
Minimum Width
2' 10"

- Curved stairs shall have a min. run of 5 7/8"at any point and a minimum average run of 7 7/8"
- Winders which converge to a point in stairs must turn through an angle of no more than90°, with no less than 30° or more than 45° per tread. Sets of winders must be separated by 3' 11" along the run of the stair
- A landing minimum2' 11" in length is required at the top of any stair leading to the principal entrance to a dwelling, and other entrances with more than 3 risers
- Exterior concrete stairs with more than 2 risers require foundations

26 HANDRAILS AND GUARDS

- A handrail is required for interior stairs containing more than 2 risers and exterior stairs containing more than 3 risers
- Guards are required around every accessible surface which is more than 23 5/8" above the adjacent level
- Interior and exterior guards min. 2' 11" high.
 Exterior guards shall be 3' 6" high where height above adjacent surface exceeds 5' 11"
- Guards shall have no openings greater than 4," and no member between 4" and 2' 11" that will facilitate climbing

27) PLUMBING

- Every dwelling requires a kitchen sink, lavatory, water closet, bathtub or shower stall and the installation or availability of laundry facilities
- A floor drain shall be installed in the basement, and connected to the sanitary sewer where gravity drainage is possible. In other cases, it shall be connected to a storm drainage system, ditch or dry well

28 ELECTRICAL

- An exterior light controlled by an interior switch is required at every entrance
- A light controlled by a switch is required in every kitchen, bedroom, living room, utility room, laundry room, dining room, bathroom, vestibule, hallway, garage and carport. A switched receptacle may be provided instead of a light in bedrooms and living rooms
- Stairs shall be lighted, and except where serving an unfinished basement shall be controlled by a 3 way switch at the head and foot of the stairs
- Basements require a light for each 323 ft², controlled by a switch at the head of the stairs

29 MECHANICAL VENTILATION

- A mechanical ventilation system is required with a total capacity at least equal to the sum of:
- 10 cfm each for basement and master bedroom
 5 cfm for each other room
- A principal dwelling exhaust fan shall be installed and controlled by a centrally located switch identified as such
- Supplemental exhaust shall be installed so that the total capacity of all kitchen, bathroom and other exhausts, less the principal exhaust, is not less than the total required capacity
- A Heat Recovery Ventilator may be employed in lieu of exhaust to provide ventilation. An HRV is required if any solid fuel burning appliances are installed
- Supply air intakes shall be located so as to avoid contamination from exhaust outlets

Table 3.1.1.11.(SI) - Thermal Performance Requirements for Additions to Existing Buildings

Component	Zo	ne 1
Ceiling with Attic Space Minimun RSI(R)-Value(1)	10.56	(R60)
Ceiling without Attic Space Minimum RSI (R) - Value(1)	5.46	(R31)
Exposed Floor Minimum RSI (R) - Value(1)	5.46	(R31)
Walls above Grade Minimum RSI (R) - Value(1)		0.88ci)+5ci)
Basement Walls Minimum RSI (R) - Value(1)	3.52 ci	(R20 ci)
Below Grade Slab Below Grade Minimum RSI (R) - Value(1)		-
Heated Slab or Slab <= 600 MM Below Grade Minimum RSI (R) - Value(1)	1.76	(R10)
Edge of Below Grade Slab <= 600 mm Below Grade Minimum RSI (R) - Value(1)	1.76	(R10)
Windows and Sliding Glass Doors Maximum U-Value(2)	1.6	0.28
Column 1	;	3



DESIGN. DELIVER. INNOVATE.

TBM Engineers Inc.

15 Jaylynn Crt. Woodbridge, ON (905) 893-9070 www.tbmengineers.com tbmengineers@mail.com



Project Address: 14 TIMBER LANE OAKVILLE ON L6L 2Z3

Addition to Detached Dwelling

Date Issued for: 2024-05-23 Building Permit

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Scale:

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Drawing No.

S-506

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SB= Wood Solid Bearing, Minimum 3-2"x6" SPF. Width or diameter of wood column shall be not less than the width of the supported member

PLA= Point Load Above

L1= 2-2"x10" SPF L2= 2-1³/₄"x9¹/₄" 3100 Fb-2.0E LVL

B2= $2-1\frac{3}{4}$ "x11 $\frac{7}{8}$ " 3100 Fb-2.0E LVL B3= $3-1\frac{3}{4}$ "x11 $\frac{7}{8}$ " 3100 Fb-2.0E LVL

J1= 91/2" s31 @16" TJI joists


C1=6"x6" PT post C2= 4"x4"x1/4" HSS square post with 8"x8"x1/2" bottom plate

LDB= 2-2"x8" PT ledger board with (2)-1/2"Ø@32" o.c. anchor bolts into foundation wall.


P1= 12"Ø concrete pier, 48" below grade

F1=48"x48"x12" concrete footing pad with 15M@6" bottom rebar each way, min 3" concrete cover

FDN1= 10" poured concrete (25 MPa) 15@16" horizontal and vertical on 20"x6" concrete strip footing with 3-15M longitudinal rebar

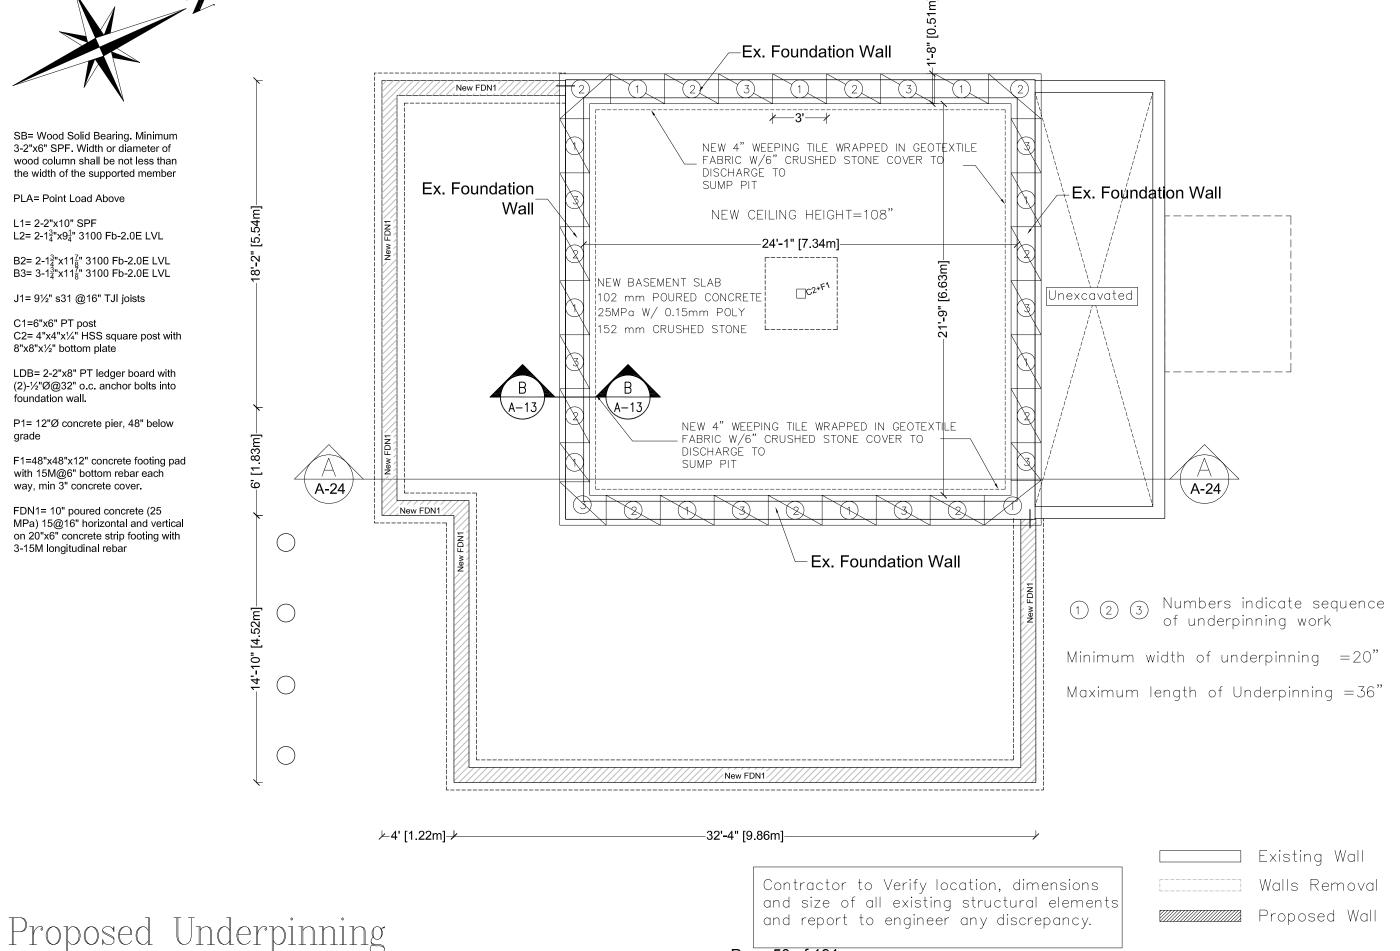

Page 50 of 191

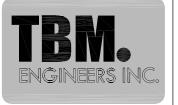

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Project Address 14 TIMBER LANE **OAKVILLE ON L6L 2Z3**

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Scale:


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Drawing No.


12 of 30

NOTES

- (1) VERIFY/REINFORCE EXISTING SUPPORT SYSTEM, INCLUDING FOUNDATIONS, FOR LOADS IMPOSED BY THE PROPOSED CONSTRUCTION.
- (2) ALL MEMBERS SHALL BE SO FRAMED, FASTENED, TIED, BRACED AND ANCHORED TO PROVIDE THE NECESSARY STRENGTH RIGIDITY AND STABILITY PER OBC 9.23.2.1 (3) PROVIDE ALL BRACING, SHORING AND NEEDLING NECESSARY FOR THE SAFE EXECUTION OF THIS WORK
- (4) VERIFY FOUNDATION WALL PROPERTIES, FRAMING AND LOADING DATA FOR COMPLIANCE WITH 9.15.4, OTHERWISE REINFORCE WALLS AS NECESSARY.
- (5) PRIOR TO UNDERPINNING, INSPECTOR TO VERIFY EXISTING FOUNDATION AND FOOTING
- (6) EXCAVATION FOR THE PROPOSED WORK SHOULD NOT UNDERMINE THE FOUNDATION OF ADJOINING BUILDING, OR CAUSE DAMAGE TO UTILITIES, ROADS AND SIDE WALKS. OBC DIV. C 1.2.1.2 AND 9.12.1.4.

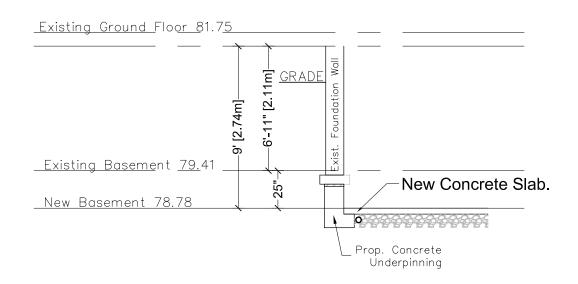


SECTION B - B

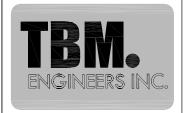

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TBM Engineers Inc.

15 Jaylynn Crt. Woodbridge, ON (905) 893-9070 www.tbmengineers.com byrone@tbmengineers.com

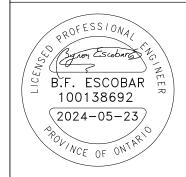

Project Address: 14 TIMBER LANE OAKVILLE ON L6L 2Z3

Addition to Detached Dwelling

Date Issued for: 2024-05-23 Building Permit


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Scale: 1:75

Drawing No.

U-402

13 of 30

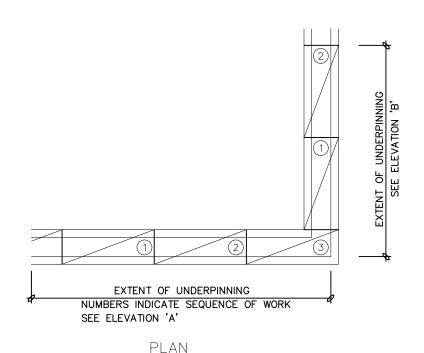

EXISTING

STAGE 1

______1200mm_MAX.

TYPICAL

ELEVATION 'A'

FOUNDATION WALL

EXISTING FOOTING

STAGE 2

1200mm MAX.

TYPICAL


STAGE 3

POURED CONCRETE


GENERAL NOTES

- 1. WHERE THE FOUNDATIONS OF A BUILDING ARE TO BE CONSTRUCTED BELOW THE LEVEL OF THE FOOTINGS OF AN ADJACENT BUILDING & WITHIN THE ANGLE OF REPOSE OF THE SOIL, OR THE UNDERPINNING EXCEEDS 1200 mm OF LATERALLY UNSUPPORTED HEIGHT OR THE SOIL IS CLAY OR SILT, THE UNDERPINNING & RELATED CONSTRUCTION SHALL DE DESIGNED BY A PROFESSIONAL ENGINEER
- 2. EXCAVATION SHALL BE UNDERTAKEN IN A MANNER SO
 AS TO PREVENT MOVEMENT WHICH WOULD CAUSE
 DAMAGE TO ADJACENT PROPERTY, STRUCTURES, UTILITIES,
 ROADS & SIDEWALKS. CONTACT LOCAL UTILITIES PRIOR TO
 COMMENCING EXCAVATION.
- 3. MINIMUM CONCRETE STRENGTH FOR UNDERPINNING SHALL BE 15MPa AT 28 DAYS. ALL EXTERIOR CONCRETE SHALL BE 32MPa W/ 5%-8% AIR ENTRAINMENT.


- 4. CONCRETE SHALL BE CURED MINIMUM 48 HOURS BEFORE GROUTING AND PROCEEDING TO THE NEXT STAGE.
- 5. SHORE & BRACE WHERE NECESSARY TO ENSURE THE SAFETY & STABILITY OF THE EXISTING STRUCTURE DURING UNDERPINNING.
- 6. WEEPING TILE IS TO DRAIN TO THE STORM SEWER, DITCH, DRYWELL OR INSTALL COVERED SUMP PIT WITH AN AN AUTOMATIC PUMP.

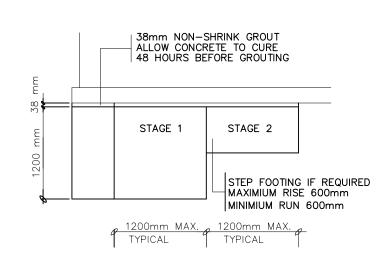

ELEVATION 'B'

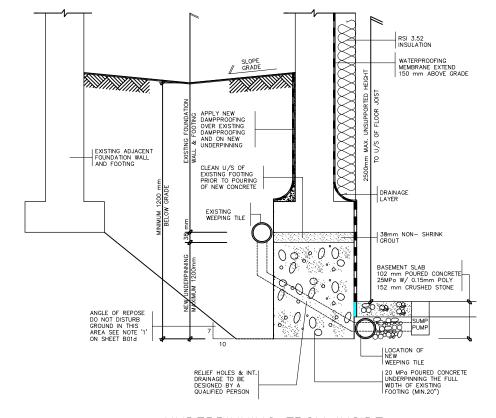


UNDERPINNING FROM INSIDE

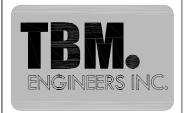

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TBM Engineers Inc.

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Project Address: 14 TIMBER LANE OAKVILLE ON L6L 2Z3

Addition to Detached Dwelling
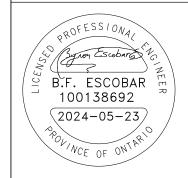
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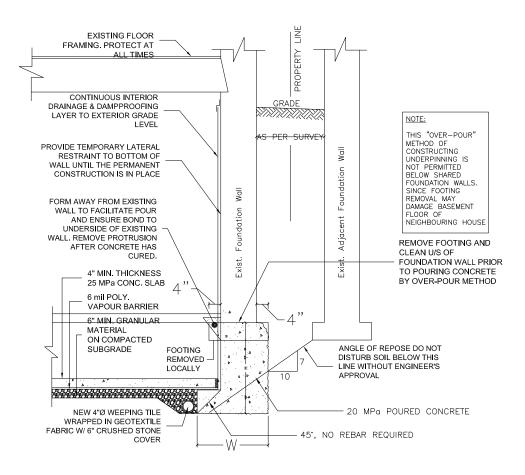
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Drawing No.

U-403

14 of 30

Underpinning – GROUTING METHOD – Typical Details



NOTES:


- 1. THIS IS A "TYPICAL" DETAIL ONLY WHICH MAY BE SUPERSEDED BY DESIGN SPECIFIC INFORMATION SHOWN ON THE DRAWINGS.
- 2. MAX. LENGTH OF UNDERPINNING SECTIONS SHALL NOT EXCEED 48" AND PERFORMED IN A SEQUENTIAL ORDER AS SHOWN ON THE DESIGN DRAWINGS. UNDERPINNING CONCRETE SHALL CURE MIN. 48 HOURS BEFORE PROCEEDING TO THE NEXT STAGE.
- 3. CONTRACTOR SHALL BE RESPONSIBLE FOR CARRYING OUT ALL UTILITY LOCATES PRIOR TO CARRYING OUT ANY EXCAVATION WORK. "CALL BEFORE YOU DIG".
- 4. THE BOTTOM OF EVERY EXCAVATION SHALL BE FREE FROM ORGANIC MATERIAL
- 5. EXCAVATION SHALL BE KEPT FREE FROM STANDING WATER.
- 6. THE CONTRACTOR IS RESPONSIBLE FOR UNDERTAKING THE EXCAVATION IN SUCH A MANNER TO PREVENT DAMAGE TO ADJACENT PROPERTY, EXISTING STRUCTURES, UTILITIES, ROADS AND SIDEWALKS AT ALL STAGES OF CONSTRUCTION.
- 7. THE CONTRACTOR IS RESPONSIBLE FOR SHORING AND BRACING THE WORK DURING CONSTRUCTION.
- 8. H/W SHALL NOT BE MORE THAN 2.0 AND W SHALL MATCH EXISTING FOOTING WIDTH OR BE NOT LESS THAN 20", WHICHEVER IS GREATER



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TBM Engineers Inc.

15 Jaylynn Crt. Woodbridge, ON (905) 893-9070 www.tbmengineers.com byrone@tbmengineers.com

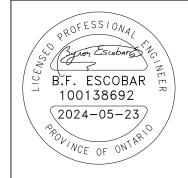

Project Address: 14 TIMBER LANE OAKVILLE ON L6L 2Z3

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Scale: 1:75

Drawing No.

U-404

15 of 30

Underpinning – OVERPOUR METHOD – Typical Details



Planning & Regulations 905.336.1158 2596 Britannia Road West Burlington, Ontario L/P 0G3 conservationhalton.ca

September 5, 2024

Dan Aitken 14 Timber Lane Oakville, ON L6L 2Z3

BY EMAIL ONLY (daitken5@ford.com)

To Dan Aitken:

Re: Construction of an addition and foundation underpinning of a two-storey dwelling within

the erosion hazard associated with the shoreline of Lake Ontario.

14 Timber Lane Town of Oakville CH File: RAPP-9348

Proposals

Please find enclosed **Permit No. 8996** issued in accordance with the *Conservation Authorities Act* and Ontario Regulation 41/24, for the above noted proposal.

Staff have reviewed the following files regarding the above noted proposal:

Addition to Detached Dwelling, Drawings A-02, A-03, A-12, A-13, and A-16-A-23, prepared by TBM Engineers Inc., received July 10, 2024, stamped approved September 5, 2024.

Conservation Halton (CH) regulates all watercourses, valleylands, wetlands, Lake Ontario Shoreline, hazardous lands including unstable soil and bedrock, as well as lands adjacent to these features. The property, 14 Timber Lane, Oakville, is adjacent to the shoreline of Lake Ontario. Through the review of the plans for development activities along the shoreline, CH seeks to ensure that waterfront development activity will generally be directed to areas outside of the hazardous lands. Hazardous lands are those lands adjacent to the shoreline of the Great Lakes - St. Lawrence River System, which are impacted by flooding, erosion, and/or dynamic beach hazards, as well as applicable regulated allowances. The combination of these hazardous lands delineates the extent of the development setback and is determined on-site specific conditions. Permission is required from CH prior to undertaking development activities within CH's regulated area and applications are reviewed under the *Conservation Authorities Act*, Ontario Regulation 41/24 and CH's Regulatory Policies and Guidelines.

The approved work involves the construction and an addition and underpinning the foundation of a dwelling located that is within the erosion hazard associated with the shoreline of Lake Ontario but beyond the development setback. The development activity meets Policy 2.38.1.2 of CH's Regulatory Policies and Guidelines.

Based on the above, this permit is approved with the following conditions:

- a. That CH be contacted immediately should any changes to the scope or timing of works, or details as identified on the stamped approved drawings be proposed. Note: Further review or additional information may be required to support changes.
- b. That disturbed areas be stabilized immediately following the completion of construction.
- c. That effective sediment and erosion control measures be installed prior to starting work, maintained during construction and fully removed once all disturbed areas have been stabilized. That site conditions be monitored and that the sediment and erosion control measures be modified if site conditions warrant it.
- d. That excess fill (soil or otherwise) generated from the proposed works shall not be stockpiled or disposed of within any area regulated by CH.

Please be sure that you read and understand all conditions listed on the enclosed Permit (and included below). Please also note that contravention of a Permit, or the terms and conditions of a Permit, is considered an offence under Section 28.0.1(28) of the *Conservation Authorities Act*. It is your responsibility to ensure that any person working under the authority of this Permit is familiar, and complies with, the terms and conditions.

Conservation Halton must be contacted a minimum of 48 hours prior to commencement of construction. This Permit or a copy thereof as well as all approved drawings must be available at the site. Any changes to the approved design or installation methods must be reviewed and approved by Conservation Halton staff prior to implementation. This Permit is valid two years from the dated it is issued.

Please be advised that should you have any objection to any of the conditions of the permit, you are entitled to request a hearing before the Authority, in accordance with Section 28.1(5) of the *Conservation Authorities Act*. A written notice of your request for a hearing must be received by staff within 30 days of the date of this letter. Please note that if a hearing has been requested, this permit approval is withdrawn until such time as the hearing results have been finalized and commencement of any site alteration must not occur until the results of the Hearing are determined.

If you require additional information, please contact the undersigned at <u>aheizer@hrca.on.ca</u>.

Regards,

Adam Heizer Regulations Officer

Encl. 2

Cc: Town of Oakville, Building Department (<u>buildingrequests@oakville.ca</u>)
Tatiana Quintana, TBM Engineers Inc. (tatianaq@tbmengineers.com)



2596 Britannia Road West **Burlington, ON L7P 0G3** Telephone: 905 336-1158

PERMIT #: 8996

FILE #: RAPP-9348

PERMIT

IN ACCORDANCE WITH PART VI OF THE CONSERVATION AUTHORITIES ACT AND ONTA	RIO
REGULATION 41/24, THIS PERMIT HAS BEEN GRANTED TO:	

Owner's Name:

Dan Aitken

Phone: 289-681-7584

Mailing Address:

14 Timber Lane, Oakville ON L6L 2Z3

Agent/Contractor: TBM Engineers Inc.

Phone: 647-992-9070

15 Jaylynn Court, Vaughan ON L4H 1Z6

Property Location: 14 Timber Lane

in the (City, Town, Township) of: Oakville

(Region/County) of: Halton

This permit is for the construction of an addition and foundation underpinning of a two-storey dwelling within the erosion hazard associated with the shoreline of Lake Ontario.

This permit is issued on this 5th day of September, 2024

Expires: 5th day of September, 2026

And is subject to the following conditions:

- 1. That the work to be carried out in accordance with plans submitted on July 10, 2024 and stamped APPROVED by: Adam Heizer, Regulations Officer
- 2. see reverse
- 3. This permit (including drawings stamped approved by Conservation Halton) or a copy thereof, must be on site and available for inspection.

In accordance with Section 28.3 of the Conservation Authorities Act, Conservation Halton may cancel a permit issued under Section 28.1 if it is of the opinion that the conditions of the permit have not been met or that the circumstances that are prescribed by regulation exist. Before cancelling a permit, Conservation Halton shall give notice of intent to cancel the permit and the permit holder may request a hearing.

Authorized representatives of Conservation Halton may, at any time, enter lands to make any surveys, examinations, investigations, and inspections to ensure that the works authorized by this permit are being carried out in accordance with the terms of this permit.


This permit does not preclude any approvals required by any other existing law and regulations.

Authorized by: _ Millie M Cormacle on the 5th day of September 2024 Kellie McCormack, MA, MCIP, RPP, Director, Planning and Regulations

2.

- a. That CH be contacted immediately should any changes to the scope or timing of works, or details as identified on the stamped approved drawings, be proposed. Note: Further review or additional information may be required to support changes;
- b. That disturbed areas be stabilized immediately following the completion of construction;
- c. That effective sediment and erosion control measures be installed prior to starting work, maintained during construction and fully removed once all disturbed areas have been stabilized. That site conditions be monitored and that the sediment and erosion control measures be modified if site conditions warrant it; and
- d. That excess fill (soil or otherwise) generated from the proposed works shall not be stockpiled or disposed of within any area regulated by Conservation Halton, unless in conformance as per the approved plans.

Page 57 of 191

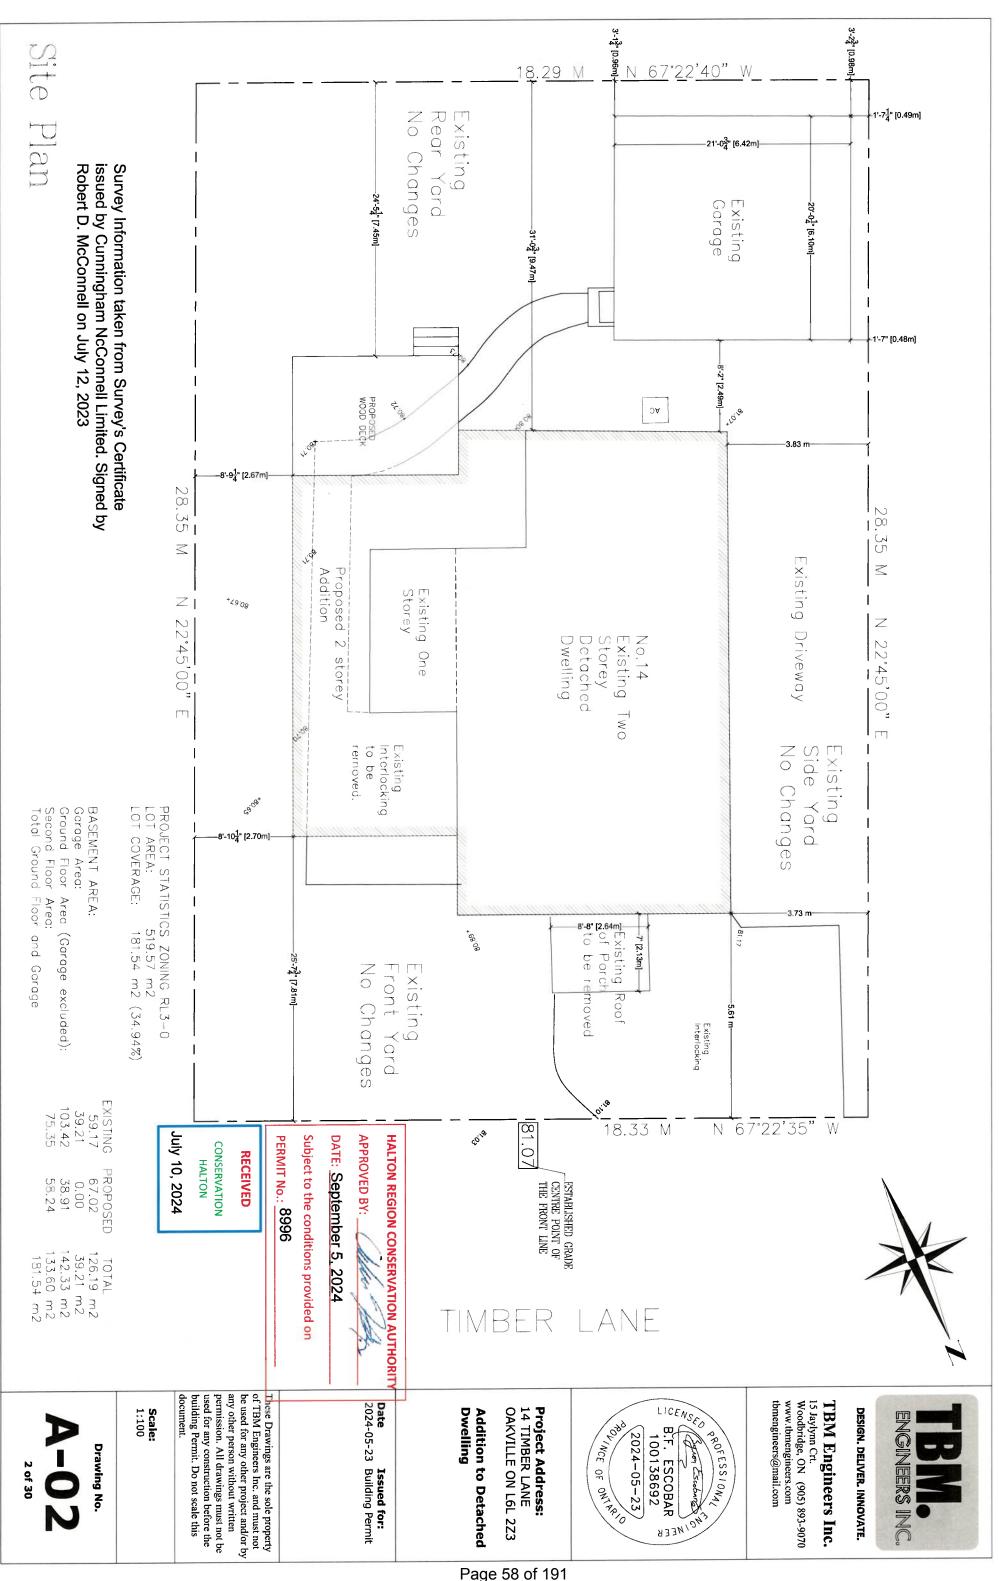


Page 58 of 191

Total GF area

= 142.33 m2

Total SF area

133.60 m2

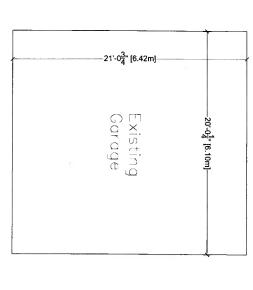

DATE: September 5, 2024 APPROVED BY: HALTON REGION CONSERVATION AUTHORITY

PERMIT No.: 8996 Subject to the conditions provided on

RECEIVED

July 10, 2024




Exist. GF area =

103.42 m2





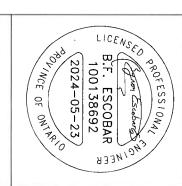

Project Address:14 TIMBER LANE
OAKVILLE ON L6L 2Z3

Dwelling **Addition to Detached**

Date Issued for: 2024-05-23 Building Permit

These Drawings are the sole property of TBM Engineers Inc. and must not be used for any other project and/or by any other person without written permission. All drawings must not be used for any construction before the building Permit. Do not scale this

document.

Scale: 1:100

Drawing No. 3 of 30


Page 59 of 191



DESIGN. DELIVER. INNOVATE.

15 Jaylynn Crt. Woodbridge, ON (905) 893-9070 www.tbmengineers.com tbmengineers@mail.com

TBM Engineers Inc.

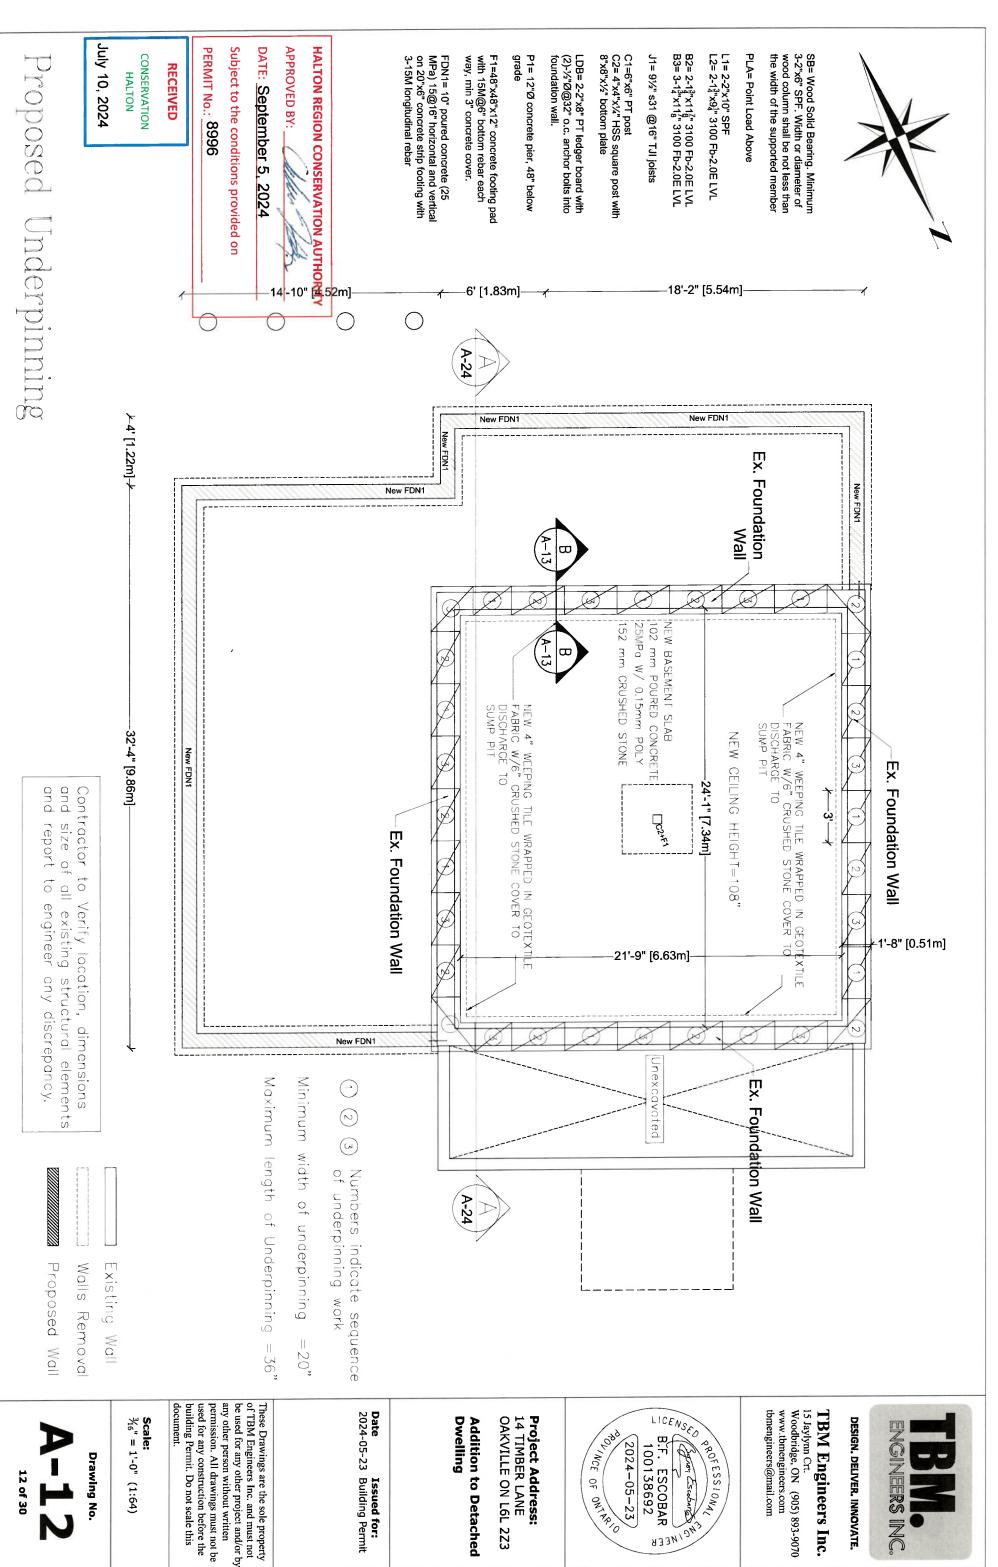

Page 60 of 191

Underpinning - Specifications


(1) VERIFY/REINFORCE EXISTING SUPPORT SYSTEM, INCLUDING FOUNDATIONS, FOR LOADS IMPOSED BY THE PROPOSED CONSTRUCTION.

(2) ALL MEMBERS SHALL BE SO FRAMED, FASTENED, TIED, BRACED AND ANCHORED TO PROVIDE THE NECESSARY STRENGTH RIGIDITY AND STABILITY PER OBC 9.23.2.1

(3) PROVIDE ALL BRACING, SHORING AND NEEDLING NECESSARY FOR THE SAFE EXECUTION OF THIS WORK

(4) VERIFY FOUNDATION WALL PROPERTIES,
FRAMING AND LOADING DATA FOR
COMPLIANCE WITH 9.15.4, OTHERWISE
REINFORCE WALLS AS NECESSARY.

(5) PRIOR TO UNDERPINNING, INSPECTOR
TO VERIFY EXISTING FOUNDATION AND (6) EXCAVATION FOR THE PROPOSED WORK SHOULD NOT UNDERMINE THE FOUNDATION OF ADJOINING BUILDING, OR CAUSE DAMAGE TO UTILITIES, ROADS AND SIDE WALKS. OBC DIV. C 1.2.1.2 AND 9.12.1.4.

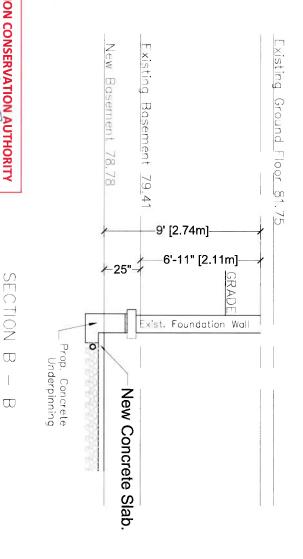

DATE: September 5, 2024 HALTON REGION CONSERVATION AUTHORITY APPROVED BY:

CONSERVATION RECEIVED

HALTON

PERMIT No.: 8996

Subject to the conditions provided on

July 10, 2024

SECTION \Box

Date 2024-05-23 Issued for:
Building Permit

These Drawings are the sole property of TBM Engineers Inc. and must not be used for any other project and/or by permission. All drawings must not be used for any construction before the building Permit. Do not scale this any other person without written

Drawing No.

Scale: 1:75

13 of 30

Addition to Detached

Dwelling

Project Address:14 TIMBER LANE
OAKVILLE ON L6L 2Z3

LICENSED

ENCINEER

PROFESSIONAL

OLINCE OF ONTERIO

2024-05-23/

3.F. ESCOBAR 100138692


www.tbmengineers.com byrone@tbmengineers.com Woodbridge, ON (905) 893-9070


15 Jaylynn Crt


TBM Engineers Inc.

DESIGN. DELIVER. INNOVATE.

TEERS INC.

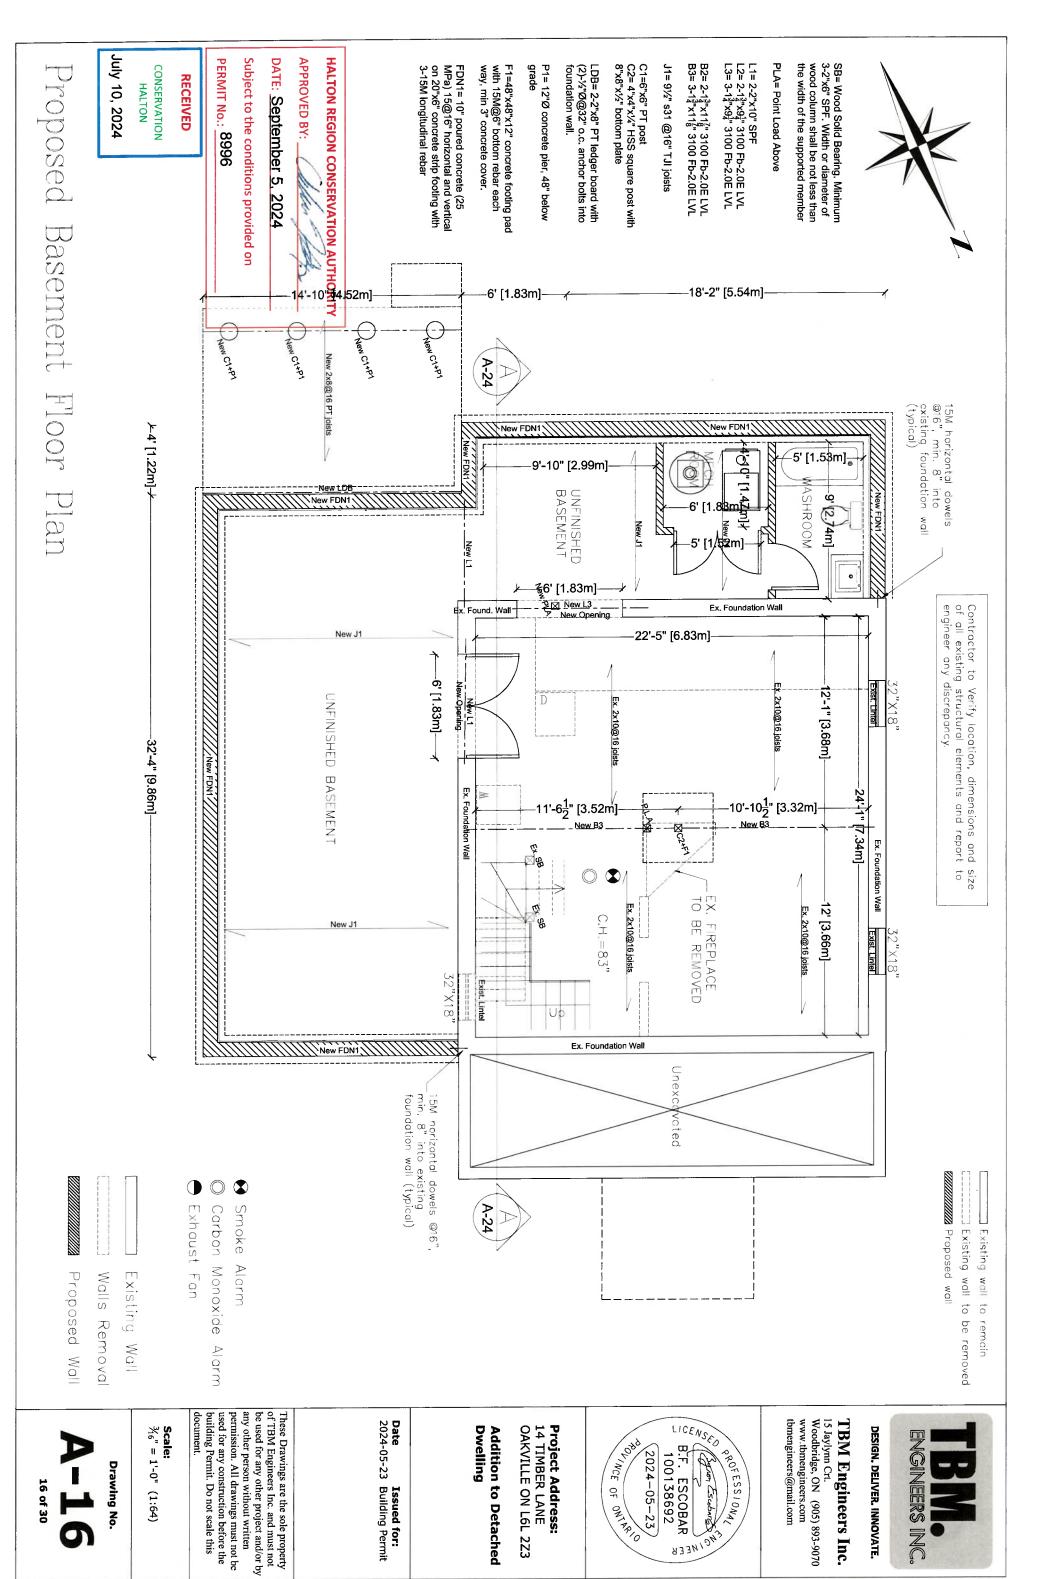

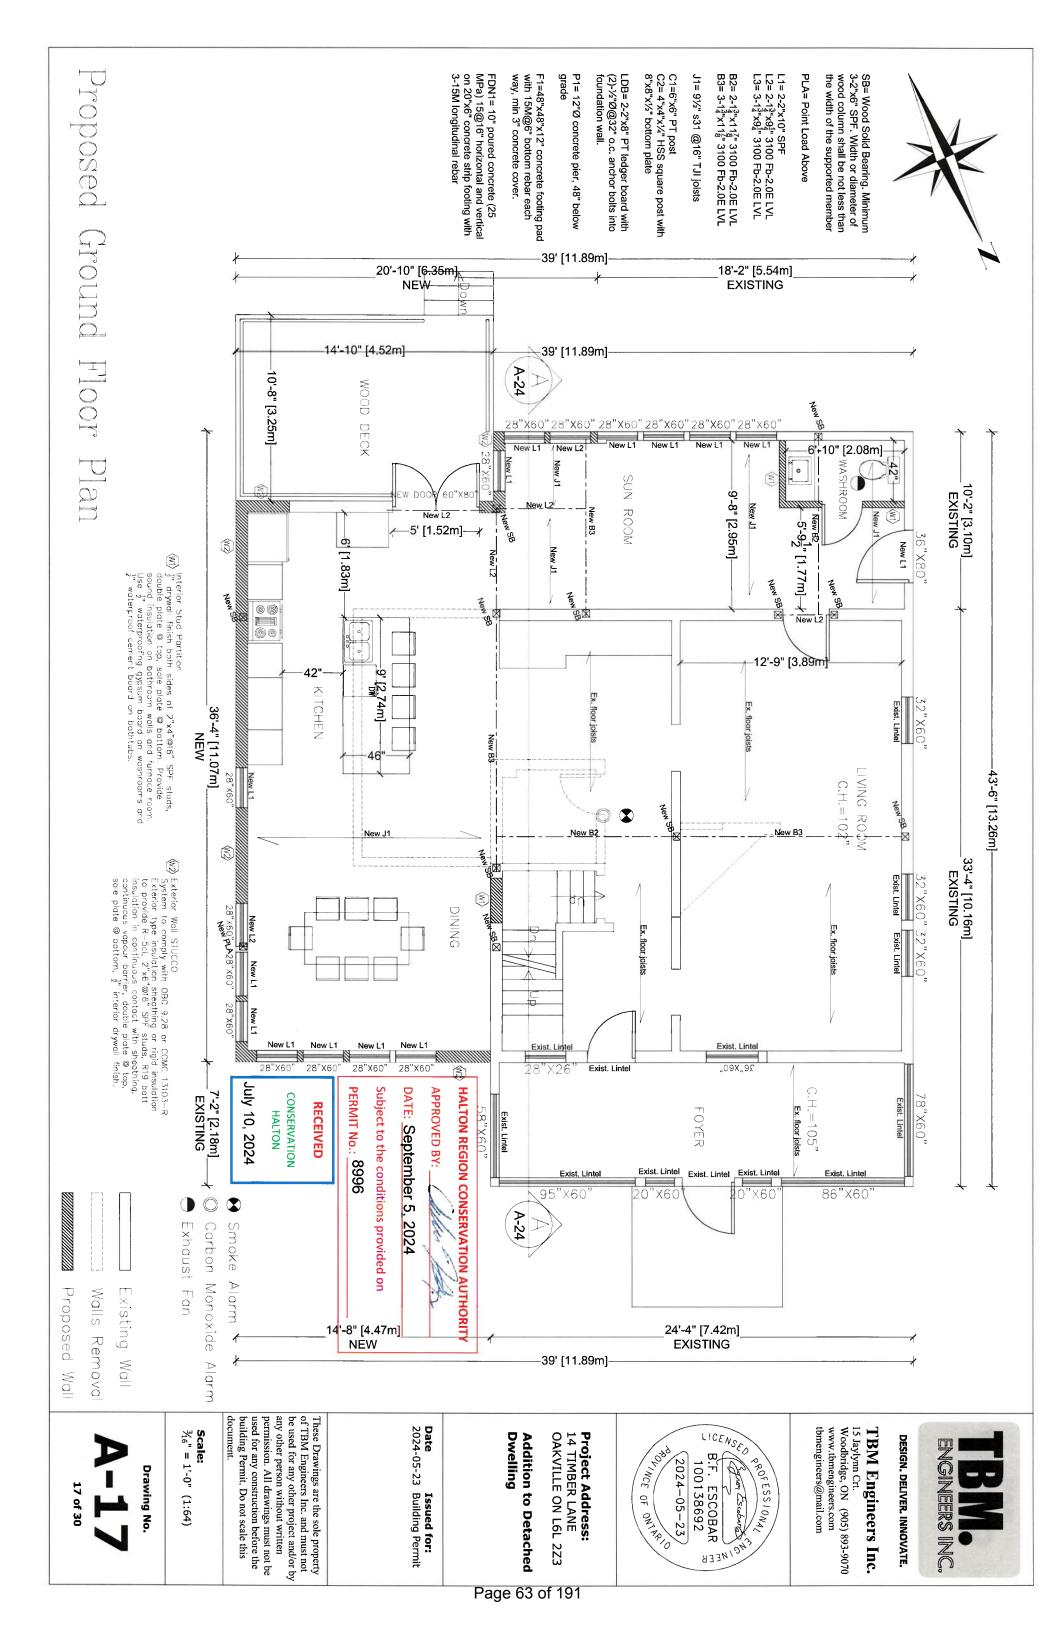

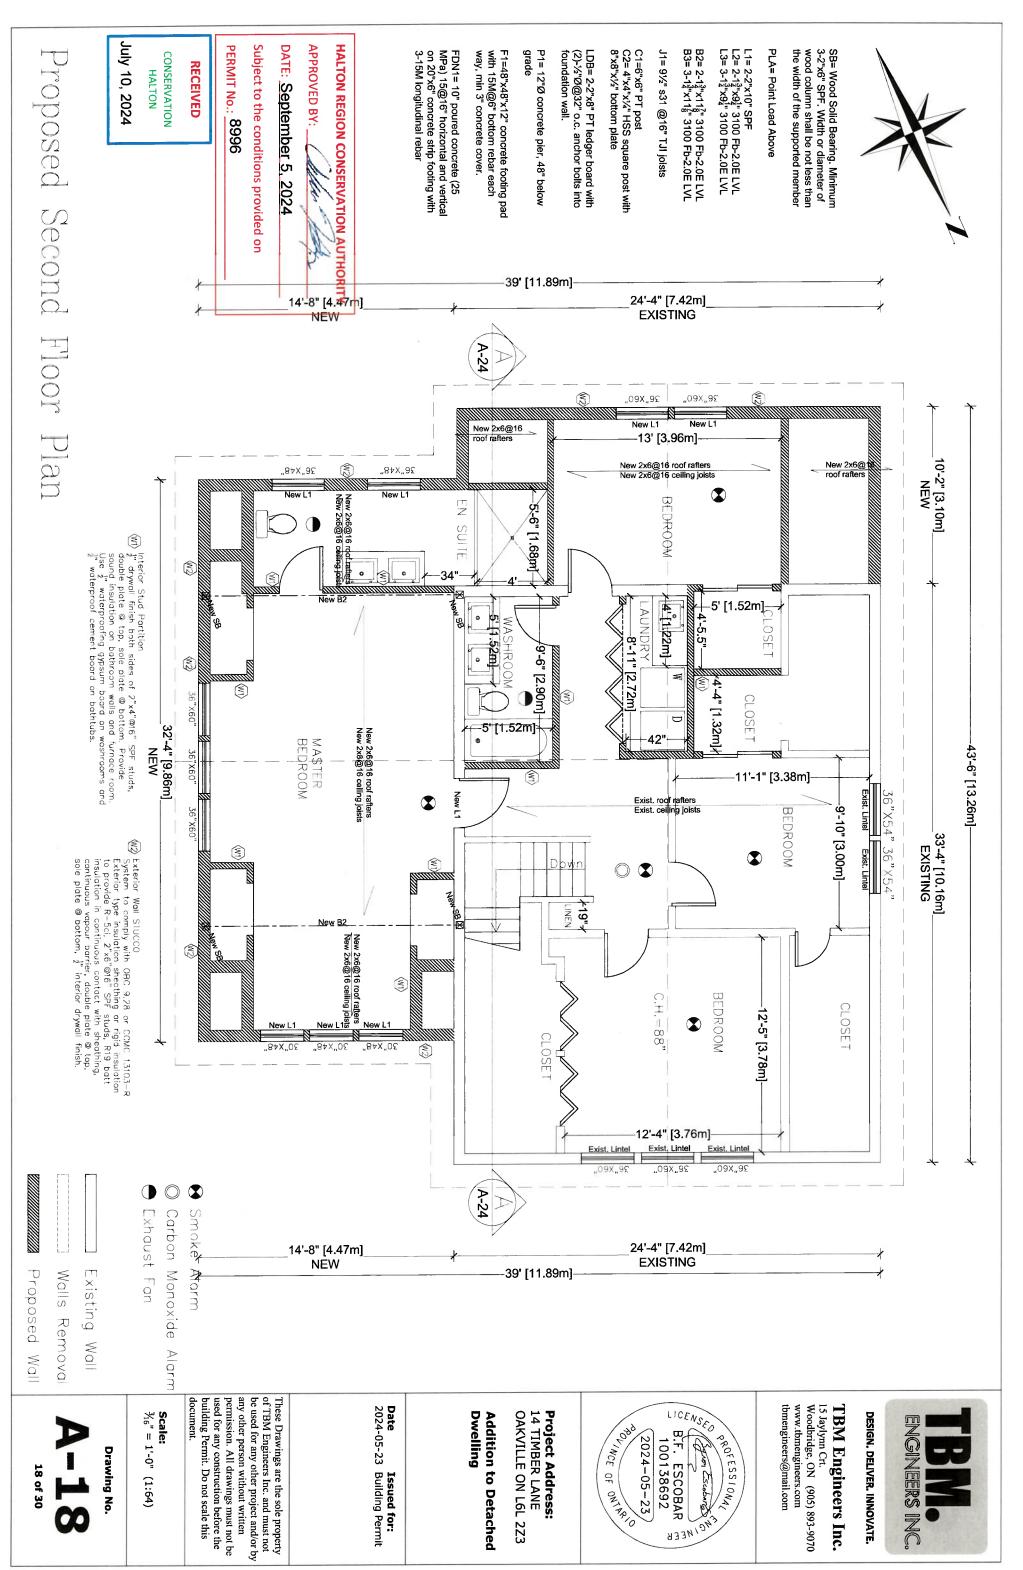


July 10, 2024

CONSERVATION HALTON

RECEIVED

PERMIT No.: 8996



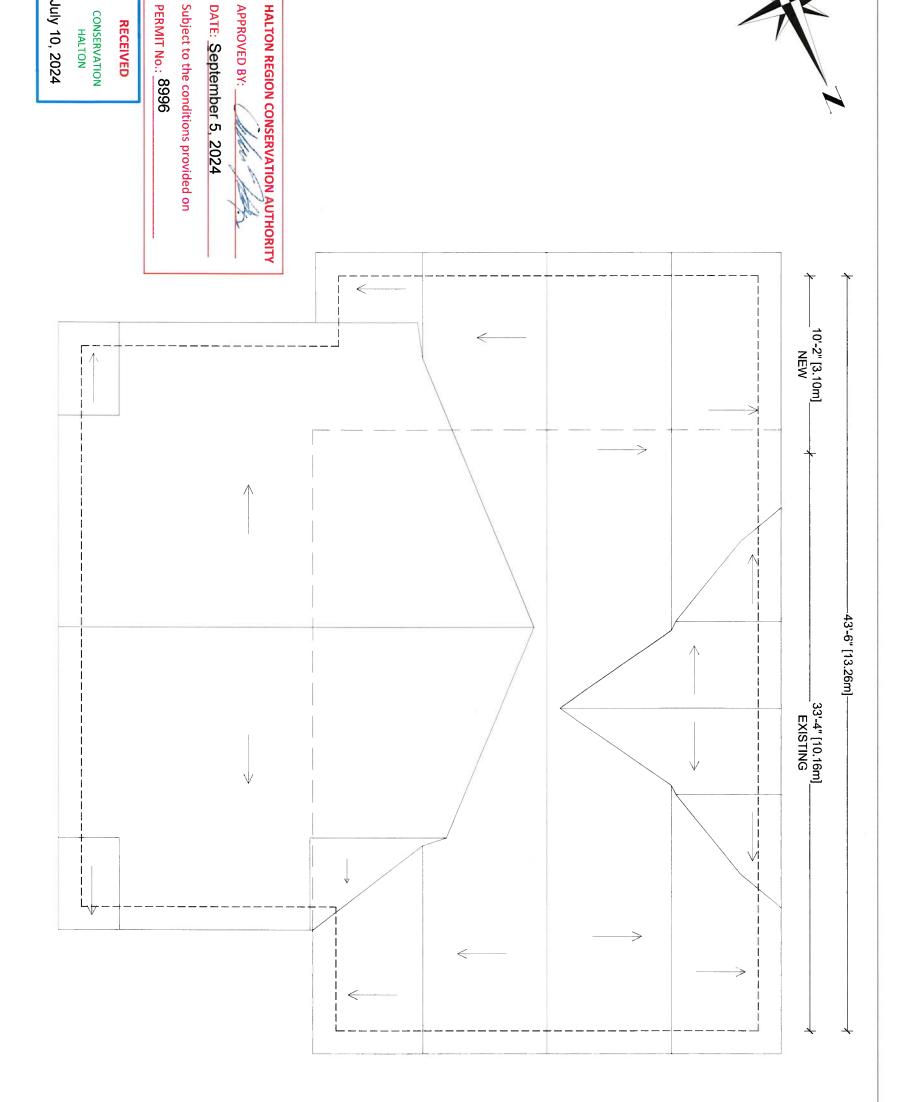

These Drawings are the sole property of TBM Engineers Inc. and must not be used for any other project and/or by any other person without written permission. All drawings must not be used for any construction before the building Permit. Do not scale this document.

_14'-8" [4.47m] NEW

Date Issued for: 2024-05-23 Building Permit

Scale: $\frac{3}{16}$ " = 1'-0" (1:64)

Drawing No.

19 of 30

Page 65 of 191

Addition to Detached

Dwelling

39' [11.89m]

Project Address:14 TIMBER LANE
OAKVILLE ON L6L 2Z3



24'-4" [7.42m] EXISTING

Woodbridge, ON (905) 893-9070 www.tbmengineers.com tbmengineers@mail.com

15 Jaylynn Crt. BM Engineers Inc.

DESIGN. DELIVER. INNOVATE.

ZEERS IZC.

Proposed Front (North) Elevation New Basement 78.78 Ceiling 86.83 Top of Roof 88.35 Second Floor 84.57 Basement 79.41 _23'-10<mark>3</mark>" [7.28m] HEIGHT 28"×60" 30"X48" 28"X60" 30"X48" 28"x60' STucco 30"X48" (STUCCO) 95"×60" (STUCCO) 28"X54 28"X54" July 10, 2024 PERMIT No.: 8996 Subject to the conditions provided on DATE: September 5, 2024 APPROVED BY: HALTON REGION CONSERVATION AUTHORITY CONSERVATION HALTON RECEIVED 28"X54 STUCCO 86"X60" STUCCO These Drawings are the sole property of TBM Engineers Inc. and must not be used for any other project and/or by any other person without written permission. All drawings must not be used for any construction before the building Permit. Do not scale this **Project Address:** 14 TIMBER LANE OAKVILLE ON L6L 2Z3 LICENSED 15 Jaylynn Crt. Woodbridge, ON (905) 893-9070 TBM Engineers Inc. www.tbmengineers.com tbmengineers@mail.com Date Issued for: 2024-05-23 Building Permit Dwelling **Scale:** $\frac{3}{16}$ " = 1'-0" (1:64) DESIGN. DELIVER. INNOVATE. Addition to Detached OLINCE OF ONTARIO AGINEERS INC PROFESSIONAL 2024-05-23) 3.F. ESCOBAR 100138692 20 of 30

ENCINEER.

Proposed Rear (South) Elevation New Basement 78.78 Basement 79.41 Second Floor 84.57 Ground Floor 81.75 Established Grade 81.07 _23'-10³# [7.28m] HEIGHT STUCCO 28"X60" 28"X60 (STUCCO) July 10, 2024 PERMIT No.: 8996 CONSERVATION HALTON Subject to the conditions provided on DATE: September 5, 2024 APPROVED BY: HALTON REGION CONSERVATION AUTHORITY RECEIVED 36"x48" (STUCCO) building Permit. Do not scale this **Project Address:**14 TIMBER LANE
OAKVILLE ON L6L 2Z3 LICENSED **Date Issued for:** 2024-05-23 Building Permit **Scale:** $\frac{3}{16}$ " = 1'-0" (1:64) tbmengineers@mail.com 15 Jaylynn Crt. TBM Engineers Inc. Dwelling DESIGN. DELIVER. INNOVATE. 21 of 30

GINEERS INC

Woodbridge, ON (905) 893-9070

BOLINCE OF ONTARIO B.F. ESCOBAR 100138692 PROFESSIONAL 2024-05-23 Byron Escobares ENCINEER.

Addition to Detached

These Drawings are the sole property of TBM Engineers Inc. and must not be used for any other project and/or by any other person without written permission. All drawings must not be used for any construction before the

Drawing No.

Page 67 of 191

Proposed Right (West) Elevation New Basement 78.78 Basement 79.41 Second Floor 84.57 Top of Roof 88.35 Ground Floor 81.75 _23'-10<mark>3</mark>" [7,28m] HEIGHT 78"X60" (STUCCO) 52"X60 Established Grade 81.07 32"X60 28"×54'28"×54" July 10, 2024 HALTON REGION CONSERVATION AUTHORITY PERMIT No.: 8996 Subject to the conditions provided on DATE: September 5, 2024 APPROVED BY: __ CONSERVATION HALTON STUCCO RECEIVED 32"X60 32"X18" STUCCO 36"X80 ∠80.71 These Drawings are the sole property of TBM Engineers Inc. and must not be used for any other project and/or by any other person without written permission. All drawings must not be used for any construction before the 15 Jaylynn Crt.
Woodbridge, ON (905) 893-9070
www.tbmengineers.com
tbmengineers@mail.com building Permit. Do not scale this document. LICENSED **Project Address:**14 TIMBER LANE
OAKVILLE ON L6L 2Z3 TBM Engineers Inc. **Date Issued for:** 2024-05-23 Building Permit **Scale:** $\frac{3}{16}$ " = 1'-0" (1:64) Dwelling DESIGN. DELIVER. INNOVATE. **Addition to Detached** BOLINCE OF ONTERIO ENGINEERS INC B.F. ESCOBAR 100138692 Byon Escobarge PROFESSIONAL 2024-05-23 Drawing No. 22 of 30 ENC NEER

Page 68 of 191

Proposed Left (East) Elevation New Basement 78,78 Basement 79.41 Ground Floor 81 Second Floor 84.57 STUCCO 28"X60 (STUCCO) (STUCCO) Established Grade 81.07 36"x60" 36"X60" 36"X60" July 10, 2024 HALTON REGION CONSERVATION AUTHORITY PERMIT No.: 8996 Subject to the conditions provided on DATE: September 5, 2024 APPROVED BY: CONSERVATION HALTON RECEIVED 58"X60" STUCCO -23'-10<mark>3</mark>" [7.28m] DICE BY PROFESSIONAL permission. All drawings must not be used for any construction before the building Permit. Do not scale this document. These Drawings are the sole property of TBM Engineers Inc. and must not be used for any other project and/or by any other person without written Date Issued for: 2024-05-23 Building Permit 15 Jaylynn Crt. Woodbridge, ON (905) 893-9070 www.tbmengineers.com tbmengineers@mail.com TBM Engineers Inc. **Scale:** $\frac{3}{16}$ " = 1'-0" (1:64) Dwelling **Project Address:**14 TIMBER LANE
OAKVILLE ON L6L 2Z3 **Addition to Detached** DESIGN. DELIVER. INNOVATE. BOLINCE OF ONTERIO B.F. ESCOBAR 100138692 AGINEERS INC 2024-05-23 **Drawing No.** 23 of 30 ENCINE ER

Page 69 of 191

Tatiana Quintana

From: Darren Dabideen <darren.dabideen@oakville.ca>

Sent:June 28, 2024 2:48 PMTo:Tatiana QuintanaCc:Darren Dabideen

Subject: re: Zoning Deficiencies - 14 Timber Lane

Follow Up Flag: Follow up Flag Status: Flagged

Permit Application Update - Zoning

June 28, 2024

Tatiana Quintana Tbm Engineers Inc. 15 Jaylynn Court , Unit Vaughan, ON, L4H 1Z6

Permit Application Number: 24 - 160844

Project Location: 14 Timber Lane, Oakville, ON, L6L2Z3

This is a progress update on the status of your permit application. The zoning examination is complete and we are providing courtesy notification of the deficiencies identified to date. Additional required examinations are in progress.

Once all examinations are complete, you will receive a refusal letter summarizing all deficiency comments. At that time, you will be eligible to resubmit your application with the deficiencies addressed. Your resubmission **must address all comments** identified by all disciplines and be accompanied by a detailed written response indicating how each item has been resolved. **Please do not resubmit materials until the refusal letter is issued.**

Please be aware of the following:

- When amending plans, be mindful of the impact of changes to associated drawings as they must coordinate and be consistent. You may need to contact various members of your design team to coordinate these changes. Be proactive, look ahead and see the impact the change makes to the entirety of your project.
- 2. Approved drawings by other town departments/approval agencies must match those submitted for building permit (i.e. Site Plan, Development Engineering, Conservation Halton, etc...).
- 3. The continued review of your application may result in additional comments identified by other disciplines within the building permit process. You will be notified once all required examinations are complete and you are eligible to resubmit.

For general inquiries, please contact buildingrequests@oakville.ca or 905-845-6601 ext. 7377

For questions about specific deficiency items, please feel free to contact me.

Darren Dabideen Zoning Plans Examiner

Phone: 905-845-6601, ext. 3907 Email: darren.dabideen@oakville.ca **ZONING** has identified the following comments that need to be addressed prior to resubmission. Hold all resubmission materials until refusal letter is issued:

- 1. Insufficient Information Provided the property located at 14 Timber Lane is regulated under the authority of the Conservation of Halton, provide documentation (permit) showing approval received from them for this proposal.
- 2. Insufficient Information Provided The property located at 14 Timber Lane is located within close proximity to Lake Ontario, therefore has a "Buffer Zone" flag upon the property requiring approval (Site Plan Approval) from the Planning Department prior to any development (construction) being approved. Provide proof of approval from the Town of Oakville's Planning Dept for the proposed project.
- 3. Insufficient Information Provided The property located at 14 Timber Lane is located within a Heritage area and as such has a Heritage warning flag upon it requiring approval of any renovation to be first approved by the Heritage Planners located within the Planning Dept. Provide a clearance letter from the Hertiage Planner approving the proposed project.
- 4. Residential Floor Area: Table 6.4.1. The maximum Residential Floor Area Ratio for a detached dwelling with a lot area between 0.00m2 and 557.5m2 shall be 43% (223.42m2) with a Lot area of 519.5m2, the calculated amount of 54.38% (282.54m2) does not comply.

Darren Dabideen Zoning Plans Examiner Building Services Town of Oakville | 905-845-6601, ext. 3907 | www.oakville.ca

Vision: A vibrant and livable community for all Please consider the environment before printing this email. http://www.oakville.ca/privacy.html

Notice of Public Hearing Committee of Adjustment Application



File # CAV A/160/2024

Electronic hearing:

By videoconference and live-streaming video on the Town of Oakville's Live Stream webpage at <u>oakville.ca</u> on November 13, 2024 at 7 p.m.

Why am I receiving this notice?

You are receiving this notice because the applicant noted below has submitted a minor variance application to the Town of Oakville. As stipulated by the *Planning Act*, notice must be provided to property owners within 60 metres (200 ft.) of the area to which the application applies. Further details of this application, including drawings, can be viewed online at <u>Agendas & Meetings (oakville.ca)</u>.

Applicant and property information:

Applicant / Owner	Authorized Agent	Subject Property
D. Aitken	Tatiana Quintana TBM Engineers Inc. 15 Jaylynn Crt Vaughan ON, CANADA L4H 1Z6	14 Timber Lane PLAN M11 LOT 48

Zoning of Property: RL3-0, Residential and N, Natural Area

Variance Request:

Under Section 45(1) of the *Planning Act*, the applicant is requesting the Committee of Adjustment to authorize a minor variance to permit the construction of a two-storey addition to the existing detached dwelling on the subject property proposing the following variance(s) to Zoning By-law 2014-014:

No.	Current	Proposed
1	Table 6.4.1	To increase the maximum residential floor area
	The maximum residential floor area ratio for a detached dwelling on a lot with a lot area less than 557.5 m ² shall be 43%.	ratio to 54.38%.

How do I participate if I have comments or concerns?

Submit written correspondence

Although there are no third-party appeal rights, you are entitled to notice and may make written submissions before the application is considered by the Committee of Adjustment. You can send your written comments regarding the application by email (preferred) or regular mail to the Secretary-Treasurer noted below. Include your name, address and application number or address of the property in which you are providing comments. To allow all Committee of Adjustment members the opportunity to review and consider your comments, please provide your written submissions to be received no later than noon the day before the hearing date.

Please be advised that any written correspondence submitted to the Town of Oakville regarding this application will be made public pursuant to the *Planning Act* and *Municipal Freedom of Information and Protection Act*.

Participate in the electronic hearing by videoconference.

Pre-register as a delegation by contacting the Secretary-Treasurer noted below by email or telephone no later than noon the day before the hearing date. You are encouraged to pre-register as a delegation as soon as possible in order to facilitate an orderly registration process. Pre-registered delegates will be provided with access codes and instructions to enter the electronic hearing.

Watch the hearing:

If you do not wish to participate, but would like to follow along, the hearing will be publicly live-streamed on the Town of Oakville's Live Stream webpage at oakville.ca. The live-stream will begin just before 7 p.m.

More information:

Town departments and agency comments regarding this application will be available online at <u>Agendas & Meetings (oakville.ca)</u> by noon on the Friday before the hearing date.

Notice of decision:

If you wish to be notified of the decision for this application, you must make a written request by email or regular mail to the Secretary-Treasurer noted below. The written request must be received before noon the day before the hearing date. This will entitle you to be notified of any future Ontario Land Tribunal proceedings.

Contact information:

Jen Ulcar Secretary-Treasurer of Committee of Adjustment 1225 Trafalgar Road Oakville, ON L6H 0H3


Phone: 905-845-6601 ext. 1829 Email: coarequests@oakville.ca

Date mailed:

October 29, 2024

CAV A/160/2024 - 14 Timber Lane

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TREE PROTECTION BARRIERS FOR TREES SITUATED ON THE TOWN ROAD ALLOWANCE WHERE VISIBILITY MUST BE MAINTAINED CAN BE 1.2m (4'-0") HEIGHT AND CONSIST OF ORANGE PLASTIC WEB SNOW FENCING ON A WOOD FRAME MADE OF 2"X4"'S.

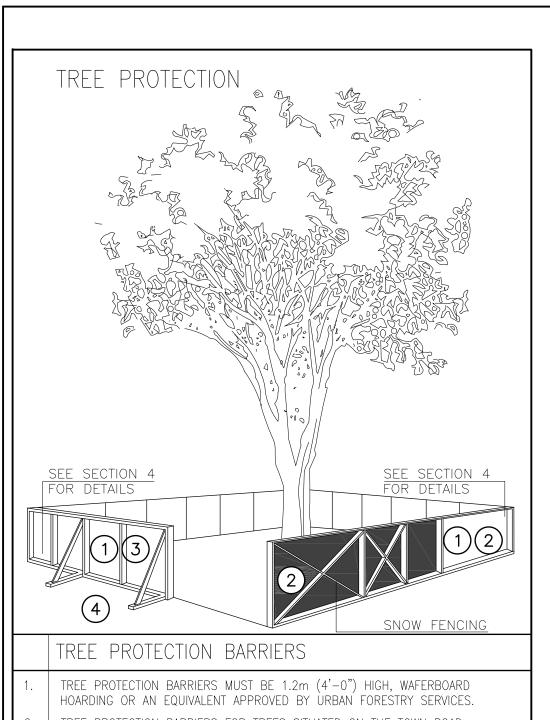WHERE SOME EXCAVATE OR FILL HAS TO BE TEMPORARILY LOCATED NEAR A TREE PROTECTION BARRIER, PLYWOOD MUST BE USED TO ENSURE NO MATERIAL ENTERS THE TREE PROTECTION ZONE.

ALL SUPPORTS AND BRACING SHOULD BE OUTSIDE THE TREE PROTECTION ZONE. ALL SUCH SUPPORTS SHOULD MINIMIZE DAMAGING ROOTS OUTSIDE THE TREE PROTECTION BARRIER. NO CONSTRUCTION ACTIVITY, GRADE CHANGES, SURFACE TREATMENT OR

EXCAVATIONS OF ANY KIND IS PERMITTED WITHIN THE TREE PROTECTION ZONE. ALL LOCATES MUST BE OBTAINED PRIOR TO THE INSTALLATION OF THE PROPOSED HOARDING WITHIN THE MUNICIPAL RIGHT OF WAY.

SECTION 4, SIGNAGE

A SIGN (AS PER BELOW) MUST BE MOUNTED ON ALL SIDES OF A TREE PROTECTION BARRIER FOR THE DURATION OF THE PROJECT. THE SIGN SHOULD BE A MINIMUM OF 40cmX60cm AND MADE OF WHITE GATOR BOARD OR EQUIVALENT MATERIAL.

"TREE PROTECTION ZONE NO GRADE CHANGE, STORAGE OF MATERIALS OR EQUIPMENT IS PERMITTED WITHIN THIS AREA. THE TREE PROTECTION BARRIER MUST NOT BE REMOVED WITHOUT THE WRITTEN AUTHORIZATION OF THE TOWN OF CARVILLE

> TOWN OF OAKVILLE PARKS AND RECREATION DEPARTMENT

NAME: TREE PROTECTION BARRIERS

FILE NO.:

SOLID HOARDING (PLYWOOD BOARDS)

FRAMED HOARDING (PLASTIC SAFETY FENCING)

1 OAKVILLE SITE REQUIREMENTS

A1.2 SCALE: DNS

1. GENERAL NOTES: A) SILTATION CONTROL MEASURES SHALL BE IMPLEMENTED BY THE CONTRACTOR PRIOR TO THE COMMENCEMENT OF SITE GRADING WORKS. TO SATISFACTION OF THE CITY AND HALTON CONSERVATION.

B) IF CONSTRUCTION IS INTERRUPTED AND/OR INACTIVITY EXCESS 30 DAYS, STRIPPED/ BASE AREAS SHALL BE STABILIZED BY SEEDING.

C) THE SEDIMENT CONTROL DEVICES SHALL BE INSPECTED AFTER EVERY RAINFALL AND/ OR EVERY WEEK.

D) THE SEDIMENT CONTROL DEVICES MUST BE REPAIRED, CLEANED AND/ OR REPLACED IF NECESSARY OR AS DIRECTED BY THE ENGINEER. CONSERVATION AUTHORITY OR THE CITY.

E) ALL SEDIMENT CONTROL DEVICES SHALL REMAIN IN PLACE UNTIL ALL CONSTRUCTION, GRADING, TOPSOILING AND SODDING ARE COMPLETE.

F) WHEN ALL CONSTRUCTION, GRADING AND SODDING IS COMPLETED. THE SEDIMENT CONTROL DEVICES SHALL BE REMOVED AND THE DISTURBED AREAS REINSTATED.


2. ALL CATCH BASINS ON SITE SHALL HAVE PROPER SEDIMENT CONTROLS AS NOTED HEREON.


3. THE EROSION & SEDIMENT CONTROL FENCE SHALL BE AS

4. CONTRACTOR TO OBTAIN ALL NECESSARY ROAD OCCUPANCY PERMITS FOR PROPOSED WORKS WITHIN THE MUNICIPAL ROAD ALLOWANCES.

A2.1 SCALE: 1:150

2 EROSION AND SEDIMENT CONTROL A2.1 SCALE: DNS

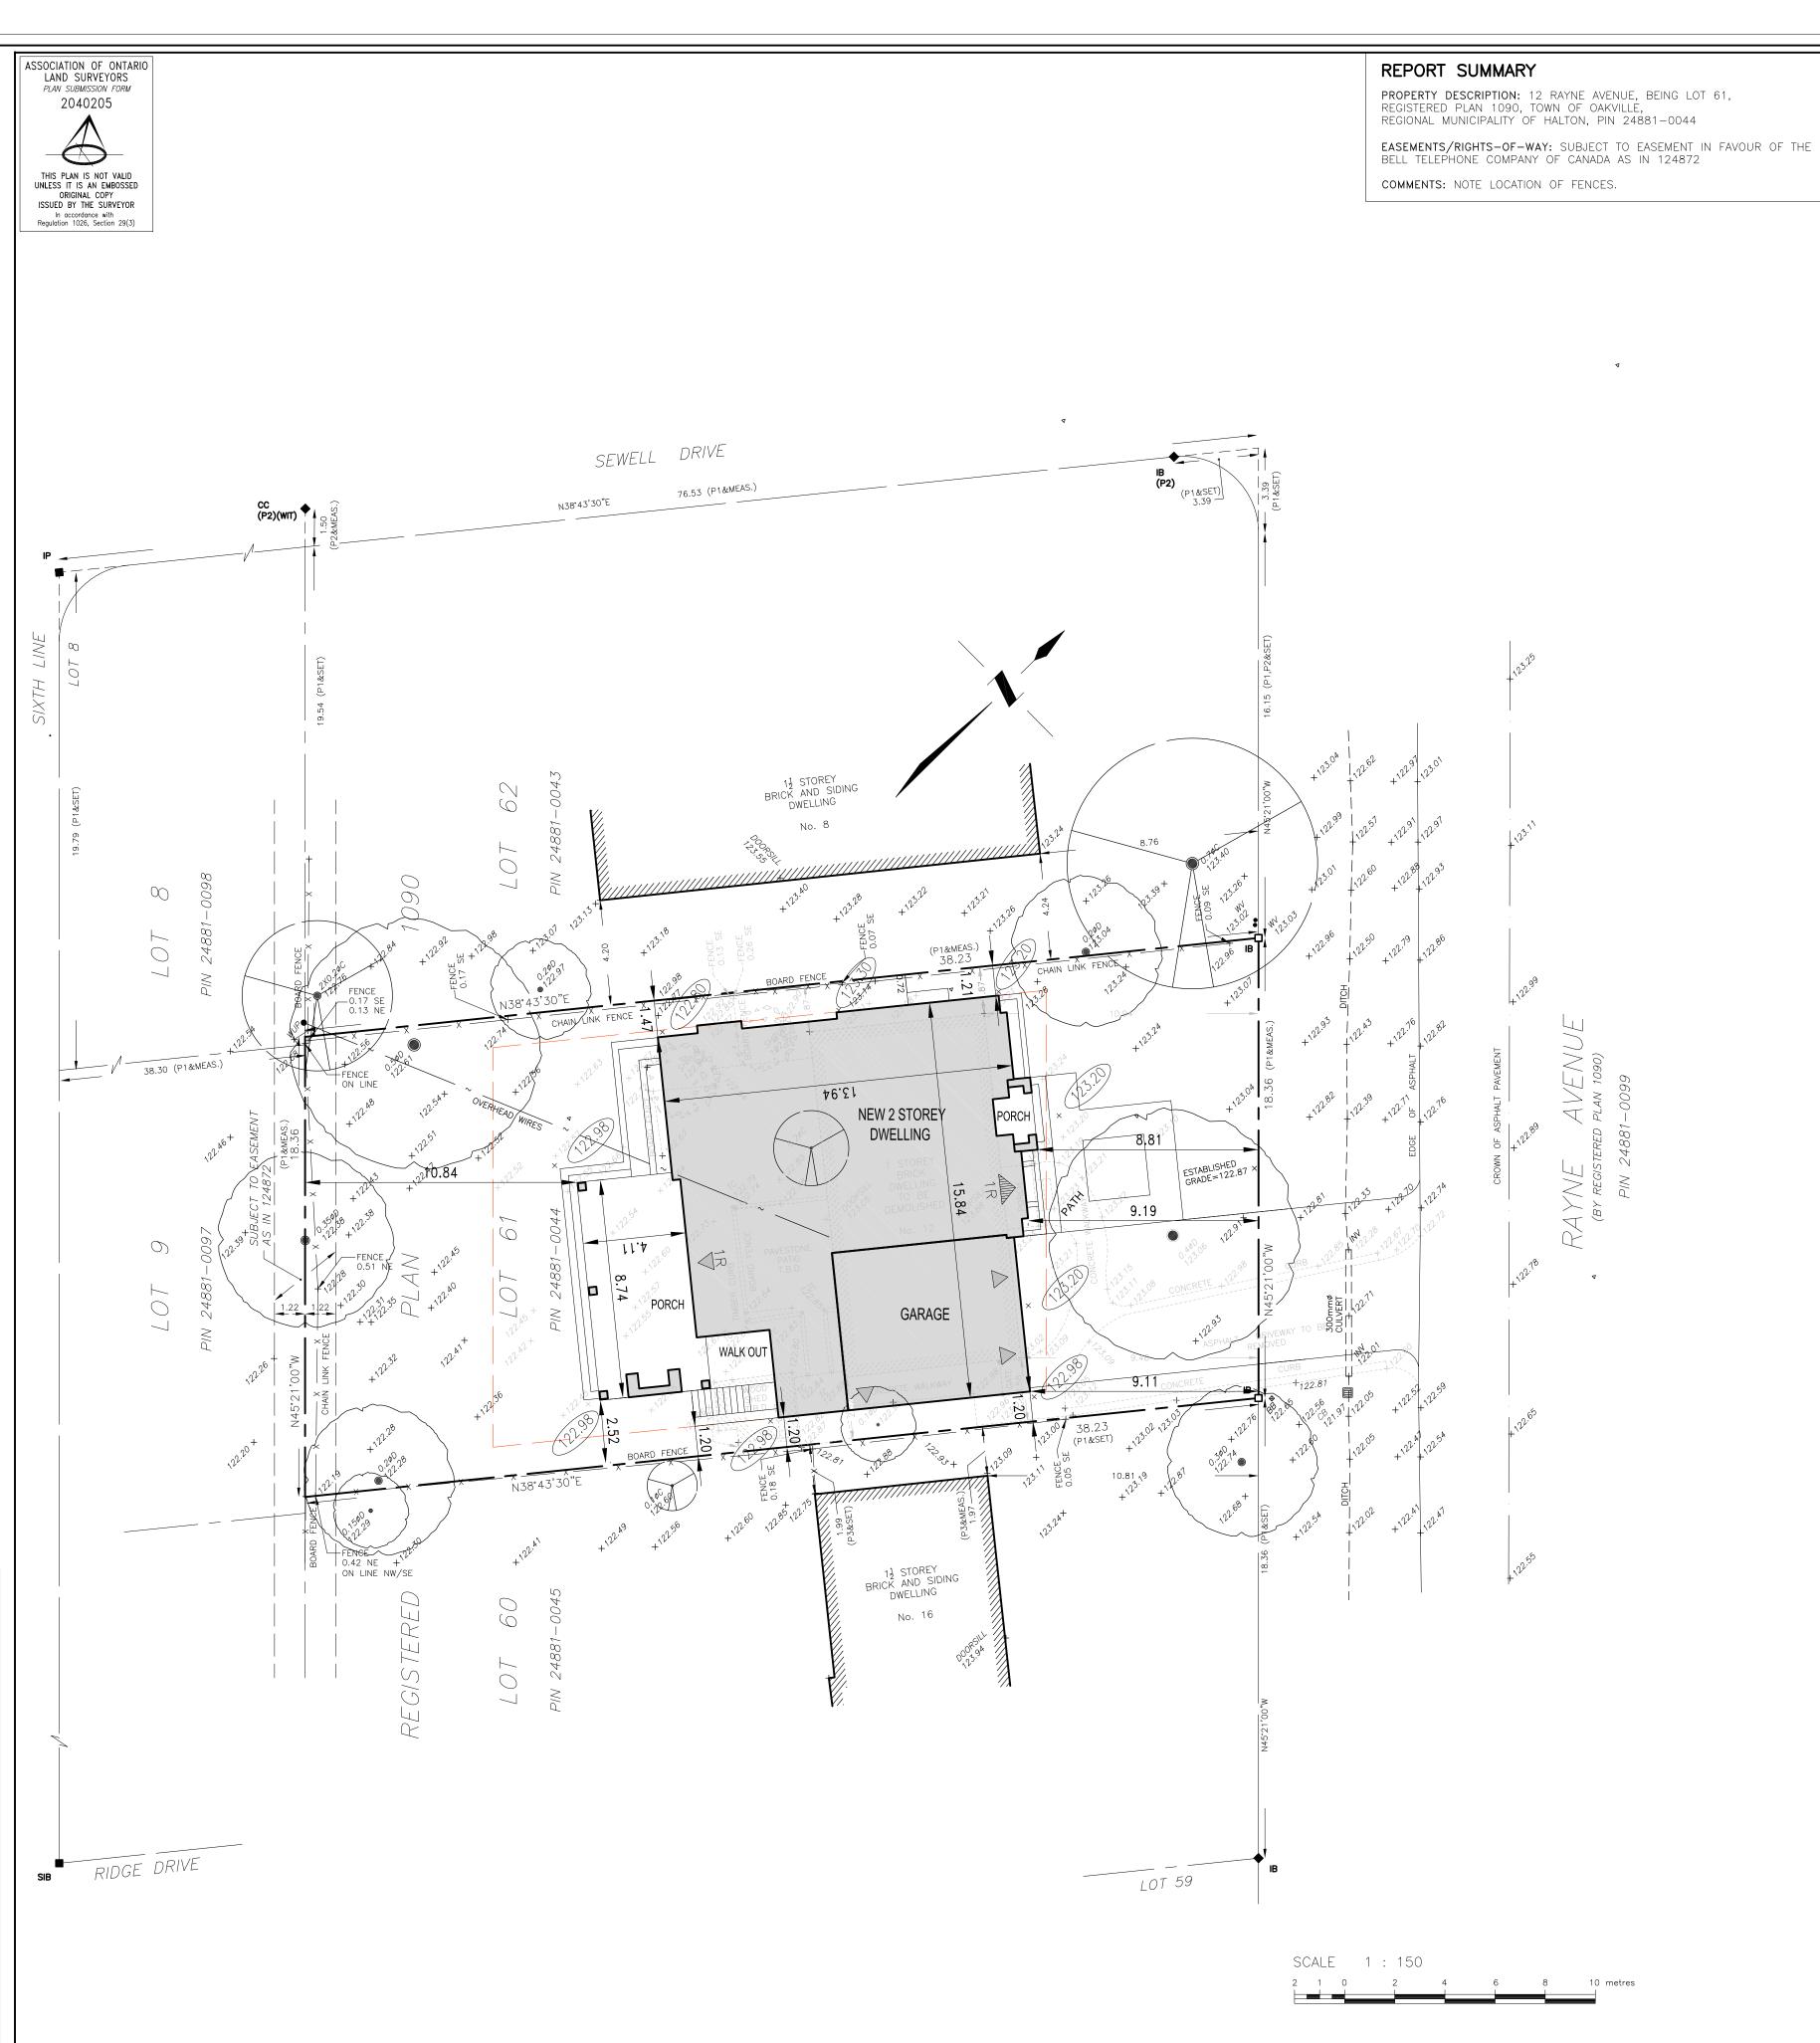

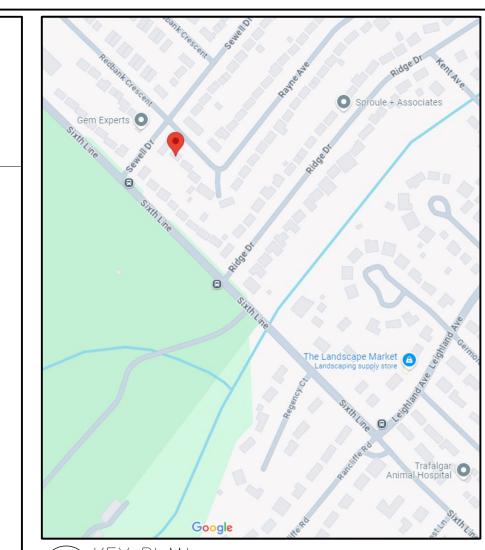

A21/SCALE: DNS

70NING 12 DAVNE AVE

ZUNING 12 RAYNE AVE.		
ZONE RL7-0 LOT AREA: MIN. LOT FRONTAGE:	697.7 m. ² (7,509 SQ.FT.)	
MAXIMUM HEIGHT: MAX. LOT COV. 35%: MAX. R.F.A. 41%:	9.0m. 244.19m² (2,628 s.f.) 286.05m² (3,078 s.f.)	
MIN FRONT SETBACK: MIN SIDE SETBACK:	APROX. 8.46m. 1.2m.	
MIN REAR SETBACK:	7.5m.	
PROPOSED GROUND FLOOR SECOND FLOOR EXT. GARAGE	(154.31m ²) 1,661 s.f. (153.84m ²) 1,656 s.f. (45.98m ²) 495 s.f.	

 $(40.22m^2)$ 433 s.f. PROPOSED LOT COV.: 34.47% (240.52m²) 2,589 s.f.

 (42.08m^2) 453 s.f.

(GARAGE & PORCHES INCL'D.) PROPOSED R.F.A. (44.17%): (308.15m²) 3,317 s.f. PROPOSED ROOF HEIGHT 9.0 m

> 09.21.24 | ISSUED FOR GRADING DESIGN REF. DATE: DESCRIPTION:

A2.1 SCALE: DNS

REGIONAL APPROVAL

INT. GARAGE

COVERED PORCHES

(& COV'D AREAS)

REGION DESIGN OF WATER AND/OR WASTEWATER SERVICES APPROVED SUBJECT TO DETAIL CONSTRUCTION CONFORMING TO HALTON REGION STANDARDS AND SPECIFICATIONS AND LOCATION APPROVAL FROM THE AREA MUNICIPALITY.

INFRASTRUCTURE PLANNING AND POLICY

THE APPLICANT SHOULD BE AWARE THAT THE APPROVAL OF THE WATER SYSTEM ON PRIVATE PROPERTY IS THE RESPONSIBILITY OF THE LOCAL MUNICIPALITY. REGARDLESS, THE APPLICANT MUST ENSURE THAT THE REGION OF HALTON'S STANDARDS AND SPECIFICATIONS ARE MET (THE WATER AND WASTEWATER LINEAR DESIGN MANUAL MAY BE OBTAINED FRO<u>M THE DATA MANAGEMENT GROU</u>P AT 905-825-6032) FURTHERMOFALL WATER QUALITY TESTS MUST BE COMPLETED TO THE REGION OF HALTON'S SATISFACTION BEFORE THE WATER SUPPLY CAN BE TURNED

6 REGION OF HALTON A2.1 SCALE: DNS

7 GRADING CERTIFICATE
A2.1 SCALE: NA

CERTIFICATION FOR PROPOSED GRADING

KEYSTONE HOME DESIGNS www.keystonehomedesigns.com

Drawings must NOT be scaled. Contractor must check and verify all dimensions, specifications and drawings on site and report any discrepancies to the architect prior to proceeding with any of the work.

SITE LEGEND:

FINISHED FLOOR ELEVATION

FINISHED DECK ELEVATION

PROPOSED ADDITION AREA

EXISTING TREE TO REMAIN

RAIN WATER DOWNSPOUT

EXISTING TREE TO BE REMOVED

SITE ACCREDITATION

REGISTERED PLAN 1090

REGIONAL MUNICIPALITY OF HALTON

INFORMATION TAKEN FROM A SURVEY PREPARED BY:

TARASICK McMILLAN KUBICKI LIMITED 9438-SRPR-T

DISTANCES SHOWN ON THIS PLAN ARE IN METRES

AND CAN BE CONVERTED TO FEET BY DIVIDING BY

ELEVATIONS ARE REFERRED TO CANADIAN GEODETIC

VERTICAL DATUM-1928, AND WERE DERIVED FROM TOWN

OF OAKVILLE, BENCHMARK No. 227, HAVING A PUBLISHED

(C)COPYRIGHT, 2024

SECONDARY ENTRANCE

FINISHED BASEMENT ELEVATION

EXISTING GRADE FINISHED GRADE

MAIN ENTRANCE

TREE HOARDING

PLAN OF TOPOGRAPHY OF

TOWN OF OAKVILLE

ONTARIO LAND SURVEYORS

AUGUST 15, 2024

ELEVATION OF 131.8305 metres.

0.3048.

LOT 61

--- PROPERTY LINE

INFO@KEYSTONEHOMEDESIGNS.COM 905.616.2221

251 NORTH SERVICE RD. SUITE 303 OAKVILLE, ON. L6M 3E7 905-616-2221

info@keystonehomedesigns.com www.keystonehomedesigns.com

CLIENT:

WALIA RESIDENCE

ADDRESS: 12 RAYNE AVENUE OAKVILLE, ON. DRAWING TITLE:

SITE PLAN

DRAWN: G.C.

DATE: 09/15/24 SCALE: AS SHOWN SHEET NUMBER: JOB NUMBER: 24-06 A2.1

Page 75 of 191



DESIGNED APPROVED BY:

DATE:





251 NORTH SERVICE RD. SUITE 303 OAKVILLE, ON. L6M 3E7 905-616-2221

info@keystonehomedesigns.com www.keystonehomedesigns.com NUT FUR CUNSTRUCTIUN

Page 77 of 191

PROJECT:
WALIA

RESIDENCE

12 RAYNE AVENUE. OAKVILLE, ON. ELEVATION 'B3'

PROJECT: 24-06

DATE: SEP.09.24

SCALE: N.T.S.

DRAWN BY:

G. CASTILLO

A4.2

DESIGNED APPROVED BY:

DATE:





© 202

251 NORTH SERVICE RD.
SUITE 303
OAKVILLE, ON.
L6M 3E7
905-616-2221
info@keystonehomedesigns.com
www.keystonehomedesigns.com

NUT FUR CUNSTRUCTIUN

Page 78 of 191

WALIA RESIDENCE

PROJECT:

12 RAYNE AVENUE. OAKVILLE, ON. ELEVATION 'B3'

PROJECT: 24-06

DATE: SEP.09.24

SCALE: N.T.S.

DRAWN BY:

G. CASTILLO

A4.3

DESIGNED APPROVED BY:

DATE:





251 NORTH SERVICE RD. SUITE 303 OAKVILLE, ON. L6M 3E7 905-616-2221 info@keystonehomedesigns.com

www.keystonehomedesigns.com

NOT FOR CONSTRUCTION

Page 79 of 191

WALIA RESIDENCE

PROJECT:

12 RAYNE AVENUE. OAKVILLE, ON. ELEVATION 'B4'

PROJECT: 24-06

DATE: SEP.10.24

SCALE: N.T.S.

DRAWN BY:

G. CASTILLO

A4.4







Notice of Public Hearing Committee of Adjustment Application



File # CAV A/161/2024

Electronic hearing:

By videoconference and live-streaming video on the Town of Oakville's Live Stream webpage at <u>oakville.ca</u> on November 13, 2024 at 7 p.m.

Why am I receiving this notice?

You are receiving this notice because the applicant noted below has submitted a minor variance application to the Town of Oakville. As stipulated by the *Planning Act*, notice must be provided to property owners within 60 metres (200 ft.) of the area to which the application applies. Further details of this application, including drawings, can be viewed online at <u>Agendas & Meetings (oakville.ca)</u>.

Applicant and property information:

Applicant / Owner	Authorized Agent	Subject Property
N. Walia	GERARDO CASTILLO	12 Rayne Ave
A. Walia	KEYSTONE HOME DESIGNS	PLAN 1090 LOT 61
	251 North Service Rd. West Rd	
	suite 303	
	OAKVILLE ON, Canada L6M 3E7	

Zoning of property: RL7-0, Residential

Variance request:

Under Section 45(1) of the *Planning Act*, the applicant is requesting the Committee of Adjustment to authorize a minor variance to permit the construction of a two-storey detached dwelling on the subject property proposing the following variance to Zoning By-law 2014-014:

No.	Current	Proposed
1	Table 6.4.1	To increase the maximum residential floor area
	The maximum residential floor area ratio for a detached dwelling on a lot with a lot area between 650.00 m ² and 742.99 m ² shall be 41%.	ratio to 44.17%.

How do I participate if I have comments or concerns?

Submit written correspondence

Although there are no third-party appeal rights, you are entitled to notice and may make written submissions before the application is considered by the Committee of Adjustment. You can send your written comments regarding the application by email (preferred) or regular mail to the Secretary-Treasurer noted below. Include your name, address and application number or address of the property in which you are providing comments. To allow all Committee of Adjustment members the opportunity to review and consider your comments, please provide your written submissions to be received no later than noon the day before the hearing date.

Please be advised that any written correspondence submitted to the Town of Oakville regarding this application will be made public pursuant to the *Planning Act* and *Municipal Freedom of Information and Protection Act*.

Participate in the electronic hearing by videoconference.

Pre-register as a delegation by contacting the Secretary-Treasurer noted below by email or telephone no later than noon the day before the hearing date. You are encouraged to pre-register as a delegation as soon as possible in order to facilitate an orderly registration process. Pre-registered delegates will be provided with access codes and instructions to enter the electronic hearing.

Watch the hearing:

If you do not wish to participate, but would like to follow along, the hearing will be publicly live-streamed on the Town of Oakville's Live Stream webpage at <u>oakville.ca</u>. The live-stream will begin just before 7 p.m.

More information:

Town departments and agency comments regarding this application will be available online at <u>Agendas & Meetings (oakville.ca)</u> by noon on the Friday before the hearing date.

Notice of decision:

If you wish to be notified of the decision for this application, you must make a written request by email or regular mail to the Secretary-Treasurer noted below. The written request must be received before noon the day before the hearing date. This will entitle you to be notified of any future Ontario Land Tribunal proceedings.

Contact information:


Jen Ulcar Secretary-Treasurer of Committee of Adjustment 1225 Trafalgar Road Oakville, ON L6H 0H3


Phone: 905-845-6601 ext. 1829 Email: coarequests@oakville.ca


Date mailed:

October 29, 2024

CAV A/161/2024 - 12 Rayne Avenue

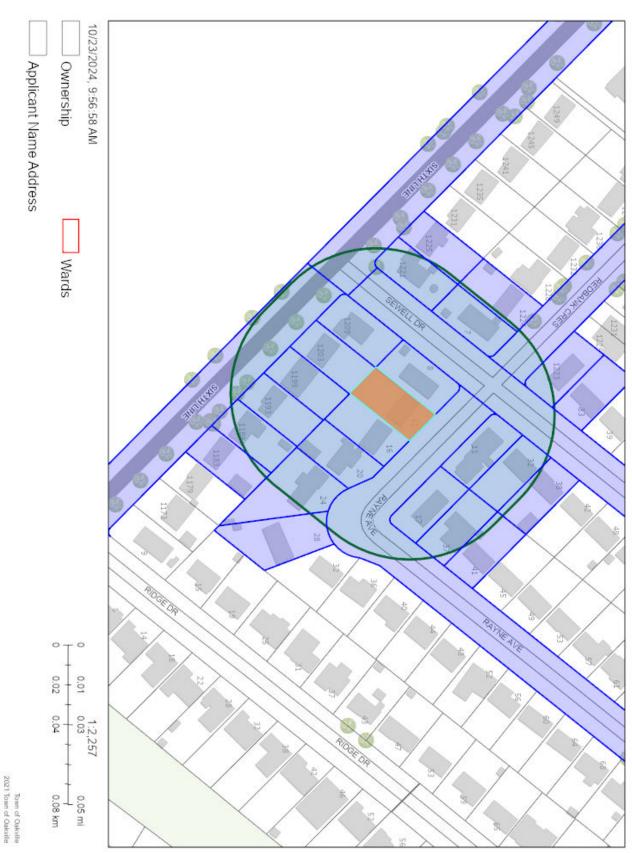


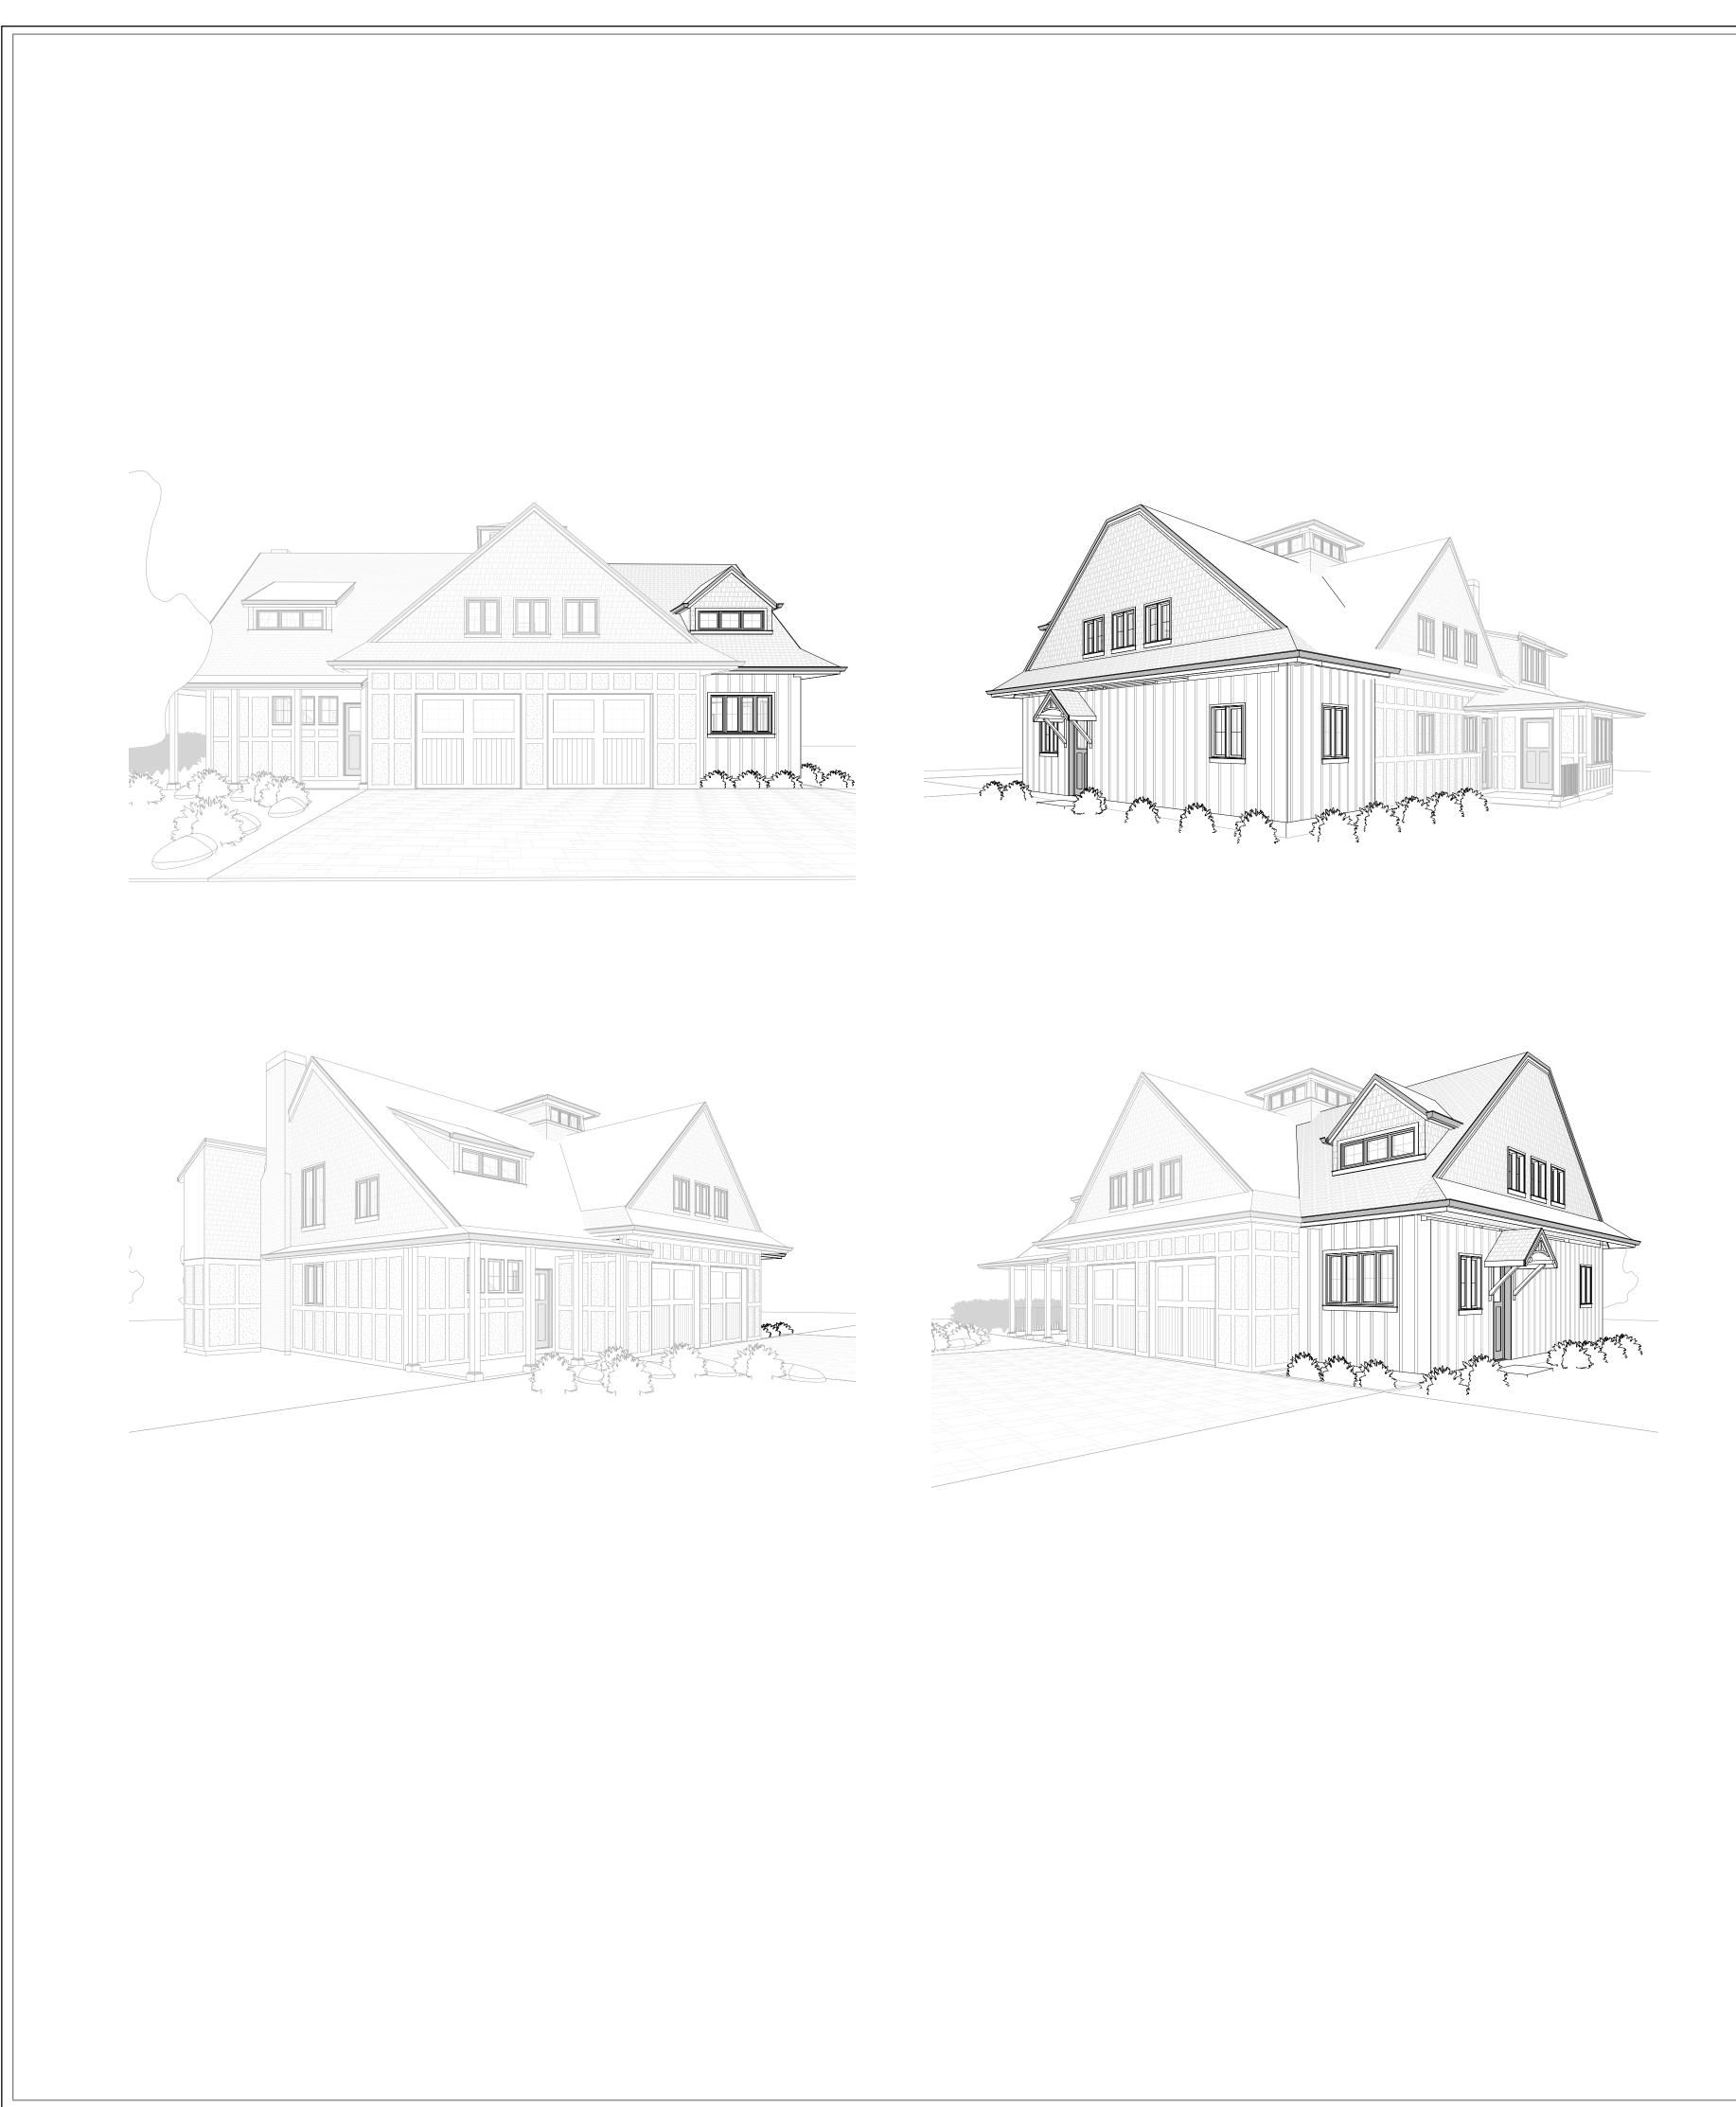

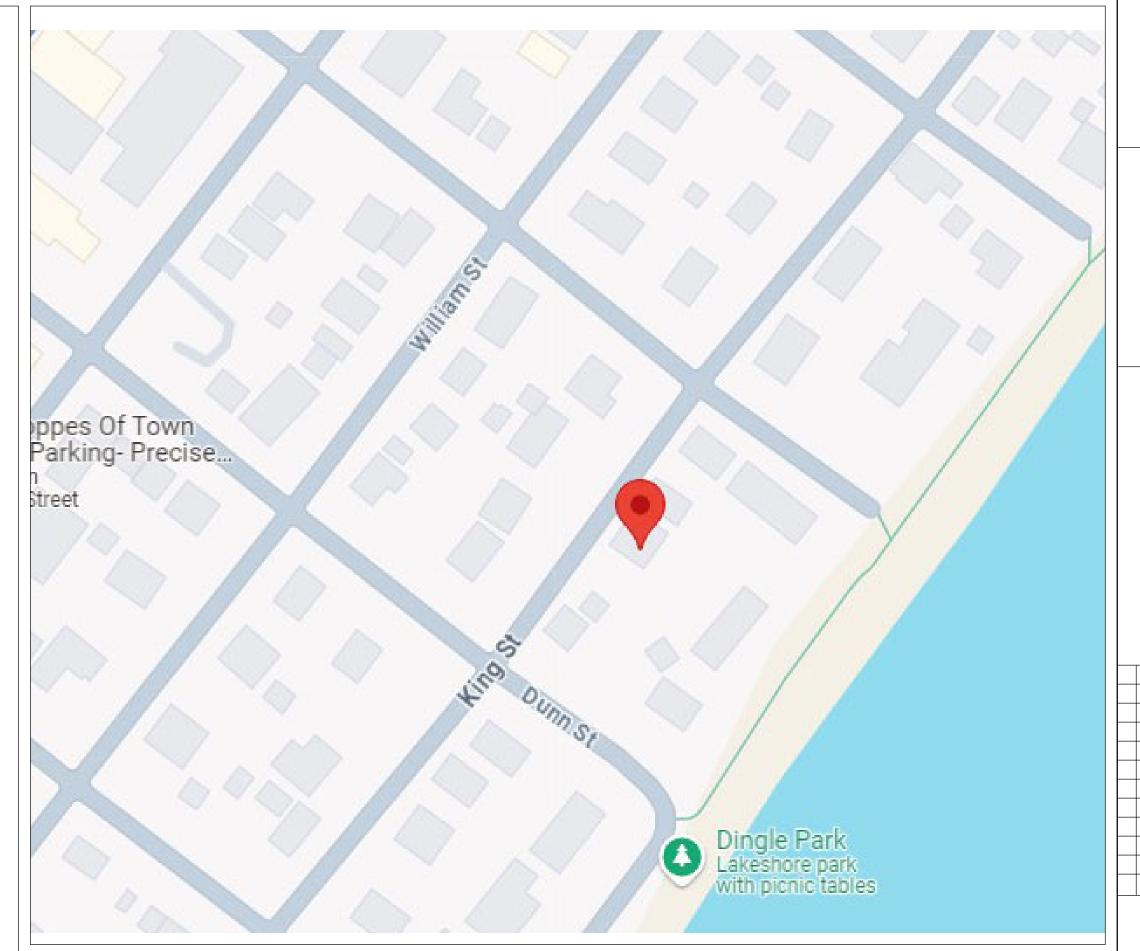

262 KING ST, OAKVILLE

SCOPE OF WORK: ALTERATION AND ADDITION

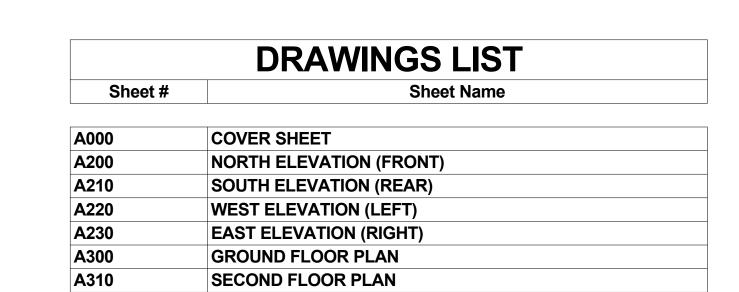


CONTRACTOR SHALL CHECK AND VERIFY ALL DIMENSIONS ON SITE. ALL DRAWINGS ARE THE PROPERTY OF THE DESIGNER AND MAY NOT BE USED WITHOUT HIS PERMISSION. THIS DRAWING IS NOT TO BE USED FOR CONSTRUCTION UNTIL COUNTERSIGNED BY THE THE DESIGNER. DRAWINGS ARE NOT TO BE SCALED.

GENERAL CONSTRUCTION NOTES

All construction to comply with requirements of Ontario Building Code (OBC) — Latest edition.

— These notes are included as minimum requirements

Notes appearing on Architectural or Structural drawings shall supersede these notes.
Report discrepancies immediately.

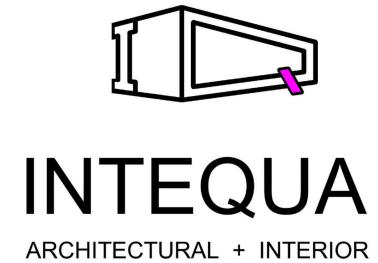

159 QUEBEC AVENUE, TORONTO, ONTARIO M6P 2T9 TEL: (647) 740-5825 E: intequa@gmail.com

Client:

Mr. Clive Maile

-1--4.

TWO-STOREY ADDITION

Addres

262 King Street, Oakville ON L6J 1B7

Drawing Ti

COVER SHEET


230503


File Application #

Scale

Date September 30, 2024

A000

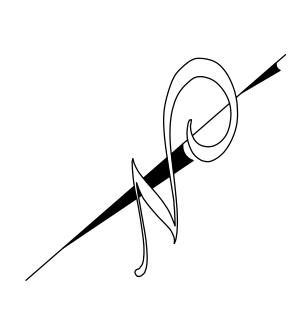

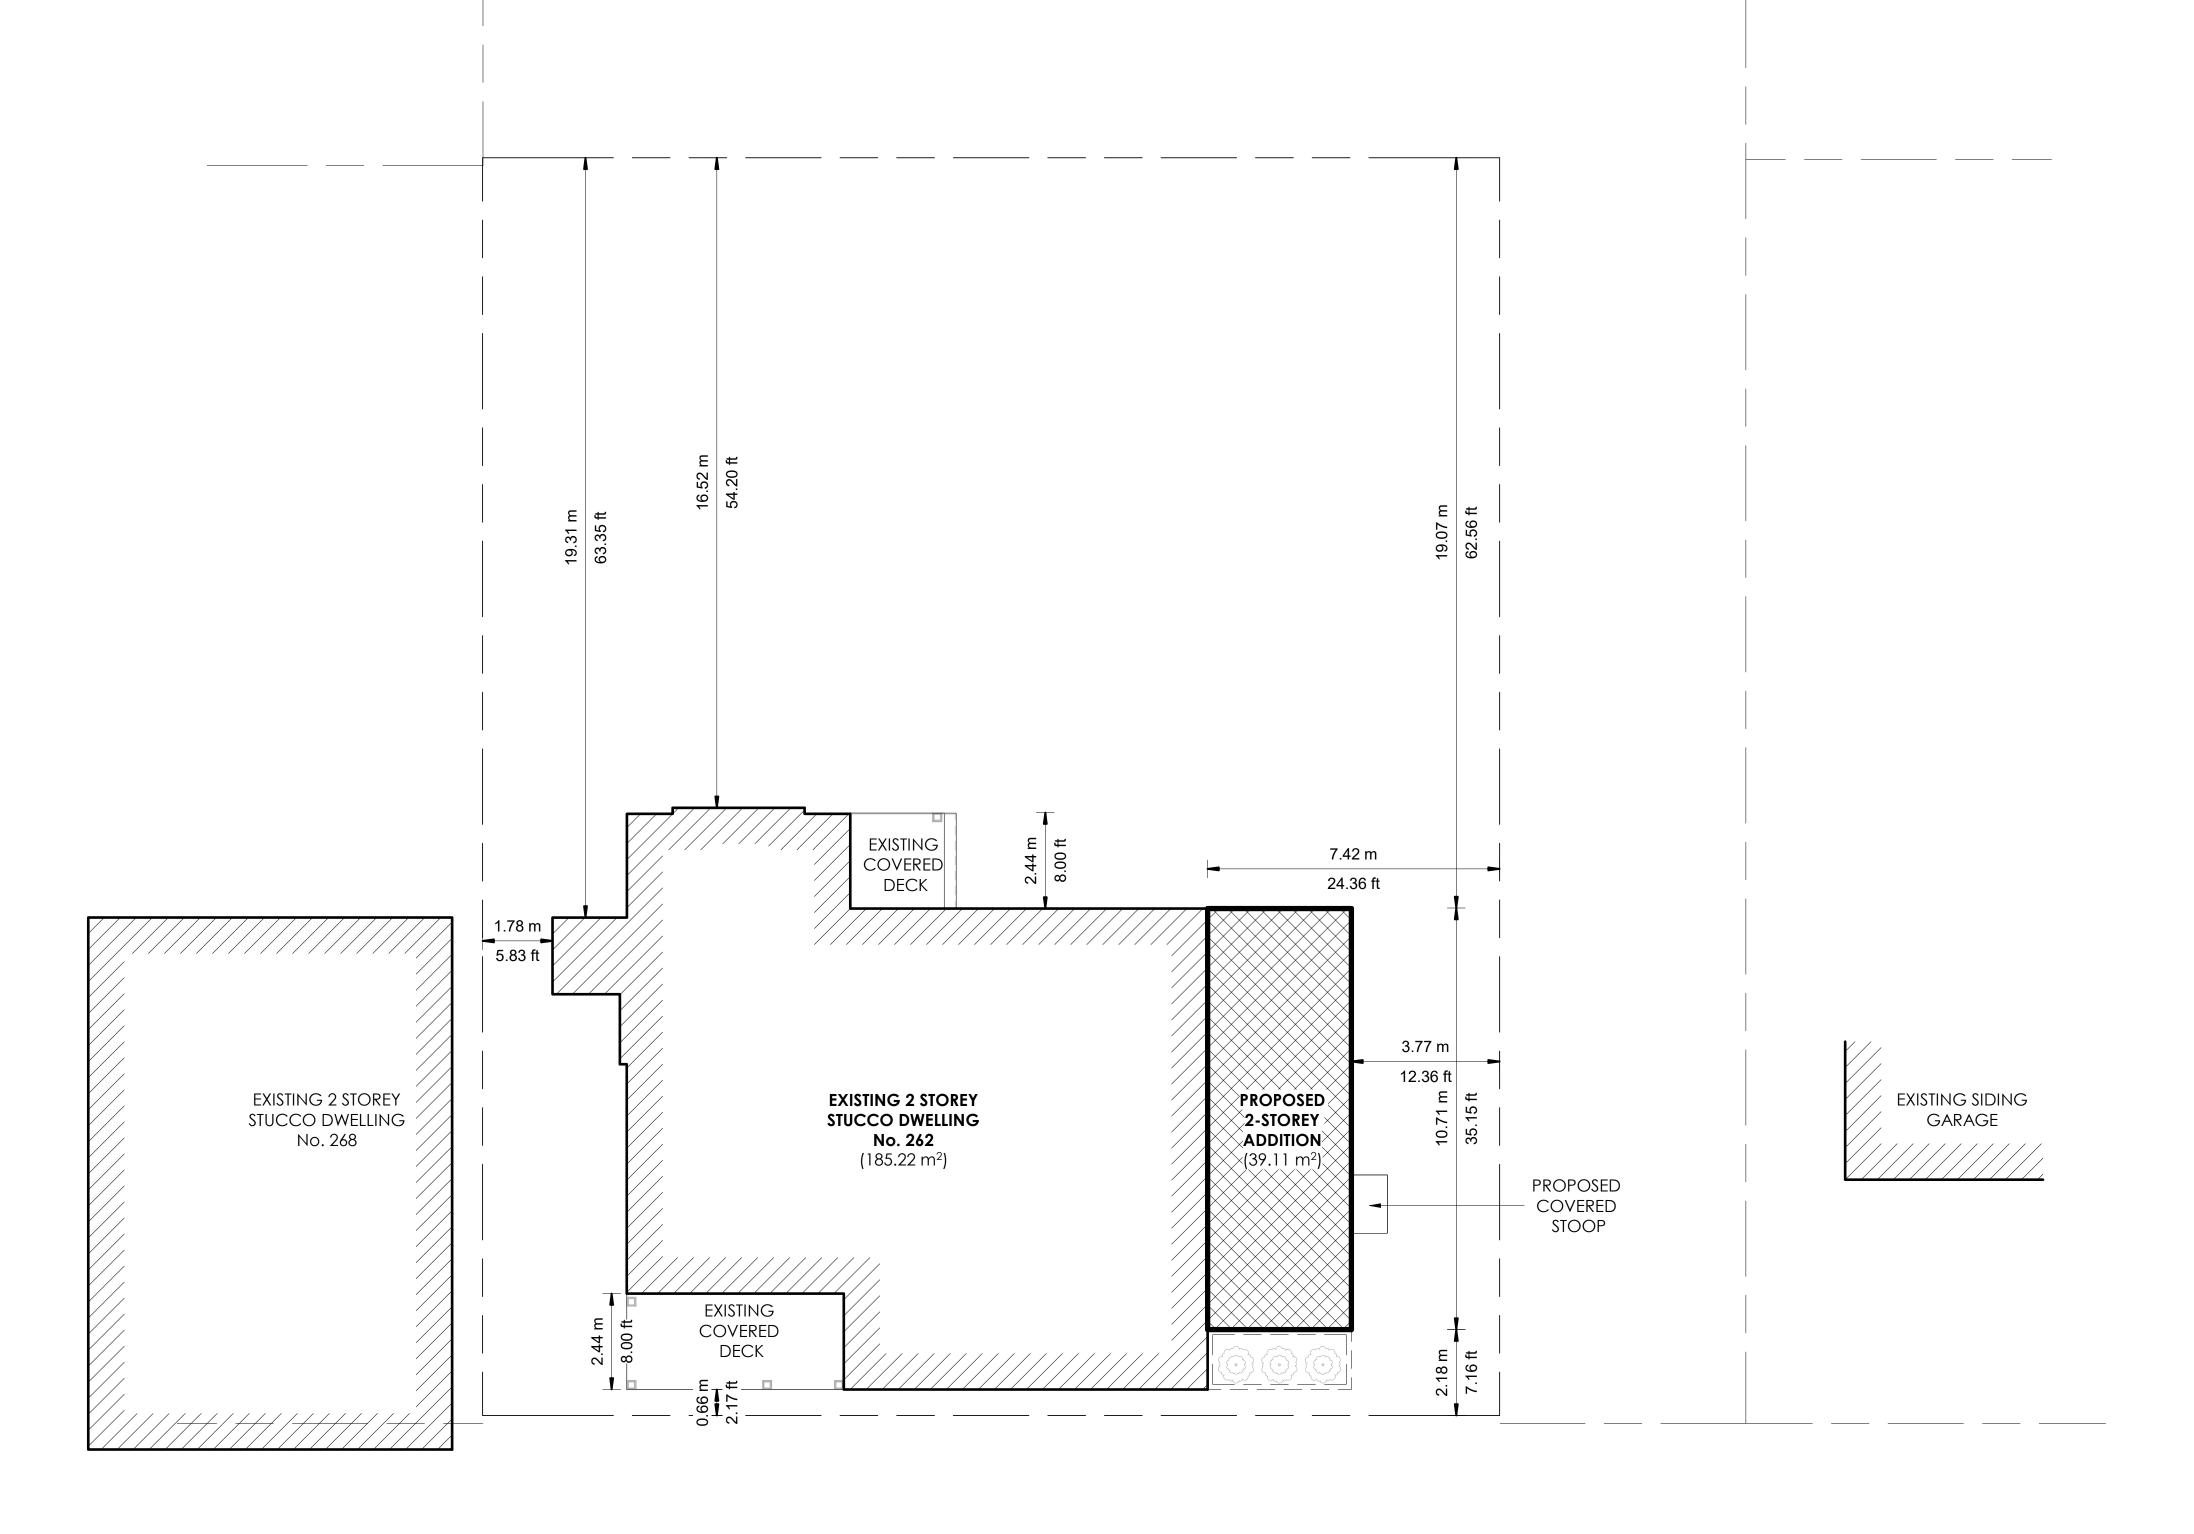

KING STREET

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GENERAL CONSTRUCTION NOTES

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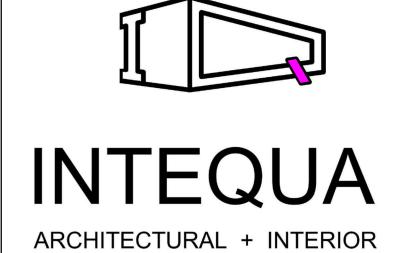
— These notes are included as minimum requirements

— Notes appearing on Architectural or Structural

requirements

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159 QUEBEC AVENUE, TORONTO, ONTARIO M6P 2T9 TEL: (647) 740-5825 E: intequa@gmail.com

Client

Mr. Clive Maile

Project:

TWO-STOREY ADDITION

Addres

262 King Street, Oakville ON L6J 1B7

Drawing Title

SITE STATS

LOT AREA
EX. BUILDING FOOTPRINT
EXISTING COVERED DECKS

NEW GFA CALCULATIONS GROUND FLOOR AREA SECOND FLOOR AREA TOTAL GFA

NEW ADDITION TOTAL AREA

SETBACKS NORTH (Front) EAST SOUTH (Rear) WEST 826.36 m² 185.22 m² 19.70 m² 39.11 m² 243.97 m² (29.53%)

> 0.67 m (EXISTING) 3.77 m (PROPOSED) 16.51 m (EXISTING) 1.77 m (EXISTING)

135.04 m² (1,453.56 FT²) 173.12 m²(1,863.45 FT²) 308.16 m² (3,317.01 FT²) = (37.29%) SITE PLAN

230503


File Application #

Scale 1/8" = 1'-0"

Date September 30, 2024

Project number



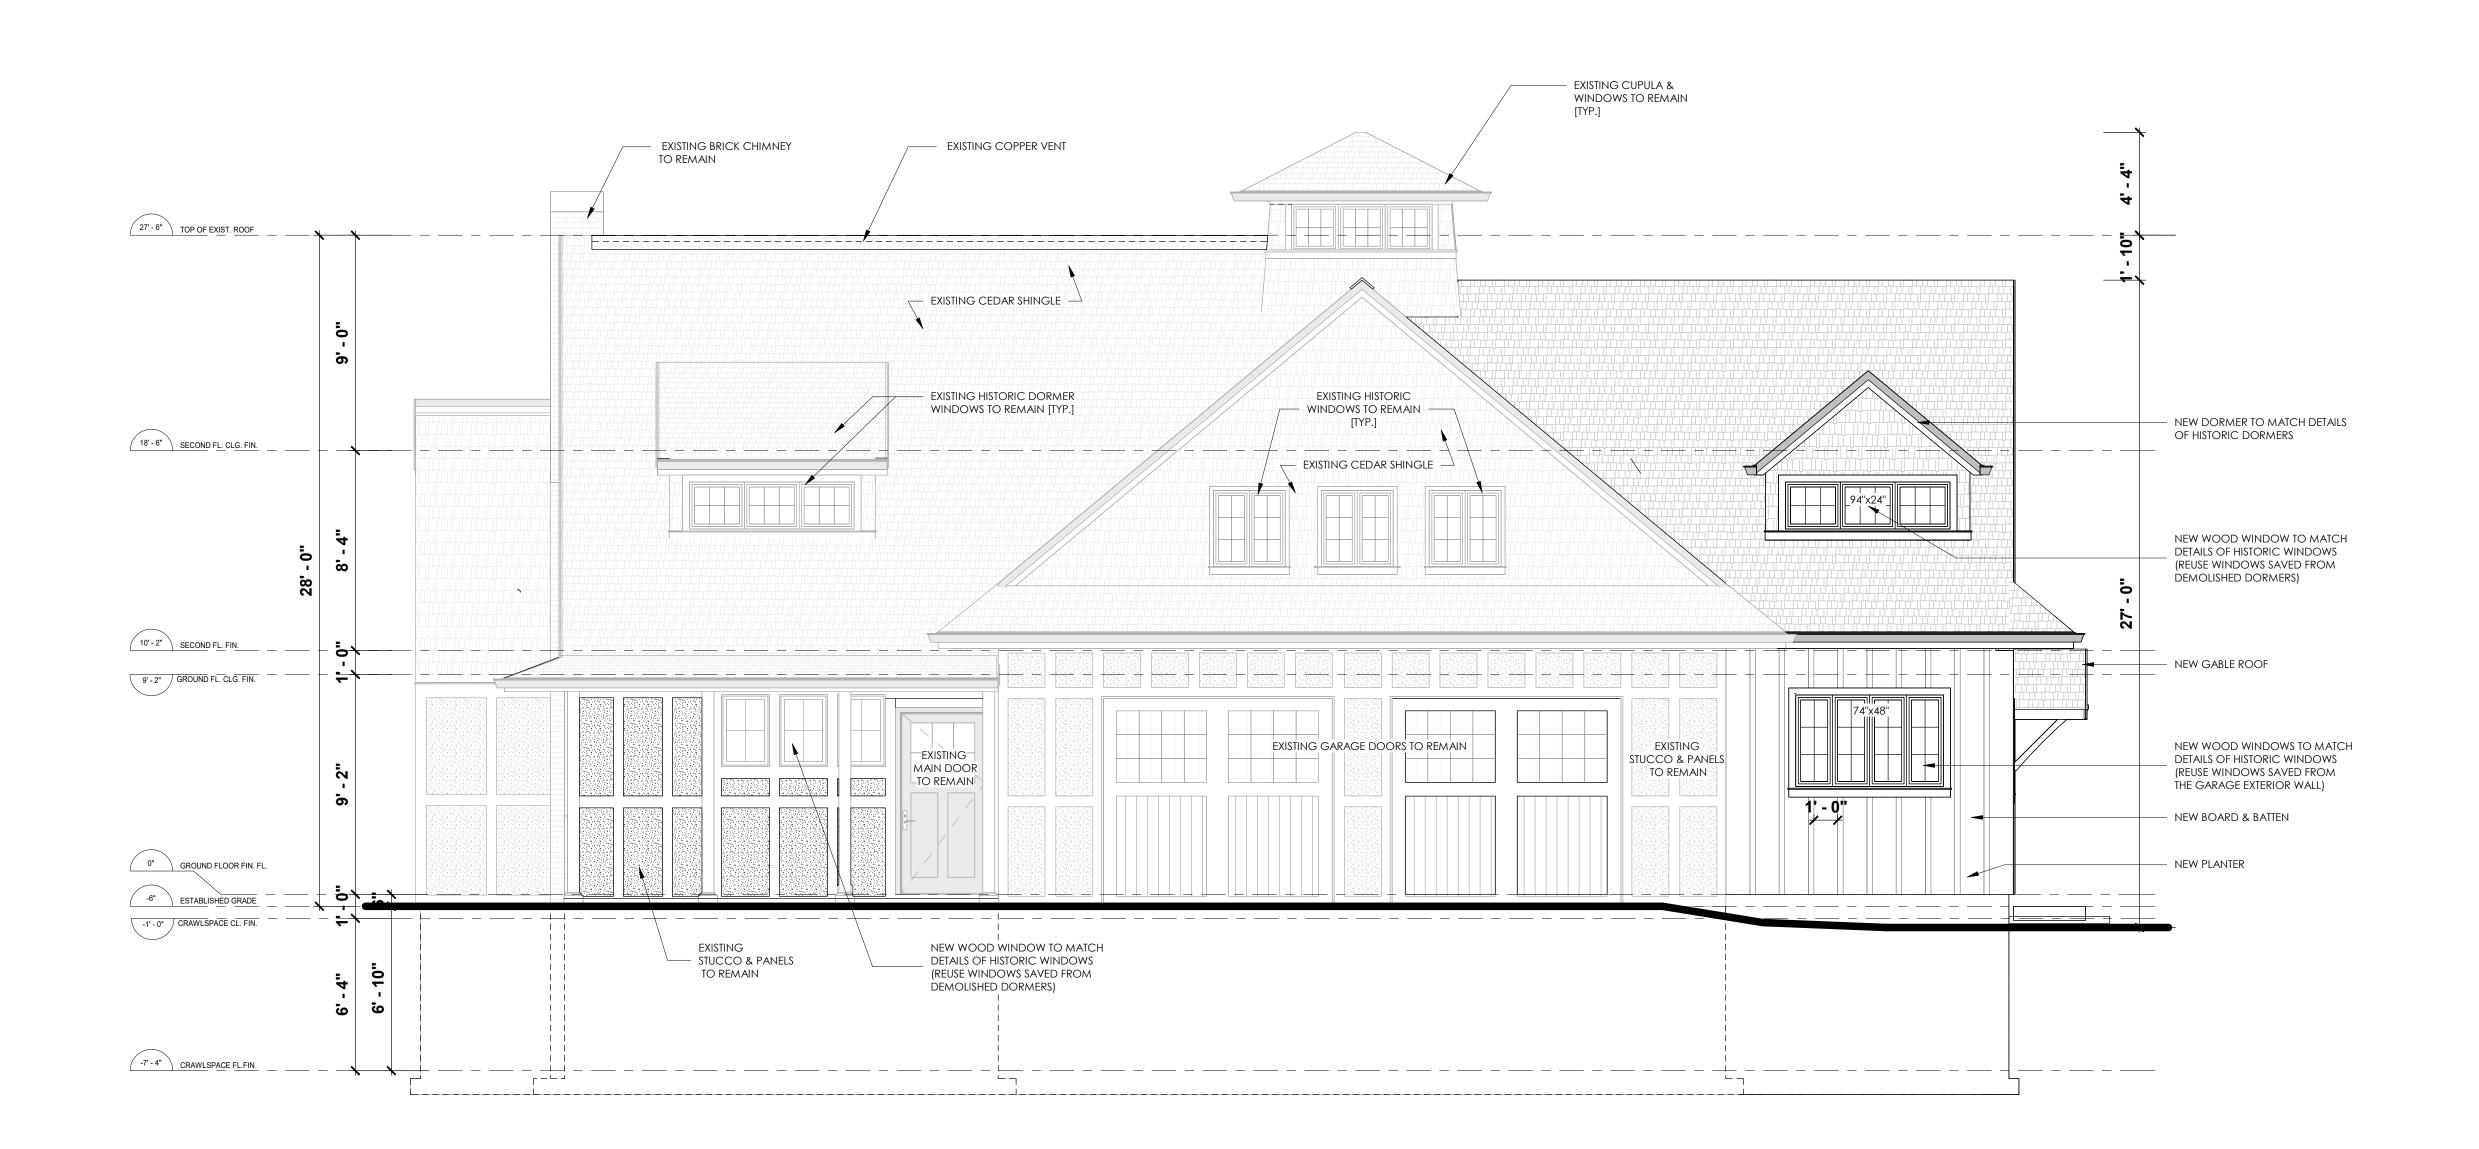

2 PROPOSED NORTH ELEVATION (FRONT)
A200 1/4" = 1'-0"

CONTRACTOR SHALL CHECK AND VERIFY ALL DIMENSIONS ON SITE. ALL DRAWINGS ARE THE PROPERTY OF THE DESIGNER AND MAY NOT BE USED WITHOUT HIS PERMISSION. THIS DRAWING IS NOT TO BE USED FOR CONSTRUCTION UNTIL COUNTERSIGNED BY THE THE DESIGNER. DRAWINGS ARE NOT TO BE SCALED.

GENERAL CONSTRUCTION NOTES

All construction to comply with requirements of the Ontario Building Code (OBC) — Latest edition. — These notes are included as minimum

— Notes appearing on Architectural or Structural drawings shall supersede these notes. Report discrepancies immediately.

INTEQUA ARCHITECTURAL + INTERIOR

159 QUEBEC AVENUE, TORONTO, ONTARIO M6P 2T9 TEL: (647) 740-5825 E: intequa@gmail.com

Mr. Clive Maile

TWO-STOREY ADDITION

262 King Street, Oakville ON L6J 1B7

A200

Drawing Title


NORTH ELEVATION (FRONT)

File Application #

1/4" = 1'-0"

Date September 30, 2024

Project number 230503

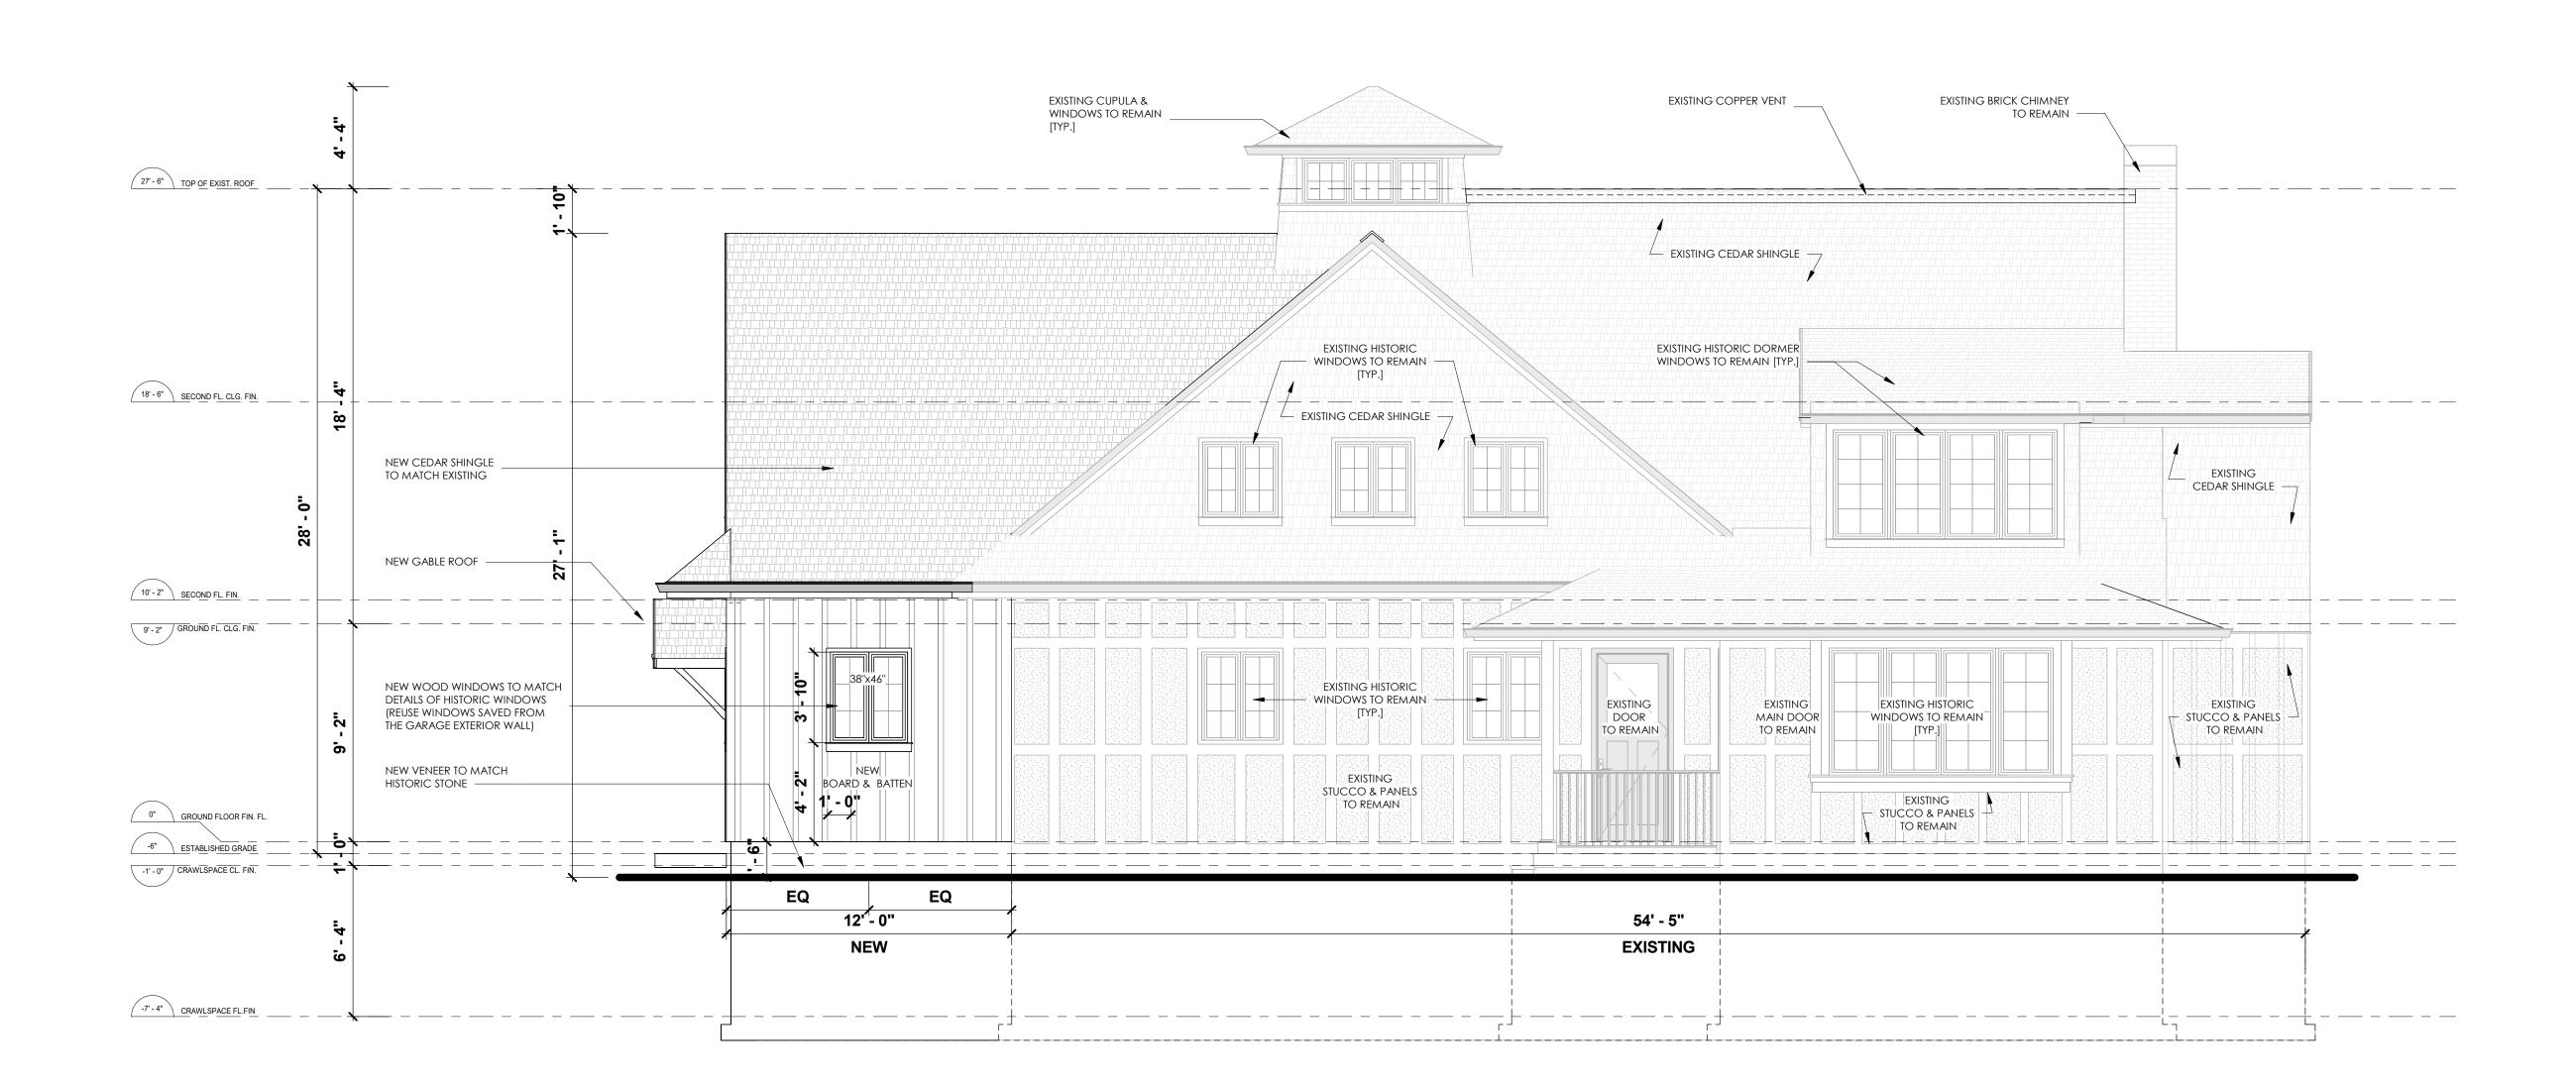

1 PROPOSED SOUTH ELEVATION (REAR)
A210 1/4" = 1'-0"

CONTRACTOR SHALL CHECK AND VERIFY ALL DIMENSIONS ON SITE. ALL DRAWINGS ARE THE PROPERTY OF THE DESIGNER AND MAY NOT BE USED WITHOUT HIS PERMISSION. THIS DRAWING IS NOT TO BE USED FOR CONSTRUCTION UNTIL COUNTERSIGNED BY THE THE DESIGNER. DRAWINGS ARE NOT TO BE SCALED.

GENERAL CONSTRUCTION NOTES

All construction to comply with requirements of the Ontario Building Code (OBC) — Latest edition.

— These notes are included as minimum requirements

— Notes appearing on Architectural or Structural drawings shall supersede these notes.

Report discrepancies immediately.





159 QUEBEC AVENUE, TORONTO, ONTARIO M6P 2T9 TEL: (647) 740-5825 E: intequa@gmail.com

Client:

Mr. Clive Maile

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TWO-STOREY ADDITION

Addres

262 King Street, Oakville ON L6J 1B7

Drawing T

SOUTH ELEVATION (REAR)


File Application #

Scale 1/4" = 1'-0"

Date September 30, 2024

ber 30, 2024 A210

Project number 230503

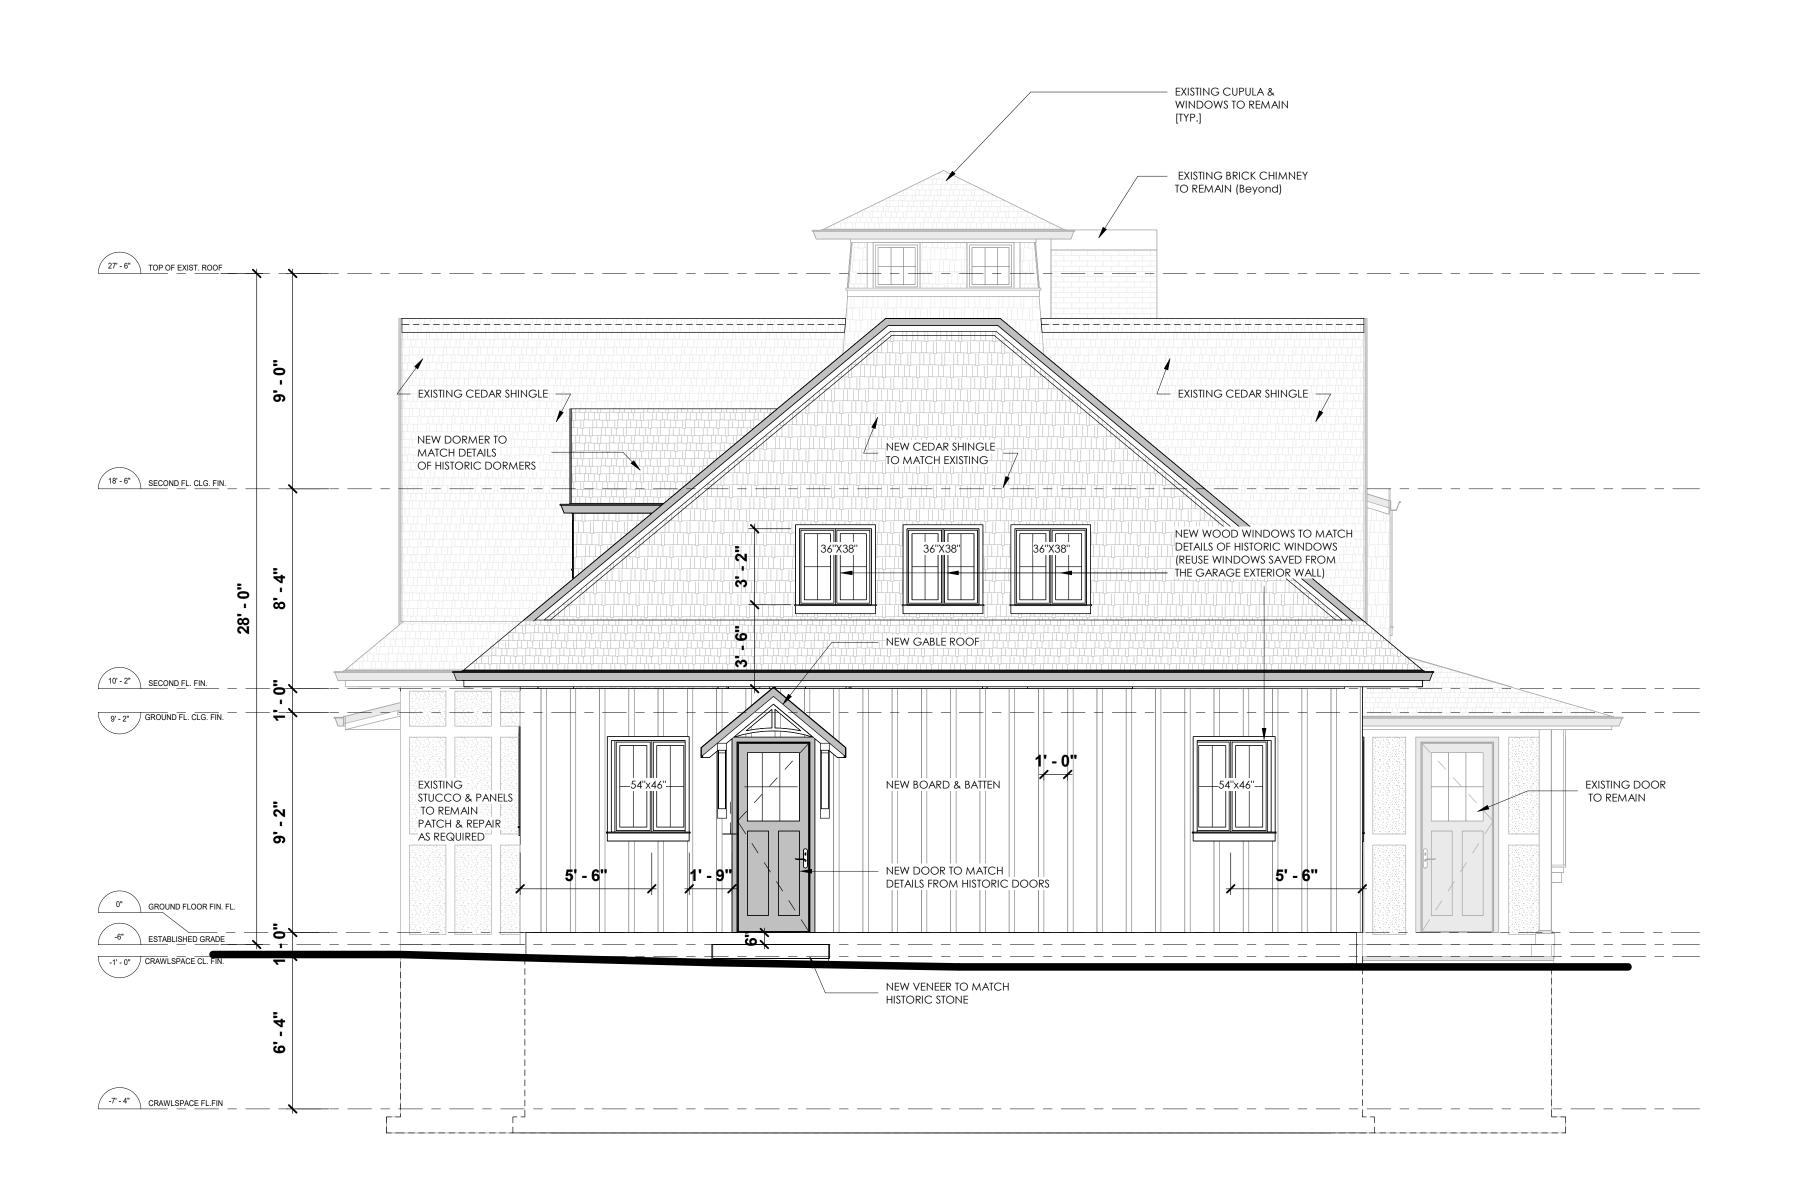



CONTRACTOR SHALL CHECK AND VERIFY ALL DIMENSIONS ON SITE. ALL DRAWINGS ARE THE PROPERTY OF THE DESIGNER AND MAY NOT BE USED WITHOUT HIS PERMISSION. THIS DRAWING IS NOT TO BE USED FOR CONSTRUCTION UNTIL COUNTERSIGNED BY THE THE DESIGNER. DRAWINGS ARE NOT TO BE SCALED.

GENERAL CONSTRUCTION NOTES

All construction to comply with requirements of the Ontario Building Code (OBC) — Latest edition.


— These notes are included as minimum requirements

— Notes appearing on Architectural or Structural

requirements

— Notes appearing on Architectural or Structural drawings shall supersede these notes.

— Report discrepancies immediately.

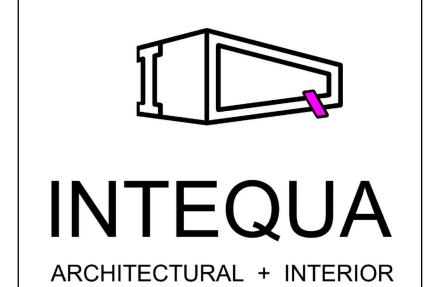

159 QUEBEC AVENUE, TORONTO, ONTARIO M6P 2T9 TEL: (647) 740-5825 E: intequa@gmail.com

Clien

Mr. Clive Maile

. .

TWO-STOREY ADDITION

Addres

262 King Street, Oakville ON L6J 1B7

Drawing Title

WEST ELEVATION (LEFT)


File Application #

Scale 1/4" = 1'-0"

Date September 30, 2024

Project number 230503

30, 2024 A220

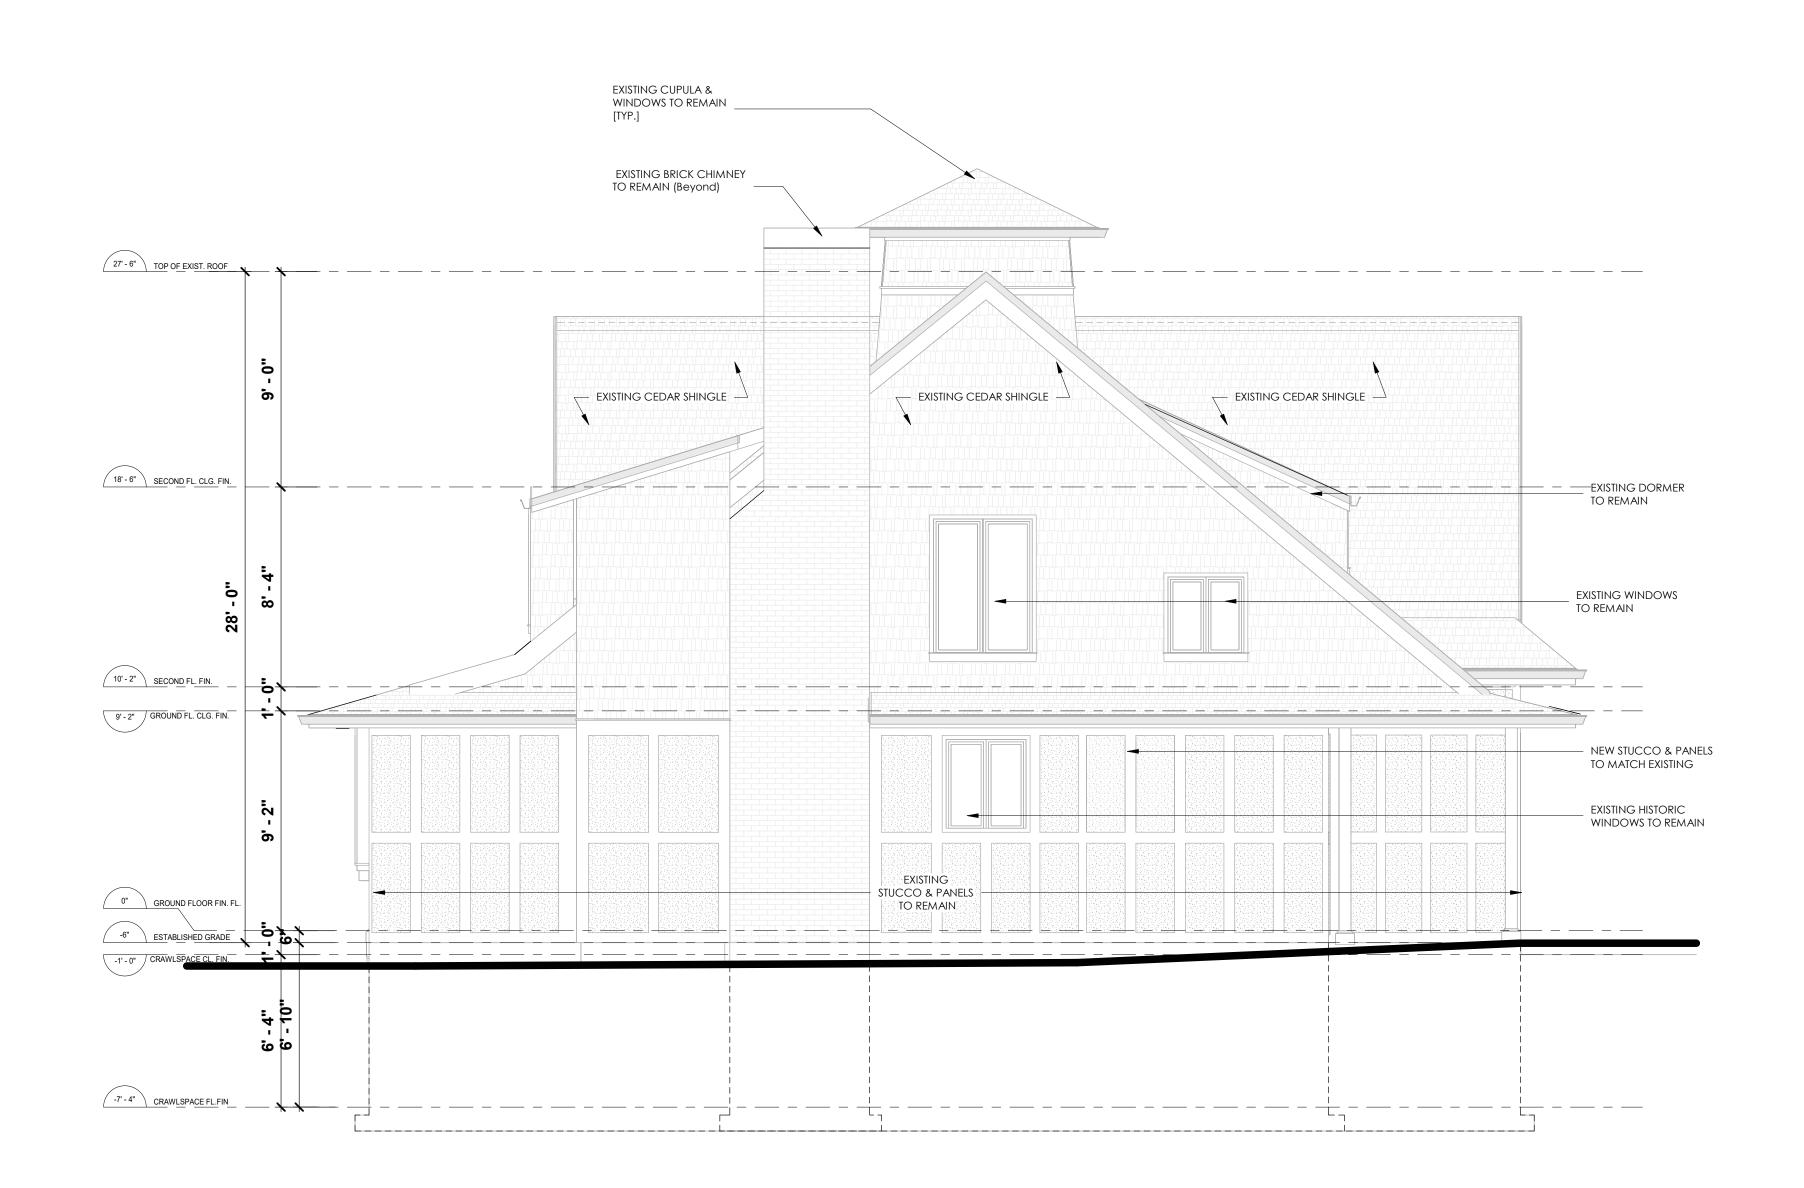

PROPOSED EAST ELEVATION
A230 1/4" = 1'-0"

CONTRACTOR SHALL CHECK AND VERIFY ALL DIMENSIONS ON SITE. ALL DRAWINGS ARE THE PROPERTY OF THE DESIGNER AND MAY NOT BE USED WITHOUT HIS PERMISSION. THIS DRAWING IS NOT TO BE USED FOR CONSTRUCTION UNTIL COUNTERSIGNED BY THE THE DESIGNER. DRAWINGS ARE NOT TO BE SCALED.

GENERAL CONSTRUCTION NOTES

All construction to comply with requirements of the Ontario Building Code (OBC) — Latest edition.

— These notes are included as minimum requirements

— Notes appearing on Architectural or Structural

Notes appearing on Architectural or Structure drawings shall supersede these notes.
Report discrepancies immediately.

INTEQUA

ARCHITECTURAL + INTERIOR

159 QUEBEC AVENUE, TORONTO, ONTARIO M6P 2T9 TEL: (647) 740-5825 E: intequa@gmail.com

Clien

Mr. Clive Maile

Project:

TWO-STOREY ADDITION

Addres

262 King Street, Oakville ON L6J 1B7

Drawing Title

EAST ELEVATION (RIGHT)

File Application #

Scale 1/4" = 1'-0"

Date September 30, 2024

Project number 230503

A230



Permit Application Update - Zoning

June 27, 2024

Alam Makur Intequa Designs 159 Quebec Ave , Unit Toronto, ON, M6P 2T9

Permit Application Number: 24 - 161729

Project Location: 262 King St , Oakville, ON, L6J1B7

This is a progress update on the status of your permit application. The zoning examination is complete and we are providing courtesy notification of the deficiencies identified to date. Additional required examinations are in progress.

Once all examinations are complete, you will receive a refusal letter summarizing all deficiency comments. At that time, you will be eligible to resubmit your application with the deficiencies addressed. Your resubmission **must address all comments** identified by all disciplines and be accompanied by a detailed written response indicating how each item has been resolved. **Please do not resubmit materials until the refusal letter is issued.**

Please be aware of the following:

- When amending plans, be mindful of the impact of changes to associated drawings as they must coordinate and be consistent. You may need to contact various members of your design team to coordinate these changes. Be proactive, look ahead and see the impact the change makes to the entirety of your project.
- 2. Approved drawings by other town departments/approval agencies must match those submitted for building permit (i.e. Site Plan, Development Engineering, Conservation Halton, etc...).
- The continued review of your application may result in additional comments identified by other disciplines within the building permit process. You will be notified once all required examinations are complete and you are eligible to resubmit.

For general inquiries, please contact buildingrequests@oakville.ca or 905-845-6601 ext. 7377

For questions about specific deficiency items, please feel free to contact me.

Gonzalo Marco Zoning Examiner

Email: gonzalo.marco@oakville.ca

ZONING has identified the following comments that need to be addressed prior to resubmission. Hold all resubmission materials until refusal letter is issued:

- **1. Front Yard Setback** Oakville Zoning By-Law 2014-014 Section 15.11.1 (a): Minimum required front yard setback is 6.0m. The proposed front yard setback to the new addition is 2.38m.
- 2. Lot Coverage Oakville Zoning By-Law 2014-014 Section 15.11.1 (c): Maximum lot coverage for all buildings is 25%. The proposed lot coverage is 29.74% (245.8m²)
- **3. Residential Floor Area** Oakville Zoning By-Law 2014-014 Section 15.11.1 (h): The maximum residential floor area for a dwelling having two or more storeys is 30% of the lot area. The proposed residential floor area is 37.62% (310.91m²)

Attn: Heritage Department

Re proposals 262 King Street.

I live at Trafalgar Road and I can clearly see Mr Maile's house across my back garden.

I love living in the heritage area of Oakville and I enjoy looking at the other houses when I walk through the neighbourhood. Mr Maile has shown me his plans and renderings for the addition and I have no objection.

February 19, 2024.

NAME:

IAN MCKAY

ADDRESS:

KING ST, DAKVILLE

I/WE HAVE SEEN THE PLANS FOR THE PROPOSED ADDITION TO 262 KING STREET, OAKVILLE AND I WE HAVE NO OBJECTIONS TO THE ADDITION.

DATE: FEB 18 2024

SIGNATURE:

NAME: DONNA WARD

KING. ST. ADDRESS:

I/WE HAVE SEEN THE PLANS FOR THE PROPOSED ADDITION TO 262 KING STREET , OAKVILLE AND I WE HAVE NO OBJECTIONS TO THE ADDITION.

DATE: Feb. 19/24
SIGNATURE: Juland

RE: 262 King Street

February 5, 2024

Having reviewed the plans for the proposed addition at 262 King Street, I have no objections to the plans as provided.

Please note my house is located at King Street which is to the immediate west of the Maile residence. Once the small addition is completed the rendering clearly shows that the addition still leaves a substantial open space between both properties.

Sincerely,

Christine Markus

Feb. 5/24

NAME:

ADDRESS:

King

I/WE HAVE SEEN THE PLANS FOR THE PROPOSED ADDITION TO 262 KING STREET, OAKVILLE AND I WE HAVE NO OBJECTIONS TO THE ADDITION.

DATE:

Feb 19/2004

SIGNATURE:

February 5, 2024

Attention: Town of Oakville Heritage Department

Re: Heritage Permit Application for 262 King Street

Town of Oakville

To Whom it May Concern,

My home is located at Dunn Street, which is directly to the North and in full view of the Maile residence at 262 King Street.

I have reviewed the plans for the addition and I have no objections. For the record, I previously owned the subject property at 262 King Street prior to the Maile's and I am in complete support of the work the Maile's are proposing.

I believe by looking at the artist's rendering that it still keeps the same feel as the subject property. In fact, the new rendering looks more like the original structure with a main floor room and windows that were later converted into a garage door. The new proposal restores the look of the home.

Best Regards,

Jennifer Graham

NAME: Kene Lawruk.

ADDRESS:

DUNIN ST.

I/WE HAVE SEEN THE PLANS FOR THE PROPOSED ADDITION TO 262 KING STREET , OAKVILLE AND I WE HAVE NO OBJECTIONS TO THE ADDITION.

DATE:

Tub. 22.2024.

SIGNATURE:

Turelhauren

NAME: LIZ GALLOWAY

ADDRESS:

King Street

Elfalloway.

I/WE HAVE SEEN THE PLANS FOR THE PROPOSED ADDITION TO 262 KING STREET, OAKVILLE AND I WE HAVE NO OBJECTIONS TO THE ADDITION.

DATE:

20 Feb 2024

SIGNATURE:

Page 101 of 191

NAME: BRIAN ENNS
ADDRESS: Allan 5-1.

I/WE HAVE SEEN THE PLANS FOR THE PROPOSED ADDITION TO 262 KING STREET, OAKVILLE AND I WE HAVE NO OBJECTIONS TO THE ADDITION.

DATE: Feb 20/24

SIGNATURE:

NAME: D. Saiene GBBERD + ELIZABETH HIBBERD

ADDRESS: Reynolds St. L65357
Oakville ONT

I/WE HAVE SEEN THE PLANS FOR THE PROPOSED ADDITION TO 262 KING STREET, OAKVILLE AND I WE HAVE NO OBJECTIONS TO THE ADDITION.

DATE: Feb 20/24

SIGNATURE: Schilled Schilled

Notice of Public Hearing Committee of Adjustment Application



File # CAV A/162/2024

Electronic hearing:

By videoconference and live-streaming video on the Town of Oakville's Live Stream webpage at <u>oakville.ca</u> on November 13, 2024 at 7 p.m.

Why am I receiving this notice?

You are receiving this notice because the applicant noted below has submitted a minor variance application to the Town of Oakville. As stipulated by the *Planning Act*, notice must be provided to property owners within 60 metres (200 ft.) of the area to which the application applies. Further details of this application, including drawings, can be viewed online at <u>Agendas & Meetings (oakville.ca)</u>.

Applicant and property information:

Applicant / Owner	Authorized Agent	Subject Property
H. Maile	Alam Makur INTEQUA DESIGNS 159 QUEBEC Ave TORONTO ON, CANADA M6P 2T9	262 King St PLAN 1 PT BLK 24 PT LOT B RP 20R20862 PART 1

Zoning of property: RL3 sp:11, Residential

Variance request:

Under Section 45(1) of the *Planning Act*, the applicant is requesting the Committee of Adjustment to authorize a minor variance to permit the construction of a two-storey addition to the existing dwelling on the subject property proposing the following variances to Zoning By-law 2014-014:

No.	Current	Proposed
1	Table 15.11.1 a)	To decrease the minimum front yard to 2.18 metres.
	The minimum front yard shall be 6.0 metres.	
2	Table 15.11.1 c)	To increase the maximum lot coverage for all
	The maximum lot coverage for all buildings shall	buildings to 29.74%.
	be 25%.	
3	Table 15.11.1 h)	To increase the maximum residential floor area for
	The maximum residential floor area for a	a dwelling having two or more storeys to 37.62%.
	dwelling having two or more storeys shall be	
	30% of the lot area.	

How do I participate if I have comments or concerns?

Submit written correspondence

Although there are no third-party appeal rights, you are entitled to notice and may make written submissions before the application is considered by the Committee of Adjustment. You can send your written comments regarding the application by email (preferred) or regular mail to the Secretary-Treasurer noted below. Include your name, address and application number or address of the property in which you are providing comments. To allow all Committee of Adjustment members the opportunity to review and consider your comments, please provide your written submissions to be received no later than noon the day before the hearing date.

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More information:

Town departments and agency comments regarding this application will be available online at <u>Agendas & Meetings (oakville.ca)</u> by noon on the Friday before the hearing date.

Notice of decision:

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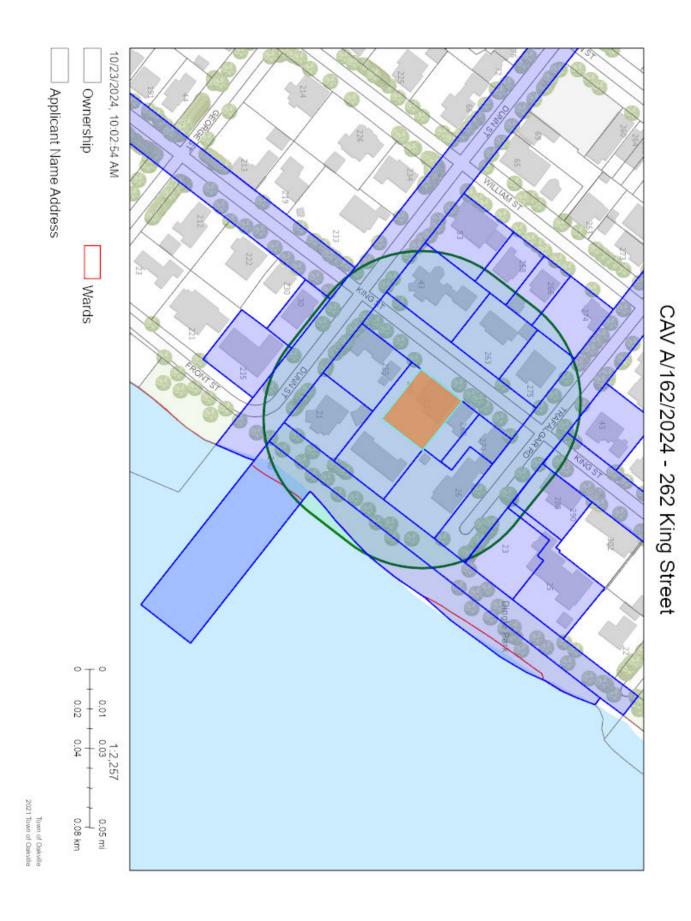
Contact information:


Jen Ulcar Secretary-Treasurer of Committee of Adjustment 1225 Trafalgar Road Oakville, ON L6H 0H3 Phone: 905-845-6601 ext. 1829

Email: coarequests@oakville.ca

Date mailed:

October 29, 2024



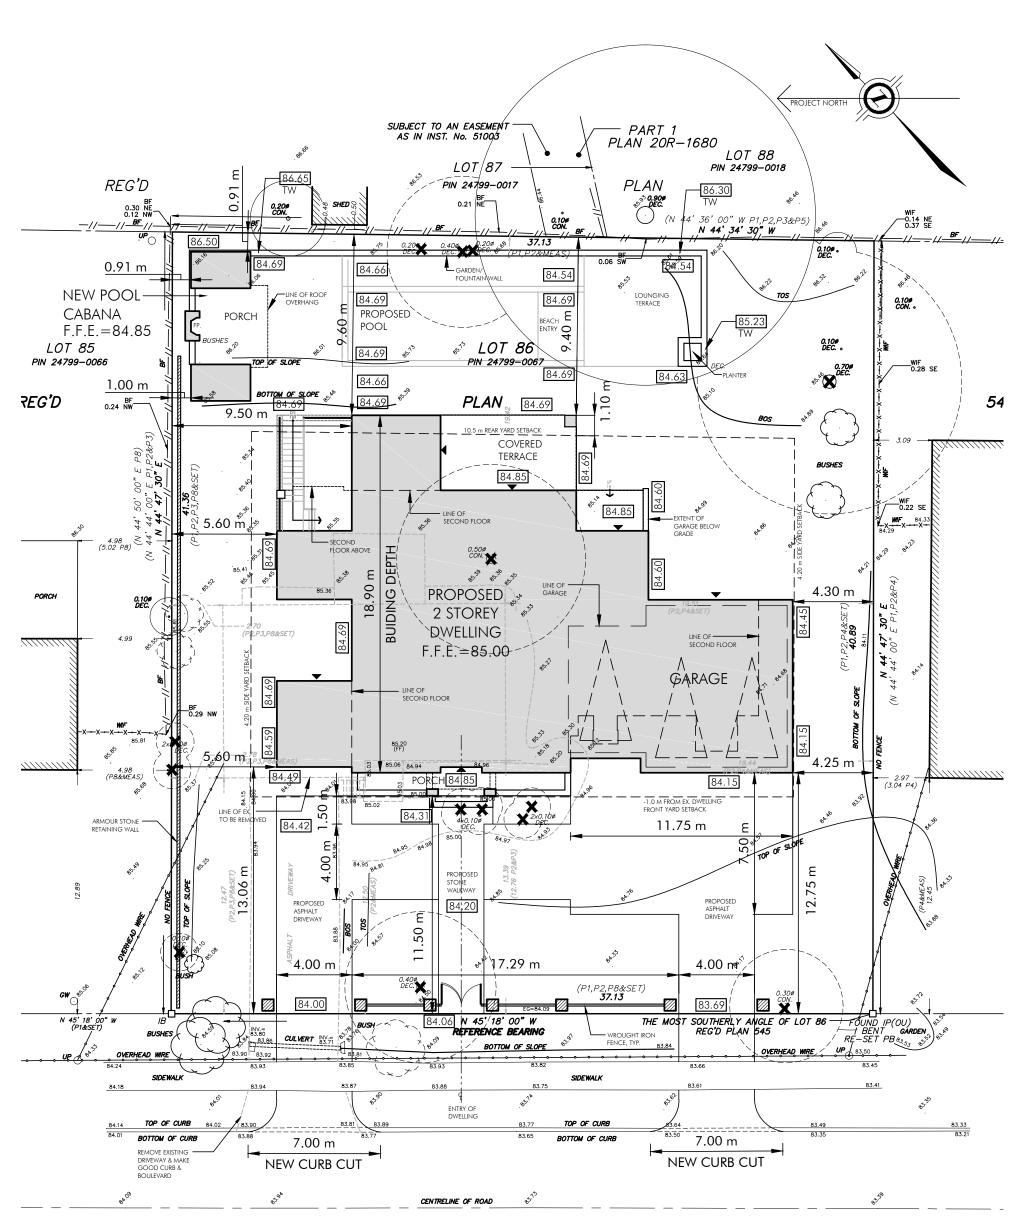

LOT 86

REGISTERED PLAN 545

TOWN OF OAKVILLE,

REGIONAL MUNICIPALITY OF HALTON

AS TAKEN FROM
SURVEY BY

J.H. GELBLOOM SURVEYING LIMITED
ONTARIO LAND SURVEYOR

DATED AUG 22, 2023

AS PROVIDED BY OWNER

WEDGEWOOD DRIVE (BY REG'D PLAN 545) PIN 24799-0134

Proposed New Residence:

221 WEDGEWOOD DRIVE, Oakville


Site Plan - at 1:200

A101 - September 17, 2024





64 Rebecca Street, Oakville Ontario, Canada L6K 1J2 Tel: (905) 842-9191 www.gusricciarchitect.com

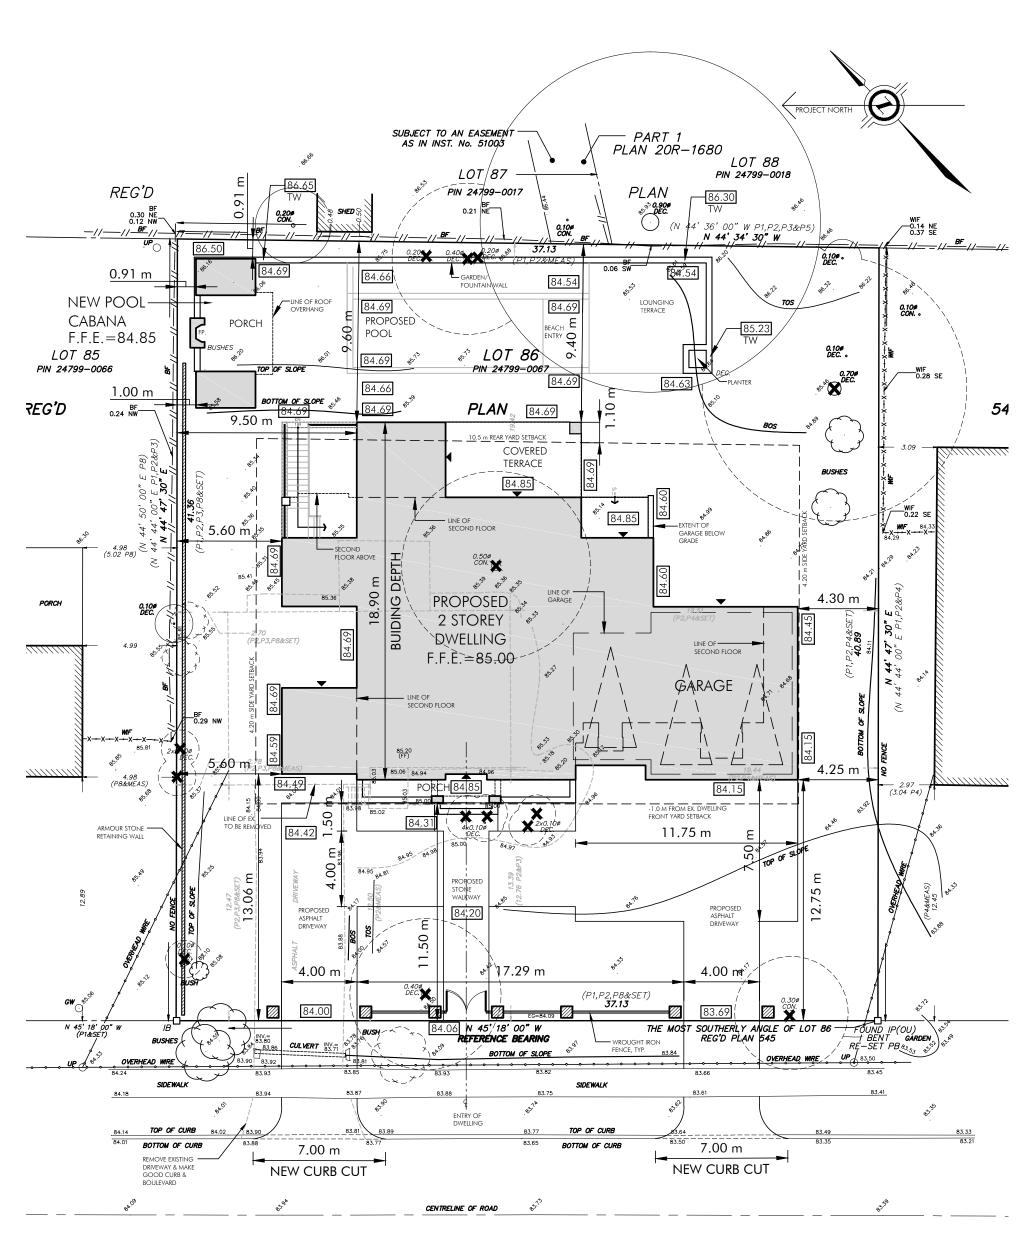

LOT 86

REGISTERED PLAN 545

TOWN OF OAKVILLE,

REGIONAL MUNICIPALITY OF HALTON

AS TAKEN FROM

SURVEY BY

J.H. GELBLOOM SURVEYING LIMITED

ONTARIO LAND SURVEYOR

DATED AUG 22, 2023

AS PROVIDED BY OWNER

WEDGEWOOD DRIVE (BY REG'D PLAN 545) PIN 24799-0134

Proposed New Residence:

221 WEDGEWOOD DRIVE, Oakville


Site Plan - at 1:200

A101 - September 17, 2024





64 Rebecca Street, Oakville Ontario, Canada L6K 1J2 Tel: (905) 842-9191 www.gusricciarchitect.com

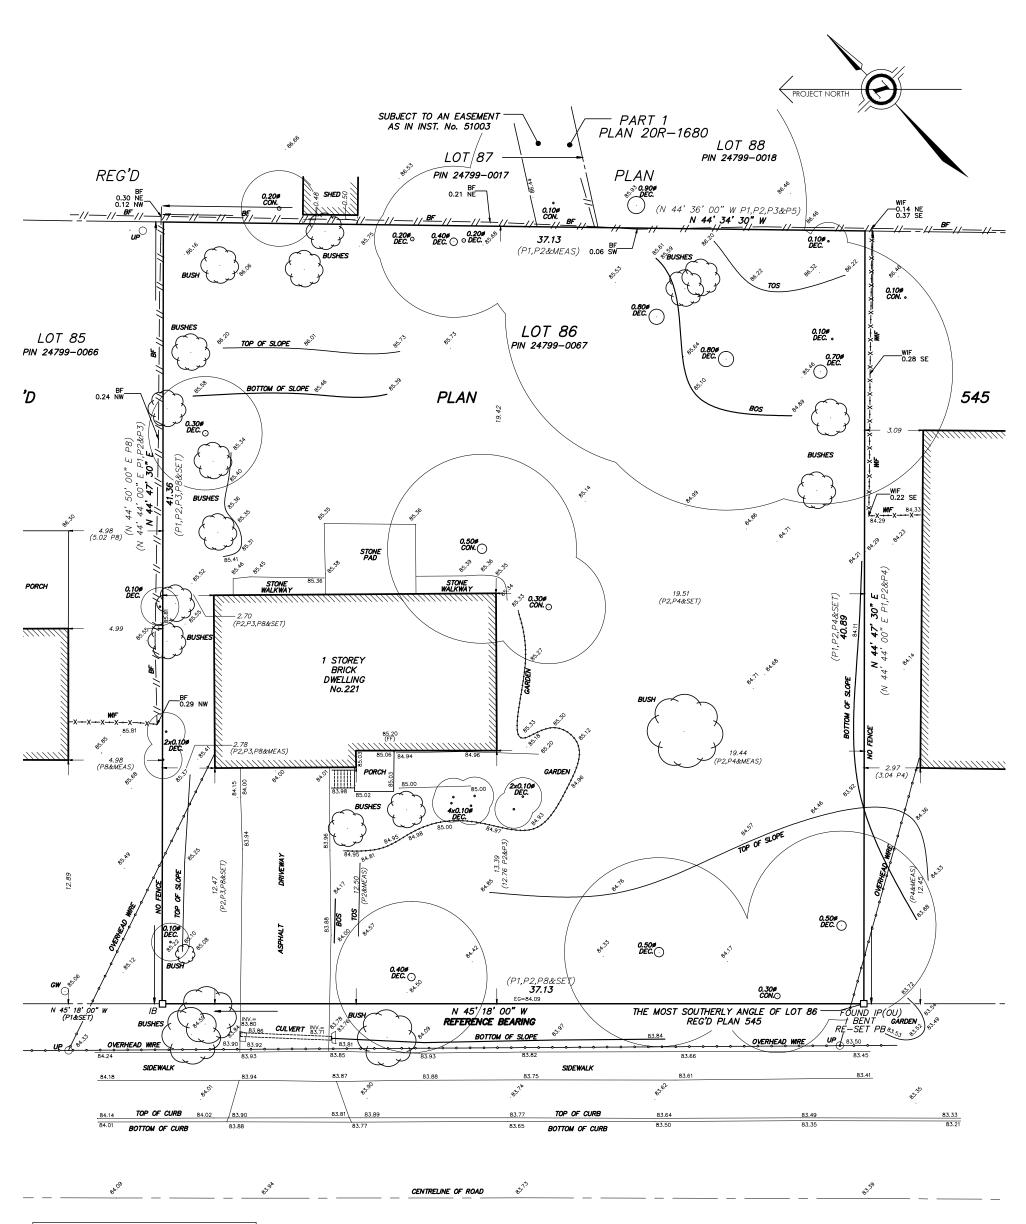

LOT 86

REGISTERED PLAN 545

TOWN OF OAKVILLE,

REGIONAL MUNICIPALITY OF HALTON

AS TAKEN FROM
SURVEY BY

J.H. GELBLOOM SURVEYING LIMITED
ONTARIO LAND SURVEYOR
DATED AUG 22, 2023

AS PROVIDED BY OWNER

WEDGEWOOD DRIVE (BY REG'D PLAN 545) PIN 24799-0134

Proposed New Residence:

221 WEDGEWOOD DRIVE, Oakville

Survey at 1:200

C100 - September 17, 2024





64 Rebecca Street, Oakville Ontario, Canada L6K 1J2 Tel: (905) 842-9191 www.gusricciarchitect.com


	SITE STATIST	I C S			
LOT DESCRIPTION	LOT 86, REGISTERED PLAN 545	TOWN OF OAKVILLE	REGIONAL MUNICIPALITY OF HALTON		
MUNICIPAL ADDRESS	221 WEDGEWOOD DRIVE				
	ZONING REQUIREMENTS		PROPOS NEW	E D	
ZONING	BY-LAW 2014-014 RL1 -0				
LOT AREA	MINIMUM = 1,393.5 m2 (15,000.00 sq.ft.)	existing	1,526.88 m2	(16,435.20 sq.ft.)	
LOT FRONTAGE	MINIMUM = 30.5 m (100.1 ft)		37.13 m	(121.82 ft.)	
FRONT YARD SETBACK	MINIMUM = 11.47 m (37.63 ft) (-1 m LESS THEN EXISTING BUILDING)		11.50 m	(37.73 ft.)	
REAR YARD SETBACK @DWELLING	MINIMUM = 10.5 m (34.45 ft) (1 STOREY EXTENSION LESS THEN OR EQUAL TO 7.50 m IN HEIGHT IS ALLOWED TO EXTEND AN ADDITIONAL 3.00 m INTO REAR YARD PROVIDED INTERIOR SIDE YARD OF 9.00 m ON EITHER SIDE AS PER 6.3.1. (1) - ZONING BY-LAW)	DWELLING SETBACK 1 STORY EXTENSION SIDE YARD SETBACK BUILDING HEIGHT ENCROACHMENT	9.40 m 9.50 m 4.50 m 1.10 m	(30.84 ft.) (31.20 ft.) (14.80 ft.) (3.60 ft.)	
@ACCESSORY BUILDING	MINIMUM = 0.6 m (2.00 ft)		0.91 m	(3.00 ft.)	
SIDE YARD SETBACK (SOUTH)	MINIMUM = 4.20 m (13.80 ft)		4.25 m	(13.90 ft.)	
SIDE YARD SETBACK (NORTH) @DWELLING	MINIMUM = 4.20 m (13.80 ft)		5.60 m	(18.40 ft.)	
@ACCESSORY BUILDING	MINIMUM = 0.6 m (2.00 ft)		0.91 m	(3.00 ft.)	
BUILDING DEPTH	MAXIMUM = 20.0 m (65.60 ft)		19.40 m	(63.60 ft.)	
BUILDING HEIGHT OVERALL/RIDGE	MAXIMUM = 9.00 m (29.53 ft) (from established grade)		9.15 m	(30.00 ft.)	
BUILDING HEIGHT (ACCESSORY BUILDING)	MAXIMUM = 4.00 m (13.12 ft)		3.66 m	(12.00 ft.)	
LOT COVERAGE	MAX = 25% = 381.75 m2 (4,109.10 sq.ft) (INCLUDES ALL AREA COVERED BY A ROOF. EXCLUDES EAVES 0.6 m or LESS & BALCONIES) ACCESSORY BUILDING	PROPOSED DWELLING PROPOSED GARAGE COVERED PORCHES EXPOSED BASEMENT COVERED TERRACE SECOND FLOOR ABOVE	243.70 m2 100.00 m2 5.10 m2 8.20 m2 28.50 m2 9.00 m2	(2,623.30 sq.ft) (1,075.30 sq.ft) (55.00 sq.ft) (88.30 sq.ft) (307.00 sq.ft) (97.40 sq.ft)	
	MAX. LOT COVERAGE SHALL BE THE GREATER OF 5% OF LOT AREA = 76.34 m2 (821.72 sq.ft) or 42.00 m2 (452.10 sq.ft) OF BUILDING AREA.	PROPOSED POOL CABANA	29.50 m2	(317.30 sq.ft)	
		PROPOSED LOT COVERAGE	424.00 m2	(4,563.60 sq.ft) = 27.80 %	
GARAGE AREA	MAX = 56.0 m2 (602.8 sq.ft) (as per 5.8.6 Zoning Bylaw)	PROPOSED GARAGE FLOOR AREA	91.50 m2	(985.00 sq.ft)	
residential floor area	MAX = 29.0% = 404.10 m2 (4,350.00 sq.ft)	PROPOSED MAIN FLOOR PROPOSED SECOND FLOOR	243.70 m2 247.90 m2	(2,623.30 sq.ft) (2,667.80 sq.ft)	
		PROPOSED FLOOR AREA	491.60 m2	(5,291.10 sq.ft) = 32.20 %	
DRIVEWAY WIDTH	9.00 m DRIVEWAY WIDTH	PROP. DRIVEWAY WIDTH	11.75 m	(38.60 ft)	

221 WEDGEWOOD DRIVE, Oakville Site Stats

A102 -September 17, 2024





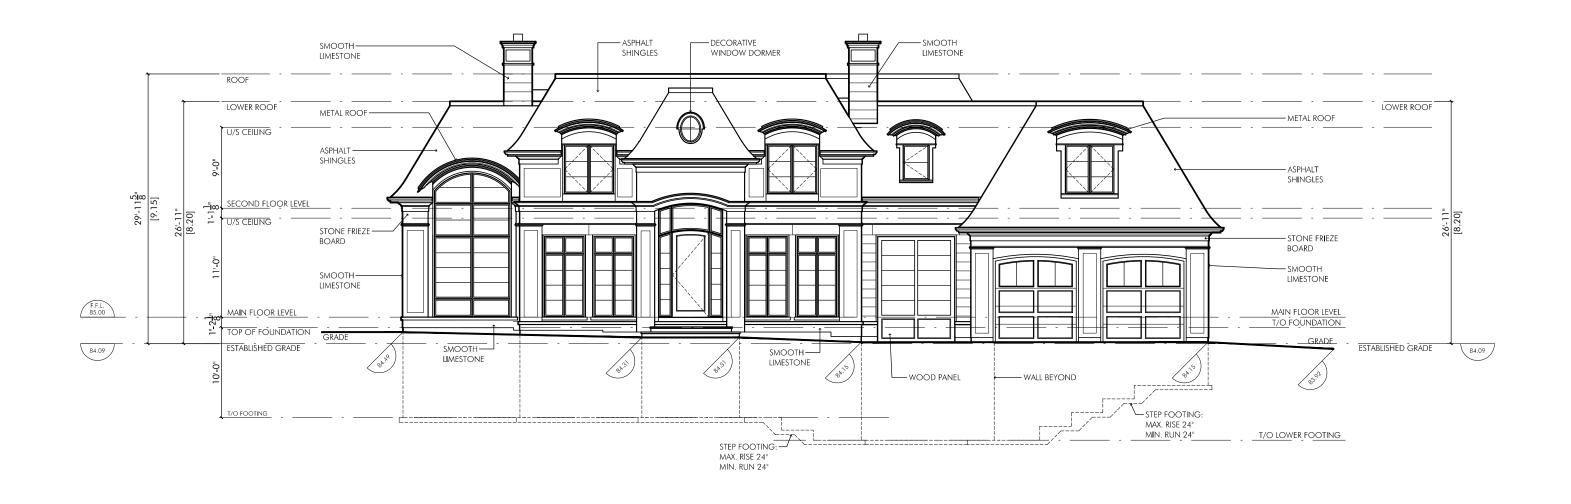


221 WEDGEWOOD DRIVE, Oakville West Elevation at 3/32" = 1'-0"

A200 September 17, 2024





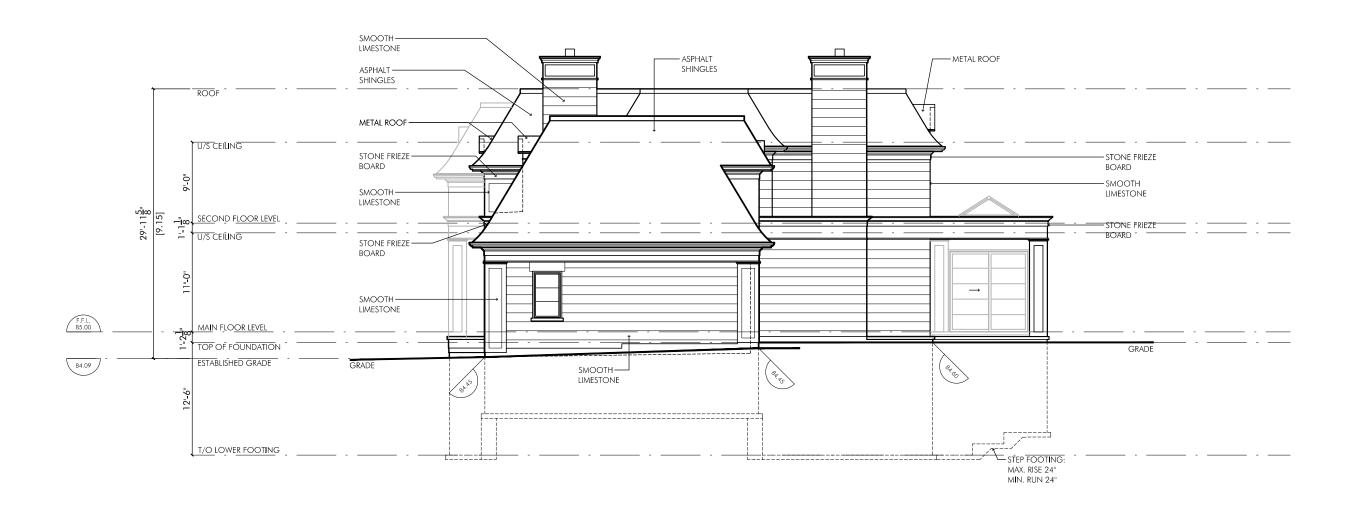

221 WEDGEWOOD DRIVE, Oakville South Elevation at 3/32" = 1'-0"

September 17, 2024








221 WEDGEWOOD DRIVE, Oakville East Elevation at 3/32" = 1'-0"

September 17, 2024 A202





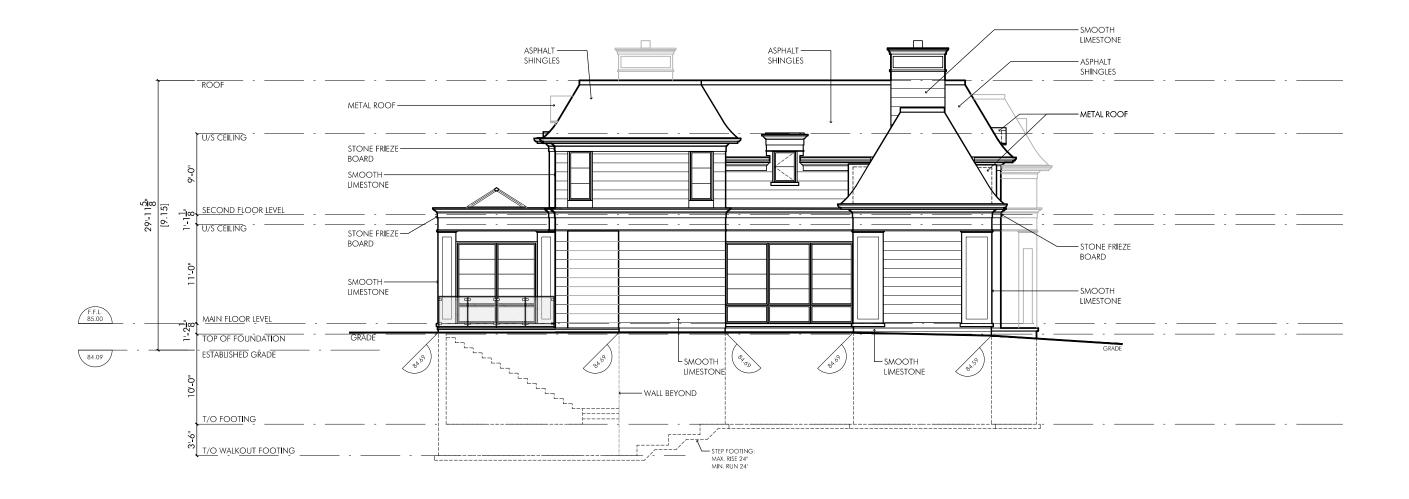


221 WEDGEWOOD DRIVE, Oakville North Elevation at 3/32" = 1'-0"


September 17, 2024 A203





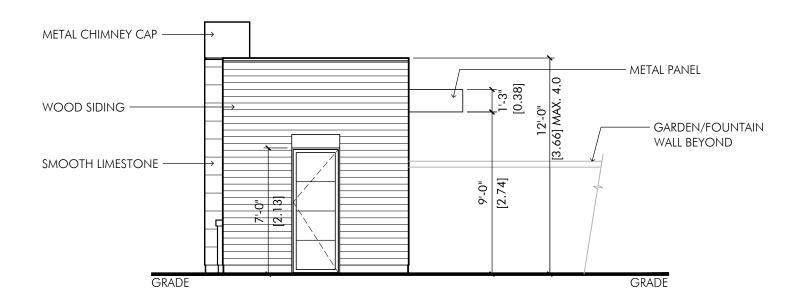

WEST ELEVATION

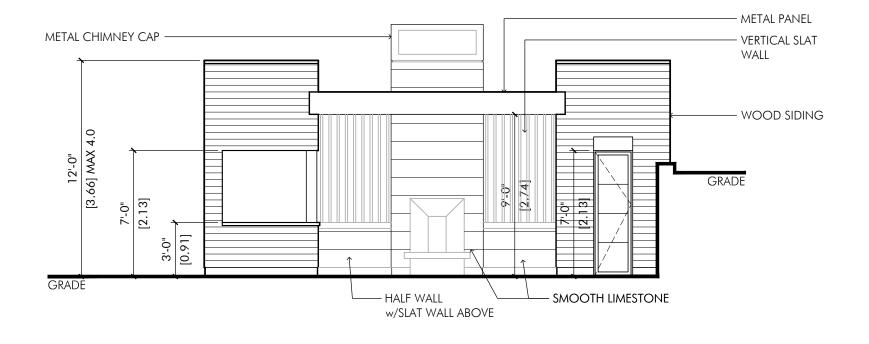

SOUTH ELEVATION


Proposed New Residence:

221 WEDGEWOOD DRIVE, Oakville Cabana Elevations at 3/16" = 1'-0"


Cabana Elevations at 3/16" = 1'-0" A204 - September 17, 2024





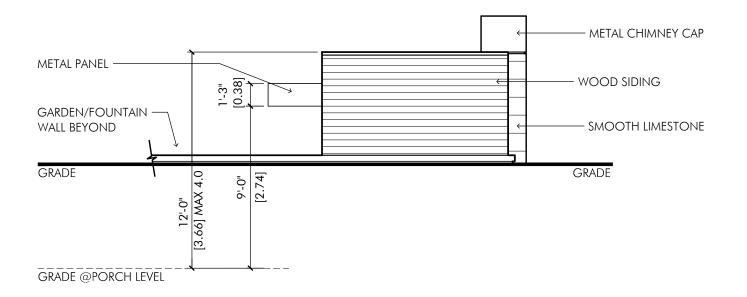

EAST ELEVATION

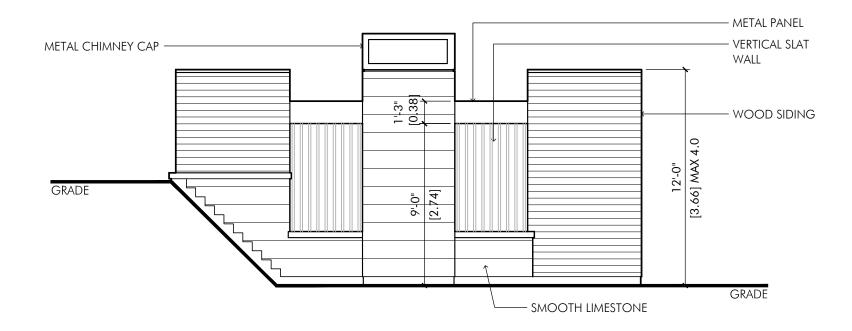

NORTH ELEVATION


Proposed New Residence:

221 WEDGEWOOD DRIVE, Oakville Cabana Elevations at 3/16" = 1'-0"

Cabana Elevations at 3/16" = 1'-0" A205 - September 17, 2024





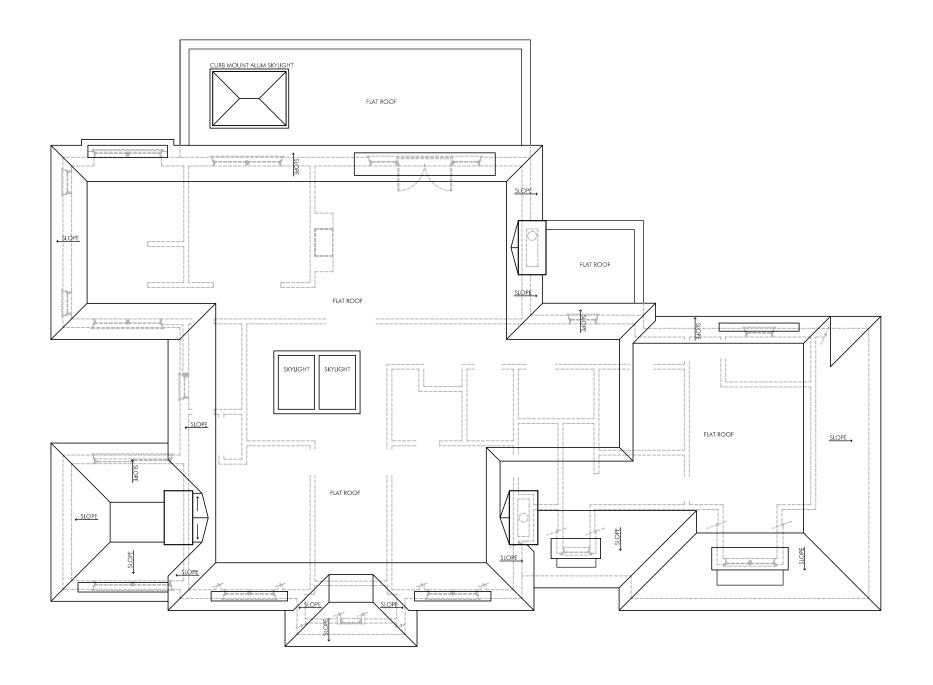


221 WEDGEWOOD DRIVE, Oakville Roof Plan at 3/32" = 1'-0"

September 17, 2024





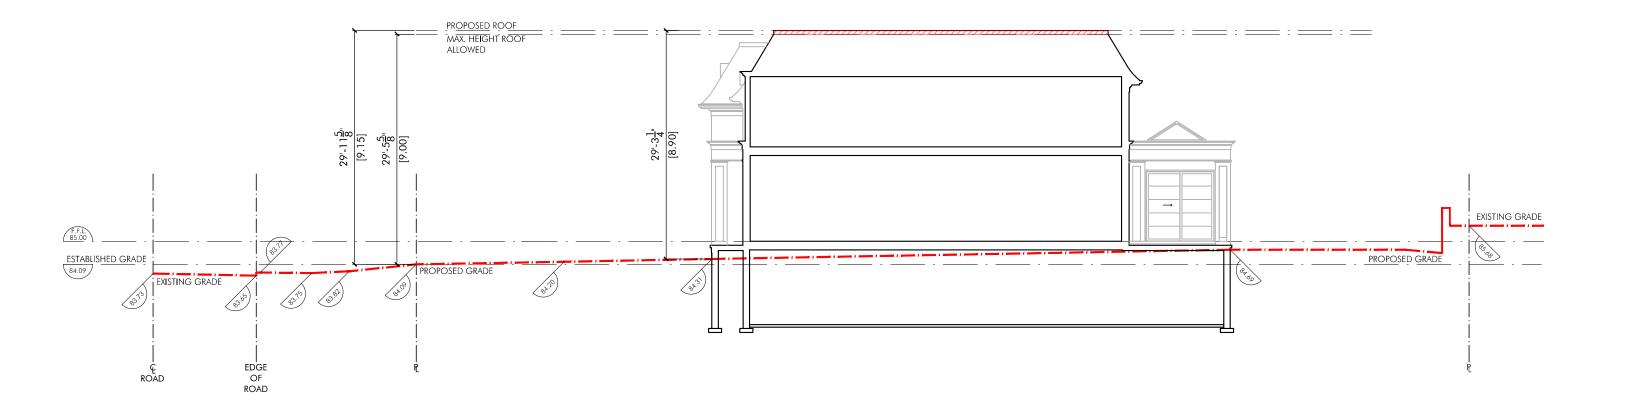

221 WEDGEWOOD DRIVE, Oakville Section Thru Site at N.T.S.

September 17, 2024







221 WEDGEWOOD DRIVE, Oakville Roof Height Schematic (West Elevation) at 3/32" = 1'-0"

September 17, 2024 A401 -







221 WEDGEWOOD DRIVE, Oakville Streetscape

September 17, 2024 R100 -







221 WEDGEWOOD DRIVE, Oakville View To The South

R101 - September 17,2024








221 WEDGEWOOD DRIVE, Oakville View To The North

R102 - September 17, 2024





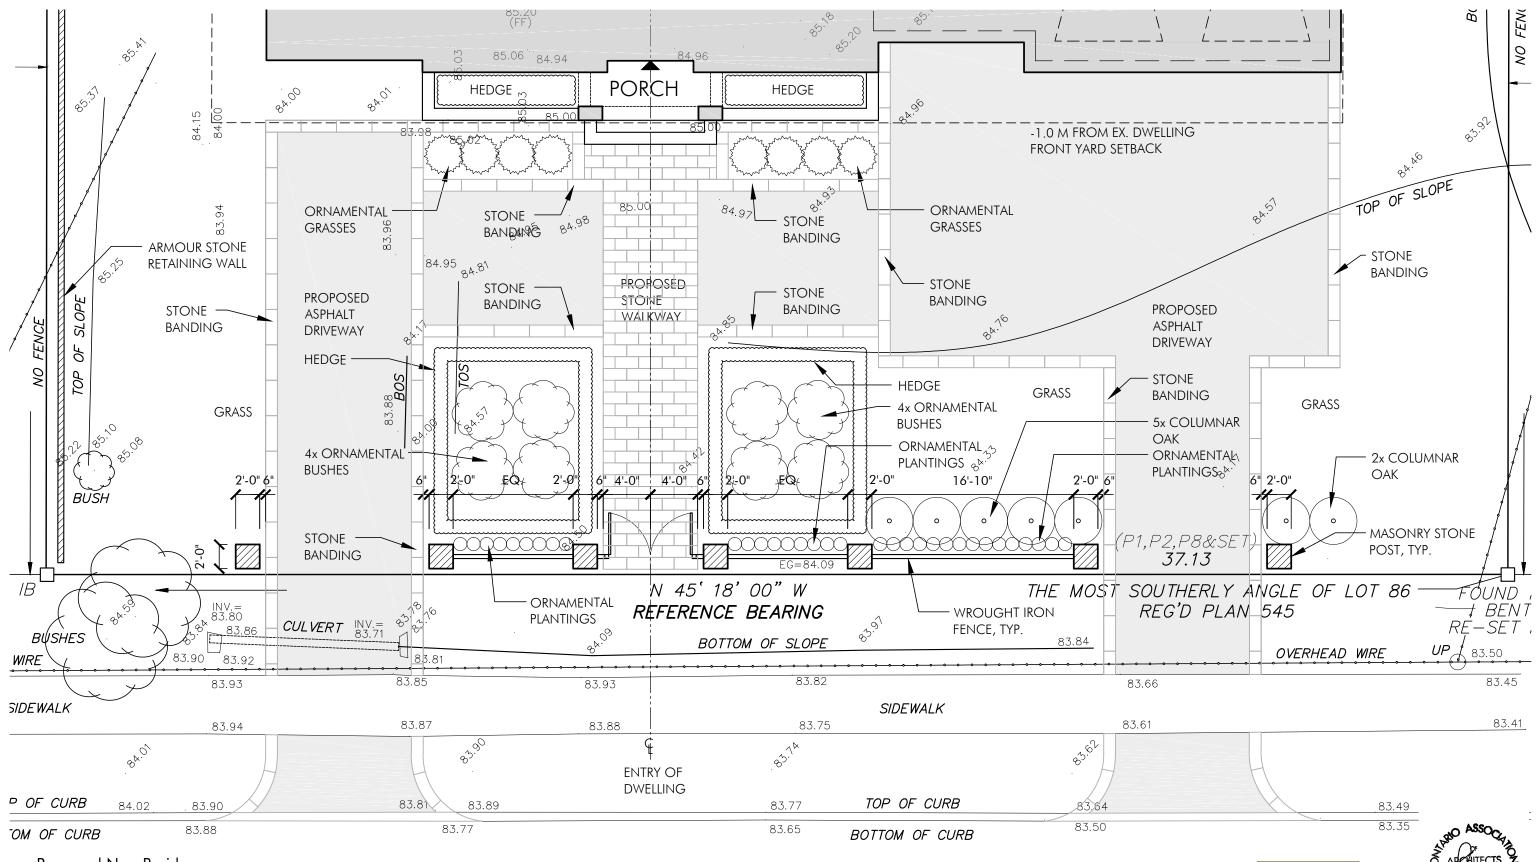

221 WEDGEWOOD DRIVE, Oakville

Conceptual Front Landscape Plan - at 1/8"=1'-0" A101a - September 17, 2024



64 Rebecca Street, Oakville Ontario, Canada L6K 1J2 Tel: (905) 842-9191 www.gusricciarchitect.com

ARBORIST REPORT

TREE REMOVAL AND REPLANTING PLAN

PREPARED FOR:

LAURA BRUTTO 221 WEDGEWOOD DRIVE, OAKVILLE, ON, L6J4R6

PREPARED BY:

JONATHAN CHANDLER
ISA CERTIFIED ARBORIST ON-1305AT
WWW.JCFORESTRY.COM
INFO@JCFORESTRY.COM
(416) 953 9806

JC FORESTRY

TREE CARE AND PRESERVATION









Definitions

- "arborist" means a person who has graduated from an accredited college or university with a diploma or degree in Urban Forestry, Arboriculture or equivalent
- "diameter or DBH" means the diameter at breast height, measured outside the bark, of the stem or trunk of a tree, and shall be measured at a point 1.4 meters above the existing grade of the ground adjoining its base or, where there are multiple stems to a tree, means the total of diameter of all stems at a point 1.4 meters above the existing grade, or alternate methods approved by the Designated Official
- "Removal" means remove specific tree outlined in chart, followed by images and location of tree
- "Action" refers to method to be carried out, either remove, preserve, tpz,
- "injure/injury" means damaging or destroying a tree by: removing, cutting, girdling, or smothering of the tree or roots; cutting more than 25% of tree canopy; interfering with the water supply; setting fire to a tree; applying chemicals on, around, or near the tree; compaction or re-grading within the drip line of a tree; damage caused by new development or construction related activities that are not evaluated as part of an approval under the Planning Act
- "**lot**" means a parcel of land having specific boundaries which is capable of legal transfer;
- "ownership" means the registered owner of a lot, either private or municipal
- "location" means location of tree on subject property, either front yard, side, or backyard, location to be specified in
- "permit" means a tree removal permit issued under this By-law to remove a tree on private property within the city
- "pruning" means the appropriate removal of not more than 25% of the live branches or limbs of a tree as part of a consistent annual pruning program
- "Replacement tree" means a tree that is required under this By-law to replace an existing tree that is approved for removal;
- "Assessment Agreement" agreement set out by arborist includes disclosure of report and conditions

Segment 1 - Overview

Jonathan Chandler was retained to complete an Arborist Report at the property located at 221 wedgewood drive, Town of Oakville for the submission of a tree removal permit application.

This report has been prepared to address the tree removal planning of species greater than 15 cm (or 6") for the subject property. This report will document the trees to be removed as well as trees to be replanted.

An inventory and assessment was conducted on September 24th 2024 to assess the trees to be removed under Town of Oakville guidelines as well as ISA standards. The purpose of this report is to:

- Provide an inventory and assessment of existing bylaw-protected trees as required by the Town of Oakville
- Location of trees
- Tree to be removed
- Tree to be replanted as per replanting plan

The proposed Trees were examined to determine species and were identified based on bud and bark patterns, shape and color as well as tree structure. Due to the time of year, live foliage was favorable for viewing. Trees were measured at DBH (diameter at breast height, or 1.4 m above ground surface) and condition was assessed based on presence of flaws, damage, and evidence of structural damage.

Indicated in this report will be trees that vary in condition based on visual observation, assessments made at the time of viewing are documented and prepared as accurately as possible.

Segment 2 - Inventory of trees

The Town of Oakville private Tree Bylaw regulates the removal of trees on private property, the Bylaw states for the removal of trees that measure 15 cm (6") diameter at breast height (DBH) or greater, will require a permit.

Table 1 - Tree inventory table description (See tree inventory on next chart)

Tree ID #	This ID number is assigned to the tree on the plan/survey/overhead view					
Common Name	Common name given to the species of tree					
Botanical Name	Botanical name/Latin name given to species of tree					
DBH	Diameter at breast height measured 1.4m from ground					
Health	Visual assessment on health of tree ranging					
Structure	re Visible amount of structure remaining					
Crown	Visual measurement of crown					
Ownership	ip Tree will be privately owned or owned by city					
Location	Location of tree on subject property					
Action	Determination of tree, to either protect, injure or destroy (remove)					

TABLE 2 - Existing tree inventory

Tree #	Common Name	Botanical Name	DBH (cm)	Health/ condition	Structure %	Crown (m)	Ownership	location	Action	Comments
T1	Norway Maple	Acer platanoides	37	fair	90	5	Private	frontyard	Removal	Tree is growing into service lines, located within proposed pedestrian walkway
T2	Norway Maple	Acer platanoides	20	Fair/poor	85	2	Private	Front yard (left side)	Removal	Limited canopy, leaning towards neighboring property
Т3	White Cedar	Thuja occidentalis	18/32	good	95	3	Private	Backyard	Removal	Located within proposed dwelling
T4	Black Walnut	Juglans nigra`	69	fair	85	9	Private	Backyard	Removal	Leaning towards neighboring house, on slope, needs to be removed

Segment 3 - Pictures of trees listed in report


Pictures outlined in this report are taken on the day of the assessment, to provide a clear and detailed image of trees outlined in this arborist report, no alterations, changes, or enhancements will be made to photographs.










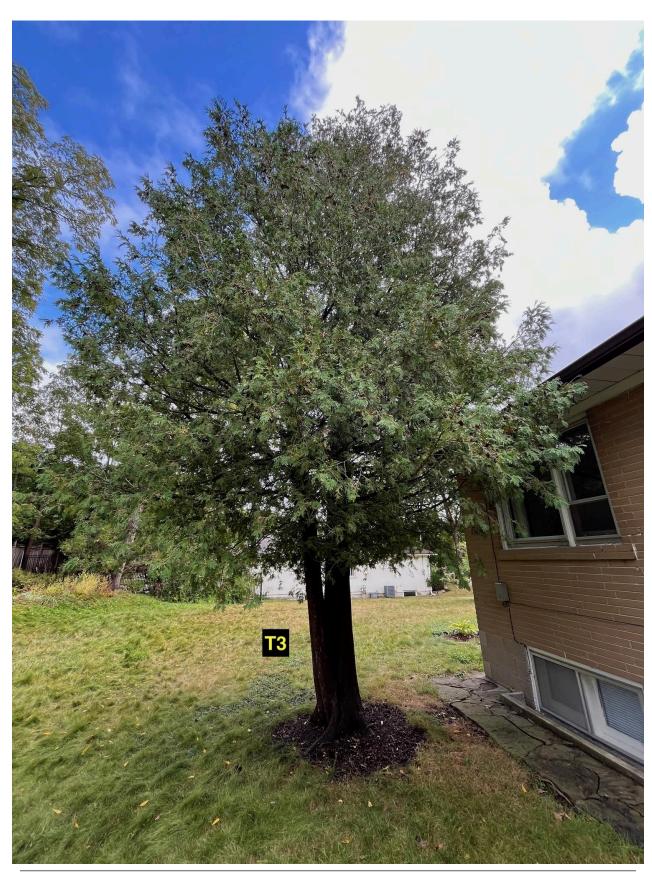

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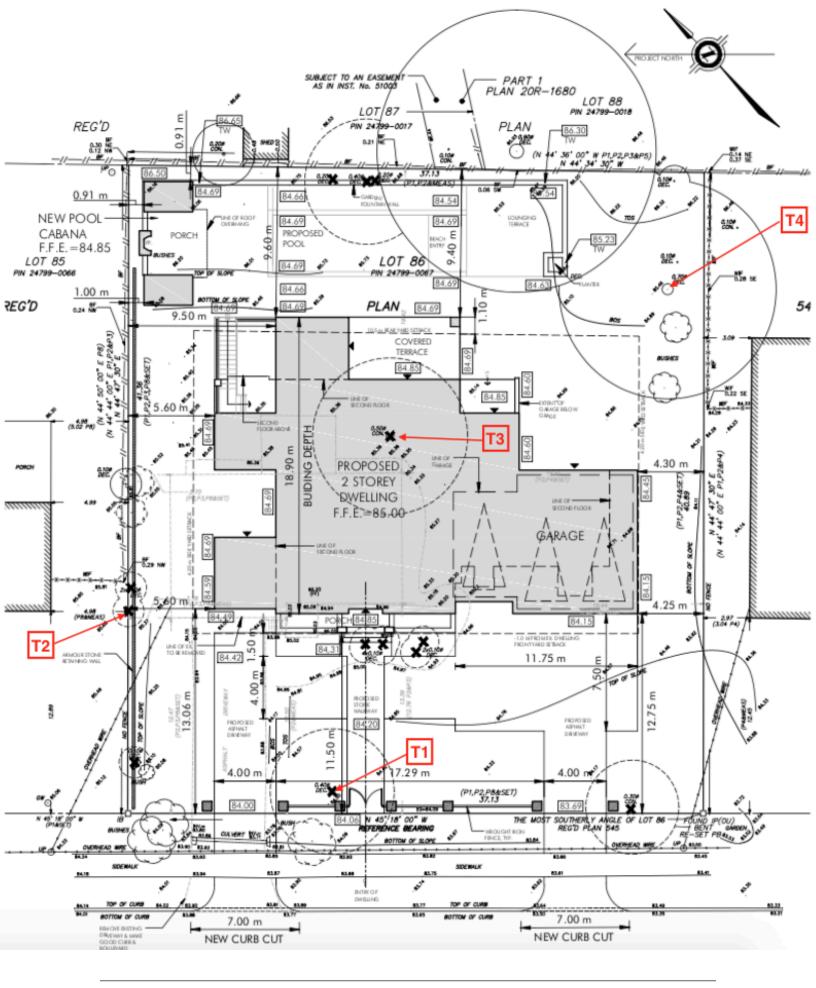
info@jcforestry.com Page 133 of 191





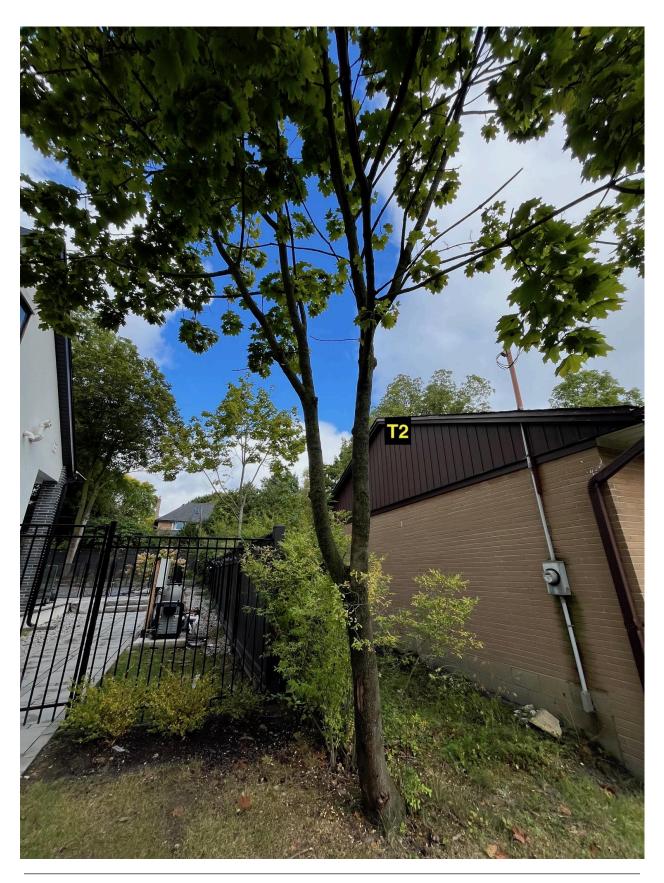





Segment 4 - Replanting

- The requirements for replacement tree planting are: At least 1.8 m tall if it's a coniferous (evergreen) tree or at least 6 cm in diameter if it's a deciduous (leaves) tree. One replacement tree is required for 10 cm of the removed tree's DBH
- Selection of trees to be replanted will be post tree removal to ensure optimal growing conditions without any concern of damage. Third party contractors or the homeowner, will select the variety of species to be replanted, with the exception of any invasive or restricted tree species. If the homeowner decides to pay cash in lieu this will be described in the tree compensation chart.
- Requirements will be respected and met as per Town of Oakville guidelines. A follow up with city staff members for inspection will be required by the landowner once the trees have been successfully planted, or cash be paid in lieu of private tree removal

Trees being removed								
Tree #	Common Name	Botanical Name	DBH	Compensation Ratio Category	# of trees required to replant			
T1	Norway Maple	Acer platanoides	37	1:10	Subject to town of oakville requirements			
T2	Norway Maple	Acer platanoides	20	1:10	Subject to town of oakville requirements			
Т3	White Cedar	Thuja occidentalis	18/32	1:10	Subject to town of oakville requirements			
T4	Black Walnut	Juglans nigra`	69	1:10	Subject to town of oakville requirements			

- Homeowner will replant the required amount of trees based on the town of Oakville's requirements, in lieu of removal of current and existing trees located on property for compensation as per Town of Oakville guidelines
- Selection of trees will be to the specified to the chart provided by the Town of Oakville, this will not include invasive tree species, toxic or dangerous plants, fruit trees, or other trees not listed in the guide
- Placement/planting of trees will be to the sole discretion of the homeowner on where they want to plant, once planted the homeowner will advise the city inspector for further inspection

Assessment agreement and acknowledgement

It is the policy of Jonathan Chandler, consulting arborist, to attach the following clause in regards to limitations based on the assessment written in this report. This is to ensure that the client is fully aware of what is technically and professionally realistic in the preservation and evaluation of trees in the urban environment and their current setting.

The assessment of the trees in this report has been done in conjunction with and according to accepted arboriculture methods and techniques. These include an examination of the above ground parts of the tree for structural defects, scars, cracks, the overall condition of the root structures, the severity and direction of lean (if any), the general condition of the trees and the surrounding environment, external indications of decay such as fungal fruiting bodies, evidence of attack by insects, symptoms of infestation and pathogens, discolored foliage, and the proximity of potential targets should a tree fail.

The trees were not cored, probed or climbed and there was no detailed inspection of the root crowns involving excavations, or samples taken to be scientifically tested. Notwithstanding the recommendations and conclusions presented in this report, it must be acknowledged that trees are living organisms. They are not immune to changes in site conditions, dramatic weather events or seasonal variations in climate. Therefore it should always be recognized that trees are ever evolving and their health and vigor constantly vary over time.

While all reasonable efforts have been made to ensure that the subject trees are healthy, no guarantees are offered or implied that these trees or part(s) of any trees will remain intact. It is professionally and practically impossible to predict with absolute certainty the behavior of any tree. Most trees have the potential for failure under adverse weather conditions and the risk can only be completely eliminated if the tree is removed. Inherently, a standing tree will always pose some level of risk. Although every effort has been made to ensure that this assessment is reasonably accurate, trees should be reassessed periodically.

Jonathan Chandler reserves the right to withdraw this report and its recommendations, if any requirements are not met. If alterations/revisions are required it will solely be at the discretion of the consulting arborist who prepared this report based on the information requested.

Arborist Report Prepared By

Jonathan Chandler

Certified Arborist ON-1305AT





The International Society of Arboriculture

Hereby Announces That

Tonathan Mark Chandler,

Has Earned the Credential

ISA Certified Arborist ®

By successfully meeting ISA Certified Arborist certification requirements through demonstrated attainment of relevant competencies as supported by the ISA Credentialing Council



4 April 2023

30 June 2026





The International Society of Arboriculture

Hereby Announces That

Jonathan Mark Chandler

Has Earned the Credential



ISA Tree Risk Assessment Qualification®

By successfully meeting ISA Tree Risk Assessment Qualification requirements through demonstrated attainment of relevant competencies as supported by the ISA Credentialing Council



19 April 2024 Issue Date

19 April 2029 Expiration Date





ON-1305A

The International Society of Arboriculture

Hereby Announces That

Jonathan Mark Chandler

Has Earned the Credential

ISA Certified Tree Climber

By successfully meeting ISA Certified Tree Climber certification requirements through demonstrated attainment of relevant competencies as supported by the ISA

Certification Number

Credentialing Council



Colyn Bellihau Caitlyn Pollihan CEO & Executive Director

Expiration Date Issue Date





64 Rebecca Street, Oakville Ontario, Canada L6K 1J2 Tel (9 0 5) 8 4 2- 9 1 9 1 Fax (9 0 5) 8 4 2- 3 3 8 2

September 26, 2024

Ms. Jasmina Radomirovic Assistant Secretary - Treasurer Committee of Adjustment **Town of Oakville** 1225 Trafalgar Road Oakville, Ontario L6J 5A6

RE: Committee of Adjustments application #A /071/2024 : 221 Wedgewood Drive, Oakville

Dear Ms, Radomirovic, Chairperson and Committee Members,

The variance application for 221 Wedgewood Drive, Oakville was previously scheduled to be heard at a meeting on May 1, 2024. However, based on Planning comments we requested a deferral which was granted. We have been developing revised designs, discussing these with Planning staff and we are in a position to re-submit for a new meeting.

Please accept the attached revised application, drawings and planning justification report all in support of our variance application. We respectfully request to be heard at the next available date with the Committee of Adjustment and look forward to providing additional information if required when the application is heard.

Respectfully submitted,

Gus Ricci Architect

Gus Ricci, B. Arch, OAA, MRAIC



221 WEDGEWOOD DRIVE

OAKVILLE, ONTARIO

PLANNING RATIONALE
MINOR VARIANCE APPLICATION

SEPTEMBER 2024 // PREPARED BY BATORY PLANNING + MANAGEMENT



1.0 Introduction

Batory Management has been retained as the planning consultant for the development at 221 Wedgewood Drive in Oakville Ontario.

This Planning Justification Report provides a summary of the proposed development and justification of the required minor variances to support a proposed single-detached dwelling at 221 Wedgewood Drive, Oakville Ontario (the "subject site").

1.1 Proposed Development

The proposed development, illustrated in figures 1 through 7 below, comprises a two-storey, single-detached dwelling with an overall floor area of 491.6 square metres on a large rectangular shaped lot with an overall area of 1,526.88 square metres. The proposed detached dwelling covers 27.8% of the property totalling 424 square metres. The proposed height of the dwelling is 9.15 metres. A new circular driveway is proposed and is designed to mitigate impacts on the existing tree canopy within the public right-of-way, while significant tree planting is proposed on the subject site within the front yard. The proposed building has been located to fit appropriately onto the subject site, falling within the setback requirements of the Zoning By-law.

The proposed architecture of the home has been carefully considered in terms of materials, roofline, and proportions that ensure compatibility with the site on which the building is located, adjacent properties, and the local context while contributing to the varied character of buildings in the immediate neighbourhood, effectively utilizing the dimensions of this large, rectangular shaped lot.

The front façade of the proposed building is characterized by a series of large rectangular windows situated across the 1st and 2nd floors. A prominent front entry is located toward the center of the front façade. The building features a shingled, sloped roof with various indentations and portions of the second floor and dormers designed within this roofline. A three-car attached garage is located on the south side of the dwelling, which includes an architectural treatment of the northern garage door which is designed to appear as a window, similar to the windows on the main dwelling. The rear elevation features a series of large rectangular windows overlooking the rear yard. An in-ground swimming pool and cabana are proposed within the rear yard of the property along with a series of landscaped spaces.



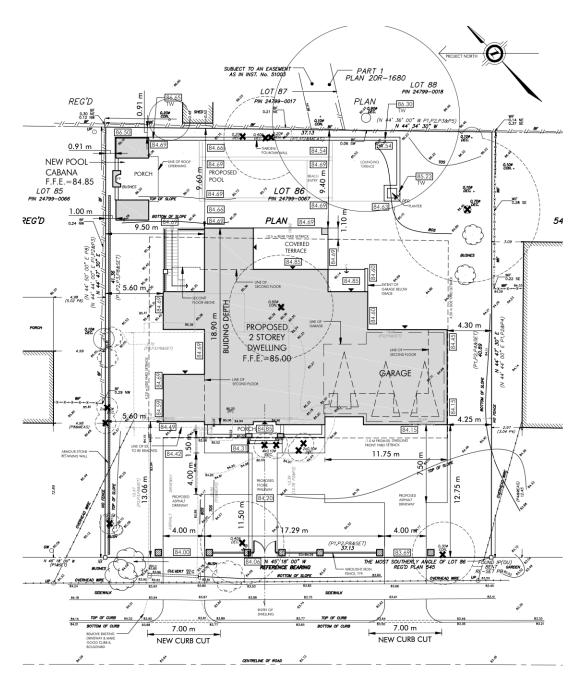


Figure 1 - Site Plan





Figure 2 - Front Elevation



Figure 3 – Rear Elevation

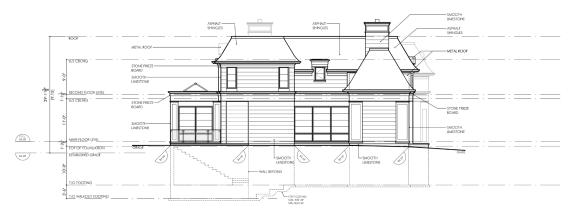


Figure 4 - North Elevation





Figure 5 –South Elevation



Figure 6 - Rendering: Front Elevation A



Figure 7 – Rendering: Front Elevation B



1.2 Subject Site & Application History

The subject site, measuring 1,526.884 square metres, is a rectangular-shaped lot with 37.13 metres of frontage on Wedgewood Drive. The subject site is currently occupied by an existing single detached dwelling with a reverse grade driveway on the north side of the site which leads to an attached below-grade garage.

An active Minor Variance Application (File Number A/071/2024) was deferred by the Town of Oakville Committee of Adjustment on May 1, 2024. The requested variances included an increase to the maximum permitted driveway entrance width, an increase to the maximum permitted floor area for a private garage, an increase in the maximum residential floor area, an increase in the permitted lot coverage, and an increase to the maximum permitted height. A detailed summary of these requested variances compared to the revised application are found later in this report.

The site is designated as "Urban Area" by the Region of Halton Official Plan and is within the "Residential Areas" and "Low Density Residential" land use designation as shown on Schedule G – South East Land Use in the Oakville Official Plan. It is also subject to the Residential Low Density Lands (RL1 / RL1-0 Zones) policy overlay. The site is zoned RL1-0 Residential Low Zone by the Town of Oakville Zoning By-Law 2014-014.



Figure 8 - Immediate Context



1.3 Area Context

The subject site is located within an established neighbourhood in southeast Oakville comprising primarily one and two-storey detached residential buildings on a variety of lot sizes and shapes and in a wide variety of architectural styles. The local area is characterized by significant tree canopy, as well as numerous re-constructed dwellings in recent years. Parking for area residences is provided in driveways in attached garages. A number of properties have rear yard pools.

The Oakville Go station is located a 10 minute drive from the subject site. Warren Drive Park and Albion Park are located in close proximity to the site. The subject site is within walking distance of Oakville Trafalgar High School, Maple Grove Public School, and St. Vincent Catholic Elementary School.

1.4 Zoning By-law and Proposed Variances

The Town of Oakville Zoning By-law 2014-014 establishes standards for how land is to be used and developed. It includes regulations regarding permitted uses, siting, massing, and scales of buildings, minimum and maximum lot sizes, and parking requirements, among others. The Zoning By-law helps implement the policies of the Town's Official Plan. The current iteration of Oakville's Zoning By-Law is consolidated to December 12, 2023.



Figure 9 – Zoning By-law 2014-014 map excerpt



The subject site is zoned RL1-0 Residential Low Zone by the Town of Oakville Zoning By-Law 2014-014 (see Figure 9). The RL1-0 zoning permits the use of a detached dwelling, as well as several other conditional uses, such as a daycare and a private home day care. The "-0" suffix to the zone adds a series of requirements to the base RL1 zone, including those regarding lot coverage, front yard setbacks, main wall proportionality, height, and others.

The following chart provides the previous and current variances being requested to facilitate the proposed development.

By-law Provision	Requirement	May 1, 2024 Variances	Current Variance Requested
Maximum cumulative width of driveway entrances at the point of crossing the front lot line	9.0 metres	12.0 metres	N/A
Maximum Garage	56.0 square	94.80 square	91.5 square metres
Area	metres	metres	
Maximum Floor Area	29.0% (404.1 sq.	36.30%	32.2% (491.6
Ratio	m.)		square metres)
Maximum Lot	25%	29.90%	27.8%
Coverage			
Maximum Building	9.0 metres	9.75 metres	9.15 metres
Height			
Maximum Driveway Width	9.0 metres	N/A	11.75 metres

1.5 Evaluation of the Proposed Minor Variances

In support of the proposed development, an application has been submitted to the Town of Oakville Committee of Adjustment seeking approval of a number of minor variances to permit the construction a new detached dwelling. This Planning Justification Report evaluates the requested revised variances based on the following four tests established in the Section 45(1) of the Planning Act:

- 1) Are the proposed variances consistent with the general intent and purpose of the Official Plan?
- 2) Are the proposed variances consistent with the general intent and purpose of the Zoning By-law?
- 3) Are the proposed variances appropriate and desirable development for the area?
- 4) Are the proposed variances minor in nature?



2.0 Consistency with the General Intent of the Official Plan

The subject site is located within a two-tier municipality and is subject to the Halton Region Official Plan and the Town of Oakville Official Plan, titled the Livable Oakville Plan.

2.1 Halton Region Official Plan

The Halton Region Official Plan (ROP), formally known as Sustainable Halton, is intended to provide clear direction for how physical development should take place in Halton to meet the Region's current and future needs. The ROP provides land-use guidance in developing a consistent vision for Burlington, Halton Hills, Milton, and Oakville.

The subject site is designated as "Urban Area" as shown on Map 1h – Regional Urban Structure of the ROP.

The objectives of the Urban Area, as established in Policy 72 of the ROP, include:

72 (1) To accommodate growth in accordance with the Region's desire to improve and maintain regional unity, retain local community identity, create healthy communities, promote economic prosperity, maintain a high quality, sustainable natural environment, and preserve certain landscapes permanently.

72 (3) To provide a range of identifiable, inter-connected and complete communities of various sizes, types and characters, which afford maximum choices for residence, work and leisure.

2.1.1 Halton ROP Analysis and Opinion

The proposed development provides for a detached dwelling within the urban area, consistent with the objectives of the ROP to accommodate growth in accordance with the Region's desire to create healthy communities and provide a range of identifiable, interconnected and complete communities of various sizes, types, and characters, affording maximum choices for residence, work, and leisure. In my opinion, the proposed development is consistent with the general intent and purpose of the Regional of Halton Official Plan.

2.2 The Livable Oakville Plan

The Livable Oakville Plan (2009) (the "Plan") was adopted by the Town of Oakville on June 22, 2009 and approved by the Region of Halton on November 30, 2009. Its current iteration incorporates amendments up to August 31, 2021. Livable Oakville establishes the desired land use patterns for lands within the Town of Oakville. The Plan coordinates land use and infrastructure requirements to ensure that the anticipated growth can be accommodated throughout the municipality, and establishes the policy framework for decision-making to provide certainty in the planning process.



2.2.1 Guiding Principles

Part B of the Plan provides Guiding Principles to create a livable community. Section 2.2.1 speaks to preserving and creating a livable community in order to:

a) preserve, enhance, and protect the distinct character, cultural heritage, living environment and sense of community of neighbourhoods,

Section 2.2.2 details the objective of providing choice throughout the Town to:

- enable the availability and accessibility of a wide range of housing, jobs and community resources to meet the diverse needs to the community throughout all stages in life; and
- c) foster the Town's sense of place through excellence in building and community design.

2.2.2 Urban Structure and Land Use

Part C of the Plan contains the general policies for the urban structure within the Town. According to Schedule A1 Urban Structure, the subject lands are located within "Residential Areas."

The Plan intends that the character of Residential Areas be maintained. Policy 3.9 of the Plan notes that Residential Areas include low, medium, and high density residential uses as well as a range of compatible facilities. The Plan further states that some growth and change may occur in the Residential Areas, provided the character of the area is preserved and the overall urban structure of the Town is upheld.

The subject site is within the 'Low Density Residential' land use designation as shown on Schedule G – South East Land Use, and is subject to the Residential Low Density Lands (RL1 / RL1-0 Zones) policy overlay.



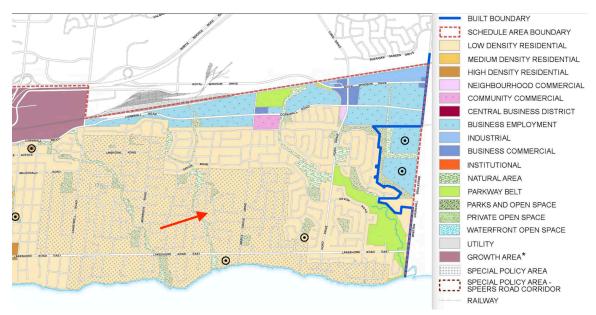


Figure 10 - Livable Oakville Plan Schedule G - South East Land Use Excerpt

Section 11 of the Livable Oakville Plan contains policies to guide the development of properties within the Residential Areas land use designation. The Plan states the following objectives, which apply to all Residential Areas:

- a) maintain, protect and enhance the character of existing residential areas;
- b) encourage an appropriate mix of housing types, densities, design and tenure throughout the Town;
- c) promote housing initiatives to facilitate revitalization, compact urban form and an increased variety of housing for all socio-economic groups
- d) encourage the conservation and rehabilitation of older housing in order to maintain the stability and character of the existing stable residential communities

Section 11.1.4 of the Plan states that development in Residential Areas shall conform with the policies relating to urban design and sustainability set out in Part C of the Plan.

The Plan generally considers Residential Areas as being stable, with Sections 11.1.8 and Section 11.1.9 establishing the criteria against which development in stable Neighbourhoods is evaluated, in order to maintain and protect the existing neighbourhood character. Character is defined by the Plan as the collective qualities and characteristics that distinguish a particular area or neighbourhood.

The criteria for development within all stable residential communities, established in Section 11.1.9, includes the following:



- a) The built form of development, including scale, height, massing, architectural character and materials, is to be compatible with the surrounding neighbourhood.
- b) Development should be compatible with the setbacks, orientation and separation distances within the surrounding neighbourhood.
- h) Impacts on the adjacent properties shall be minimized in relation to grading, drainage, location of service areas, access and circulation, privacy, and microclimatic conditions such as shadowing.

2.2.3 Special Policy Area—Residential Low Density Lands (RL1 / RL1-0 Zones) Section 26.2 of the Plan establishes special policy provisions for Residential Low Density Lands which are also subject to RL1 / RL1-0 zoning. The Special Policy Area is intended to protect the unique character of this area within the Town and limits intensification to development which maintains the integrity of the large lots characteristic of this area. The policy further directs that densities shall not exceed 10

units per site hectare, notwithstanding the Low Density Residential designation.

2.2.4 Design Guidelines for Stable Residential Communities

Section 11.1.9 of the Plan notes the Design Guidelines for Stable Residential Communities (the "Guidelines") that are intended to implement the urban design and residential policies of the Official Plan. Endorsed by Planning and Development Council on April 29, 2013, the Guidelines apply to the development on the subject site and are an important tool in assessing the intent of the Official Plan.

Aligning with the policy text of the Plan, Section 3 of the Guidelines establishes that new development should be compatible with the dwellings in the surrounding neighbourhood; that is, designed to respond to the basic neighbourhood patterns and reoccurring characteristics, such as lot patterns, street edges, placement and orientation of dwellings, existing vegetation, topography, and other common or distinctive elements.

Section 3.1.1 of the Guidelines recommends that new development be designed to maintain and preserve the scale and character of the site, provide a visual reference to existing neighbourhood features and its immediate context, and to create compatible transitions between the new dwelling and existing dwellings in the surrounding neighbourhood.

Section 3.1.3 of the Guidelines states that new development should not have the appearance of being substantially larger than the existing dwellings in the immediate vicinity.

Section 3.1.5 of the Guidelines directs that the design and placement of new development should make every effort to minimize the potential impacts on the privacy



of rear yard amenity spaces of adjacent properties by carefully considering building massing and the placement of building projections, decks and balconies, and screening vegetation.

With regard to building design, Section 3.2 states that new development, when contextually designed, may reflect any architectural style and still maintain compatibility with the character of the surrounding neighbourhood.

Where new development is larger in overall massing than adjacent dwellings, Section 3.2.1 recommends that a thoughtful composition of smaller elements and forms that visually reflect the scale and character of the dwellings in the surrounding area be incorporated into the design.

Section 3.2.2 states that new development is encouraged to incorporate upper storey living spaces wholly or partially within the roof structure to de-emphasize the height and overall building scale, and to divide the massing of the roof. Dormer and end gable windows can provide adequate light into these spaces.

Section 3.2.3 intends that new development should be oriented and positioned on the lot to be compatible with the existing pattern of dwelling placement, in terms of front, side, flankage and rear yard setbacks and should maintain the setback or average of setbacks from the street frontage as the existing dwellings in the immediate area.

With regard to the design of the primary building façade, Section 3.2.4 of the Guidelines recommends that new development incorporate a prominent primary entrance on the front façade to provide a clear sense of arrival, as well as a connection to the municipal sidewalk. Section 3.2.5 suggests that new development incorporate adequate window openings, designed in appropriate proportion, on the primary façade to add visual interest and to maximize light penetration and views, while minimizing overlook conditions onto neighbouring properties.

Section 3.2.6 of the Design Guidelines recommends that new development should make every effort to minimize the visual prominence of the garage and the surface parking area on the property frontage in order to maintain a positive pedestrian experience along the streetscape.

Section 3.3.1 of the Guidelines suggests that new development be designed and sited to retain established landscaping, such as healthy mature trees and existing topography, and incorporate landscaping and proposed trees into the design and development of the site for compatibility with the surrounding landscape patterns.



Section 3.3.2.1 of the Design Guidelines recommends that new development should be designed with minimal paved areas in the front yard. These paved areas should be limited in width to accommodate a driveway plus a pedestrian walkway.

Section 3.3.2.2 of the Design Guidelines recommends that new development should be designed with widest part of the driveway positioned directly in front of the garage door(s). The driveway width should be minimal at the property line to reduce the impact on the pedestrian environment and on street trees in the boulevard.

2.2.5 Livable Oakville Plan and Design Guidelines Analysis and Opinion

The proposed development provides for a new detached dwelling within the urban area, in a form compatible with the character and scale of dwellings in the area and the prevailing low rise residential context. The proposal represents gradual growth and change within the Residential Area. The proposed dwelling type is consistent with the surrounding context.

Relative to the overall size of the subject site, the scale, massing, height, and siting of the proposed development reflects the prevailing form of houses in the local context. The site itself is a rectangular-shaped lot, similar to many of the lots in the immediate area. The frontage of the property is comparable to the frontages of many lots within the immediate neighbourhood. The dwelling is suitable in size for the lot and has been sited with regard for adjacent properties and the respective dwellings on these lots. The proposed coverage for the main dwelling, excluding unenclosed portions of the building, is within the required maximum for this site, and further, the proposed setbacks result in a building that is situated appropriately on the lot to maintain compatibility with adjacent residences and limit any potential for overlook and privacy issues. All setback provisions of the Zoning By-law are being met or exceeded.

The proposed development is consistent with the Residential Low Density Special Policy area requirement to maintain the integrity of the large-lot characteristic of this area. As a single-detached dwelling is proposed on the lot, the area density does not exceed 10 units per hectare as required by the Plan.

The Design Guidelines for Stable Residential Communities are an important tool for assessing a proposal's consistency with the intent of the Official Plan. To the greatest degree possible, the proposal has been designed to respond to the neighbourhood patterns and reoccurring characteristics and is consistent with the applicable guidelines contained within the Guidelines.

The proposed development has been designed to maintain and preserve the scale and character of the site as well as the immediate context. The dwelling is situated within an neighbourhood that is characterized by large, single-detached dwellings with heights, floor area, dwelling depths, and setbacks that in many instances are greater than the



typical provisions of the Zoning By-law. The dwelling has been further sited on the lot to create compatible transitions between the new dwelling and existing dwellings in the surrounding neighborhood, consistent with Section 3.1.1 of the Guidelines. Further, the proposed dwelling does not have the appearance of being substantially larger than the existing dwellings in the immediate vicinity, consistent with Section 3.1.3 of the Guidelines.

The proposed massing of the dwelling and building projections, has been designed to mitigate potential impacts on the privacy of rear yard amenity spaces of adjacent properties, consistent with Section 3.1.5 of the Guidelines. The dwelling siting includes a front yard setback that is compliant with the provisions of the Zoning By-law and assists in mitigating any potential rear yard amenity impacts on the adjacent rear yards.

Consistent with the objective of Section 3.2 in the Guidelines, the proposed dwelling does not necessarily replicate or reflect any particular architectural style common to the immediate neighbourhood context, but still maintains compatibility with the character of the surrounding neighbourhood. The window treatment of the proposed dwelling has been designed in appropriate proportion on the primary façade to add visual interest and to maximize light penetration and views. The development incorporates a prominent primary entrance adjacent to Wedgewood Drive, which provides a clear sense of arrival. The proposed building design is compatible with the immediate neighbourhood, which includes a significant variety of architectural styles, materials, and built form features. The proposed dwelling does not appear to be larger in overall massing in comparison to adjacent properties, and provides for a thoughtful composition of building elements and forms that reflect the scale and character of dwellings in the surrounding neighbourhood. These built form features include portions of the second storey and roof structure that have been designed to de-emphasize the height and overall building scale, consistent with Section 3.2.2 of the Guidelines. These elements also include the roof design above the garage on the north elevation, as well as the roof design on the front elevation that breaks up the overall massing of the dwelling.

As noted, the proposed building has been appropriately sited on the lot to maintain compatibility with adjacent residences both in terms of setbacks and dwelling placement, with the intent of responding to the area character as well as limiting any overlook and privacy issues, consistent with Guideline Section 3.2.3.

The driveway design of the development features a circular driveway and a widened portion of the driveway located in front of the garage doors with significant landscaping proposed to mitigate potential impacts. The paved area in the front yard is compliant with the Zoning By-law requirements and features a pedestrian walkway to the front entrance of the dwelling, and the widest part of the driveway is positioned in front of the garage door, consistent with Section 3.3.2 of the Guidelines.



In my opinion, the proposed development is consistent with the general intent and purpose of the Livable Oakville Plan and the Design Guidelines for Stable Residential Communities.

3.0 Consistency with the General Intent of the Zoning By-law

The subject site is zoned RL1-0 Residential Low Zone by the Town of Oakville Zoning By-Law 2014-014. The RL1-0 zoning permits the use of a detached dwelling, as well as several other conditional uses, such as a day care and a private home day care. The "-0" suffix to the zone adds a series of requirements to the base RL1 zone, including those regarding lot coverage, front yard setbacks, main wall proportionality, height, and others.

Variances to the prescribed maximum building height, maximum lot coverage, maximum floor area ratio, maximum driveway width, and maximum garage area are being sought to permit the proposed development.

3.1 Maximum Building Height

The intent of the maximum building height is to limit potential for impacts related to overlook, shadow, and loss of sky view on adjacent properties, as well as maintain consistency in the area's physical character.

The maximum permitted building height is 9.0 metres. The proposed building height is 9.15 metres. Based on the design, siting, and size of the proposed dwelling relative to the lot size, and the characteristics of other houses in the immediate area, the proposed increase in height is not anticipated to result in any appreciable impact on adjacent properties or the character of the area. The proposed increase in dwelling height also is only applicable to the centre portion of the roofline, which is setback in excess from the side lot lines well in excess of the Zoning By-law requirements. Further, there is approximately a 1 metre difference in grade from the north property line to the south property line, which slightly impacts the established grade and design of the dwelling on the lot.

The character of dwellings in the surrounding neighbourhood comprises primarily one and two-storey designs both in the style of the original building stock of the neighbourhood and newer, more contemporary two-storey houses. In cases where a building is disproportionate in size relative to the lot on which it is proposed, additional height can be impactful on both adjacent properties and area character. However, these impacts are not present in this case. The proposed height is not disproportionate to the lot on which it is situated and, importantly, the building's setbacks, varying roofline design, and landscape features serve to satisfactorily limit any impact on adjacent properties associated with the proposed height.



It is my opinion that the requested variance to building height is consistent with the intent of the Zoning By-Law.

3.2 Maximum Driveway Width

The intent of regulating the maximum driveway width is to ensure that reasonable vehicular access can be provided without the hard surface treatment of the driveway dominating the front yard area.

The driveway width has been measured at the widest part of the driveway, which is located at the southern side of the front of the dwelling, in front of the proposed garage doors.. The driveway features a circular design which is permitted as-of-right, and is further mitigated with significant planting in the front yard.

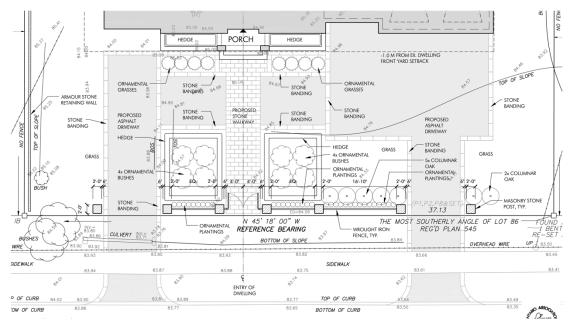


Figure 11 - Concept Landscape Plan

Further, the circular driveway design has been limited to 4.0 metres in width for significant portions of the driveway design to limit impacts on the streetscape, and the proposed paved surface of the driveway for the majority of the driveway has been significantly reduced from the original application submission.

It is my opinion that the requested variance to the maximum driveway width is consistent with the intent of the Zoning By-Law.



3.3 Maximum Residential Floor Area Ratio and Lot Coverage

The intent of the maximum residential floor area ratio and maximum lot coverage provision to ensure a dwelling does not have a mass and scale that appears larger than the dwellings in the surrounding neighbourhood.

Consistent with the intent of the By-law, the proposed design features an entry portico, and a roofline and built form features that provide for a variety of building proportions in the architecture of the home. These massing approaches contribute to breaking up the building mass, diminishing the perception of building scale from the street. The building also locates some of the 2nd floor area within its roofline, further diminishing the perception of building mass from the street.

The proposed dwelling features un-enclosed building components including a rear single storey covered terrace and a front porch which assists in breaking up the massing of the dwelling. The footprint of the main portions of the dwelling are within the permitted lot coverage provisions, albeit these features are counted towards the lot coverage of the proposed dwelling.

Of note, a number of dwellings in the immediate vicinity of the subject property feature floor area ratios and lot coverages in excess of the Zoning By-law. The proposed variances will not have a negative impact on adjacent properties or the surrounding area since the overall massing and scale of the proposed dwelling is similar to existing dwellings in the surrounding neighbourhood. The request for the additional floor area ratio and lot coverage is compatible and in keeping with the pattern of new development in the area.

It is my opinion that the requested variances to residential floor area ratio and lot coverage are consistent with the intent of the Zoning By-Law.

3.4 Maximum Garage Area

The intent of the maximum garage area provision is to ensure that dwellings do not contain uncharacteristically large parking garages within their building footprint and further to mitigate potential streetscape impacts. The maximum permitted parking garage area is 56 meters with an access width of 9.0 metres, whereas the proposed parking garage area is 91.5 square meters.

This provision is somewhat problematic when considered alongside other zoning criteria which regulate the overall size of a dwelling. In other cases, such as with Lot Coverage and Floor Space Index, requirements are expressed relative to the size of the site, not as a hard number. In many cases it is likely that 56 square metres is sufficient for vehicle parking, but in cases where a large dwelling is proposed on a large site, it may be appropriate for the garage area to bear some relationship to the overall size of the dwelling, especially in cases where the additional garage area creates no impact on



adjacent properties. In this instance, the garage area is appropriate relative to the size of the proposed dwelling, which itself is appropriately scaled for the site, as discussed earlier in this report.

The proposed garage, a one-storey structure with three garage doors, is provided with a garage design which includes a third door that appears as a window, similar to the architecture proposed for the windows of the main dwelling. Significant tree and vegetation planting is also proposed to mitigate impacts of the garage on the streetscape.

It is my opinion that the requested variance to parking garage area is consistent with the intent of the Zoning By-Law.

4.0 Minor in Nature

The primary basis for determining whether a requested variance is minor in nature is one of impact. This determination is not strictly a mathematical exercise and, even though a variance may present a considerable numerical change, it may still be properly judged as minor in nature if the actual effects of the variance do not result in significant adverse impacts on the surroundings, which include neighbouring properties as well as the 'streetscape.'

In my opinion, the requested variances are minor in nature.

4.1 Maximum Building Height

The maximum permitted building height is 9.0 metres, while the proposed building height is 9.15 metres. As discussed, the proposed height will not impact the neighbouring properties with regard to overlook, shadow, or loss of sky view. The proposed dwelling's massing is broken up by varied architectural components, provides a significant setback from the north property line, and is scaled appropriately when compared to the dwellings in the immediate context. The proposed roofline further assists in limiting any incremental impacts resulting from the additional requested 0.15 metre building height.

In my opinion, the proposed building height variance is minor in nature.

4.2 Maximum Driveway Width

Disproportionate driveway widths impact the streetscape when the additional width contributes to an excessive proportion of the front yard being paved, particularly when the driveway area is near the street. In the context of the proposed development, the large front yard, driveway design, and proposed planting and landscaping ensures that an extensive front yard remains landscaped, and significant portions of the driveway will be screened from the streetscape. The requested driveway width only pertains to the



southern portion of the site, and hardscape areas have been significantly reduced for the development. for vehicular movements and turnaround area, specifically required for access to the garage that is designed to interface with the northern side yard and mitigates impact to the streetscape.

In my opinion, the proposed maximum driveway width variance is minor in nature.

4.3 Maximum Residential Floor Area Ratio and Lot Coverage

The proposed design of the proposed residence breaks up the building mass through a series of architectural elements, including the entry portico, north façade setback, varying building proportions, and roofline of the dwelling. These design elements and building siting diminish the perception of building scale from the street to ensure that the proposed development is consistent with the massing of other similar two-storey residences in the immediate context.

In my opinion, the proposed variances to the residential floor area ratio and lot coverage are minor in nature.

4.4 Maximum Garage Area

The proposed garage area exceeds the provision outlined in the Oakville By-law. It is noted that the northern garage door entrance is designed to not appear as a typical garage door, and the garage will be significantly screened via trees and vegetation from the streetscape along Wedgewood Drive. The garage is also appropriately setback from the street with and further features architectural treatment to mitigate any potential impacts.

In my opinion, the requested variance for the garage area is minor in nature.

5.0 Appropriate and Desirable Development for the Area

The proposed development is located within an established large lot residential area. The requested variances are necessary to permit the construction of a dwelling that is consistent in all but minor regard from the metrics for a detached dwelling contemplated on the Town of Oakville Zoning By-Law 2014-014, as amended.

The scale, massing, height, and siting of the proposed development reflect an appropriate form and scale of dwelling relative to the size and configuration of the subject site. The dwelling has been sited with regard for the setbacks and yards of adjacent properties. The northern setback is significantly increased from the By-law minimum of 4.2 metres to 5.6 metres to mitigate any potential massing impacts associated with both the requested height and floor area ratio variances.

With consideration of the large size and unique layout of this lot, the proposed height and overall mass of the building fits appropriately in the immediate context, particularly



with the more contemporary residences, and has been designed and sited with regard for the immediately adjacent dwellings. The architecture of the home has been carefully considered, incorporating high quality materials, extensive landscaping, and proportions that ensure compatibility with the adjacent properties and the local context, while contributing positively to the varied nature of designs in the immediate neighbourhood. The proposed development is located within an established neighbourhood in the urban area, and is within walking distance to parks and schools.

In my opinion, the proposed development represents appropriate and desirable development for the area.

6.0 Planning Conclusion

The proposed development is located within an established neighbourhood of single-detached dwellings on large, landscaped lots within the urban area. The requested variances are necessary to permit the proposed detached dwelling with a scale and character that is consistent in all but minor regard from the metrics for a detached dwelling contemplated on this lot by Zoning By-Law 2014-014, as amended. Each of the proposed variances has been reviewed in relation to the current requirements of the Zoning By-law and specifically examined with respect to the adverse impact, if any, that would be experienced on the nearby properties should the variances be granted.

The proposed development provides for a new detached dwelling within the urban area, in a form compatible with the character of the existing low rise residential context, representing appropriately gradual growth and change within the Residential Area. The proposed dwelling is consistent with the surrounding context pursuant to the policies of the Livable Oakville Plan and the Design Guidelines for Stable Residential Communities.

In my opinion, the proposed variances are consistent with the general intent and purpose of the Halton Regional Official Plan, the Livable Oakville Plan, and applicable Zoning By-laws, are minor in nature, reflect appropriate and desirable development for the area, and represent good planning.

Respectfully submitted by,

Paul Demczak, MCIP, RPP

Principal, Batory Planning + Management



Batory Planning & Management is a multidisciplinary urban planning and project management consulting firm with a focus on helping our clients improve the built environment and embrace unique opportunities within the real estate spectrum. The firm integrates urban planning, project management, and real estate consultancy, prioritizing a customer-focused experience for our clients.



Notice of Public Hearing Committee of Adjustment Application



File # CAV A/071/2024 (Deferred from May 1, 2024)

Electronic hearing:

By videoconference and live-streaming video on the Town of Oakville's Live Stream webpage at <u>oakville.ca</u> on November 13, 2024 at 7 p.m.

Why am I receiving this notice?

You are receiving this notice because the applicant noted below has submitted a minor variance application to the Town of Oakville. As stipulated by the *Planning Act*, notice must be provided to property owners within 60 metres (200 ft.) of the area to which the application applies. Further details of this application, including drawings, can be viewed online at Agendas & Meetings (oakville.ca).

Applicant and property information:

Applicant / Owner	Authorized Agent	Subject Property
L. Brutto	Gus Ricci Gus Ricci Architect 64 Rebecca St Oakville ON, CANADA L6K 1J2	221 Wedgewood Dr PLAN 545 LOT 86

Zoning of property: RL1-0, Residential

Variance request:

Under Section 45(1) of the *Planning Act*, the applicant is requesting the Committee of Adjustment to authorize a minor variance to permit a new two storey detached dwelling with an accessory building (pool cabana) on the subject property proposing the following variances to Zoning By-law 2014-014:

No.	Current	Proposed
1	Section 5.8.2 c) iii) The maximum width of a driveway shall be 9.0 metres for a lot having a lot frontage equal to or greater than 18.0 metres.	To increase the maximum width of the driveway to be 11.75 metres for a lot having a lot frontage equal to or greater than 18.0 metres.
2	Section 5.8.6 c) For lots located within the Residential Low (RL1) Zone the maximum total floor area for a private garage shall be 56.0 square metres.	To increase the maximum total floor area for the private garage to 91.50 square metres.
3	Table 6.4.1 The maximum residential floor area ratio for a detached dwelling on a lot with a lot area 1301.00 m ² or greater shall be 29%.	To increase the maximum residential floor area ratio to 32.20%.

4	Table 6.4.2 (Row RL1, Column 3)	To increase the maximum lot coverage to 27.80%.
	The maximum lot coverage shall be 25% where	_
	the detached dwelling is greater than 7.0 metres	
	in height.	
5	Section 6.4.6 c)	To increase the maximum height to 9.15 metres.
	The maximum height shall be 9.0 metres.	, and the second

How do I participate if I have comments or concerns?

Submit written correspondence

Although there are no third-party appeal rights, you are entitled to notice and may make written submissions before the application is considered by the Committee of Adjustment. You can send your written comments regarding the application by email (preferred) or regular mail to the Secretary-Treasurer noted below. Include your name, address and application number or address of the property in which you are providing comments. To allow all Committee of Adjustment members the opportunity to review and consider your comments, please provide your written submissions to be received no later than noon the day before the hearing date.

Please be advised that any written correspondence submitted to the Town of Oakville regarding this application will be made public pursuant to the *Planning Act* and *Municipal Freedom of Information and Protection Act*.

Participate in the electronic hearing by videoconference.

Pre-register as a delegation by contacting the Secretary-Treasurer noted below by email or telephone no later than noon the day before the hearing date. You are encouraged to pre-register as a delegation as soon as possible in order to facilitate an orderly registration process. Pre-registered delegates will be provided with access codes and instructions to enter the electronic hearing.

Watch the hearing:

If you do not wish to participate, but would like to follow along, the hearing will be publicly live-streamed on the Town of Oakville's Live Stream webpage at oakville.ca. The live-stream will begin just before 7 p.m.

More information:

Town departments and agency comments regarding this application will be available online at <u>Agendas & Meetings (oakville.ca)</u> by noon on the Friday before the hearing date.

Notice of decision:

If you wish to be notified of the decision for this application, you must make a written request by email or regular mail to the Secretary-Treasurer noted below. The written request must be received before noon the day before the hearing date. This will entitle you to be notified of any future Ontario Land Tribunal proceedings.

Contact information:


Jennifer Ulcar Secretary-Treasurer of Committee of Adjustment 1225 Trafalgar Road Oakville, ON L6H 0H3 Phone: 905-845-6601 ext. 1829

Email: coarequests@oakville.ca


Date mailed:

October 29, 2024



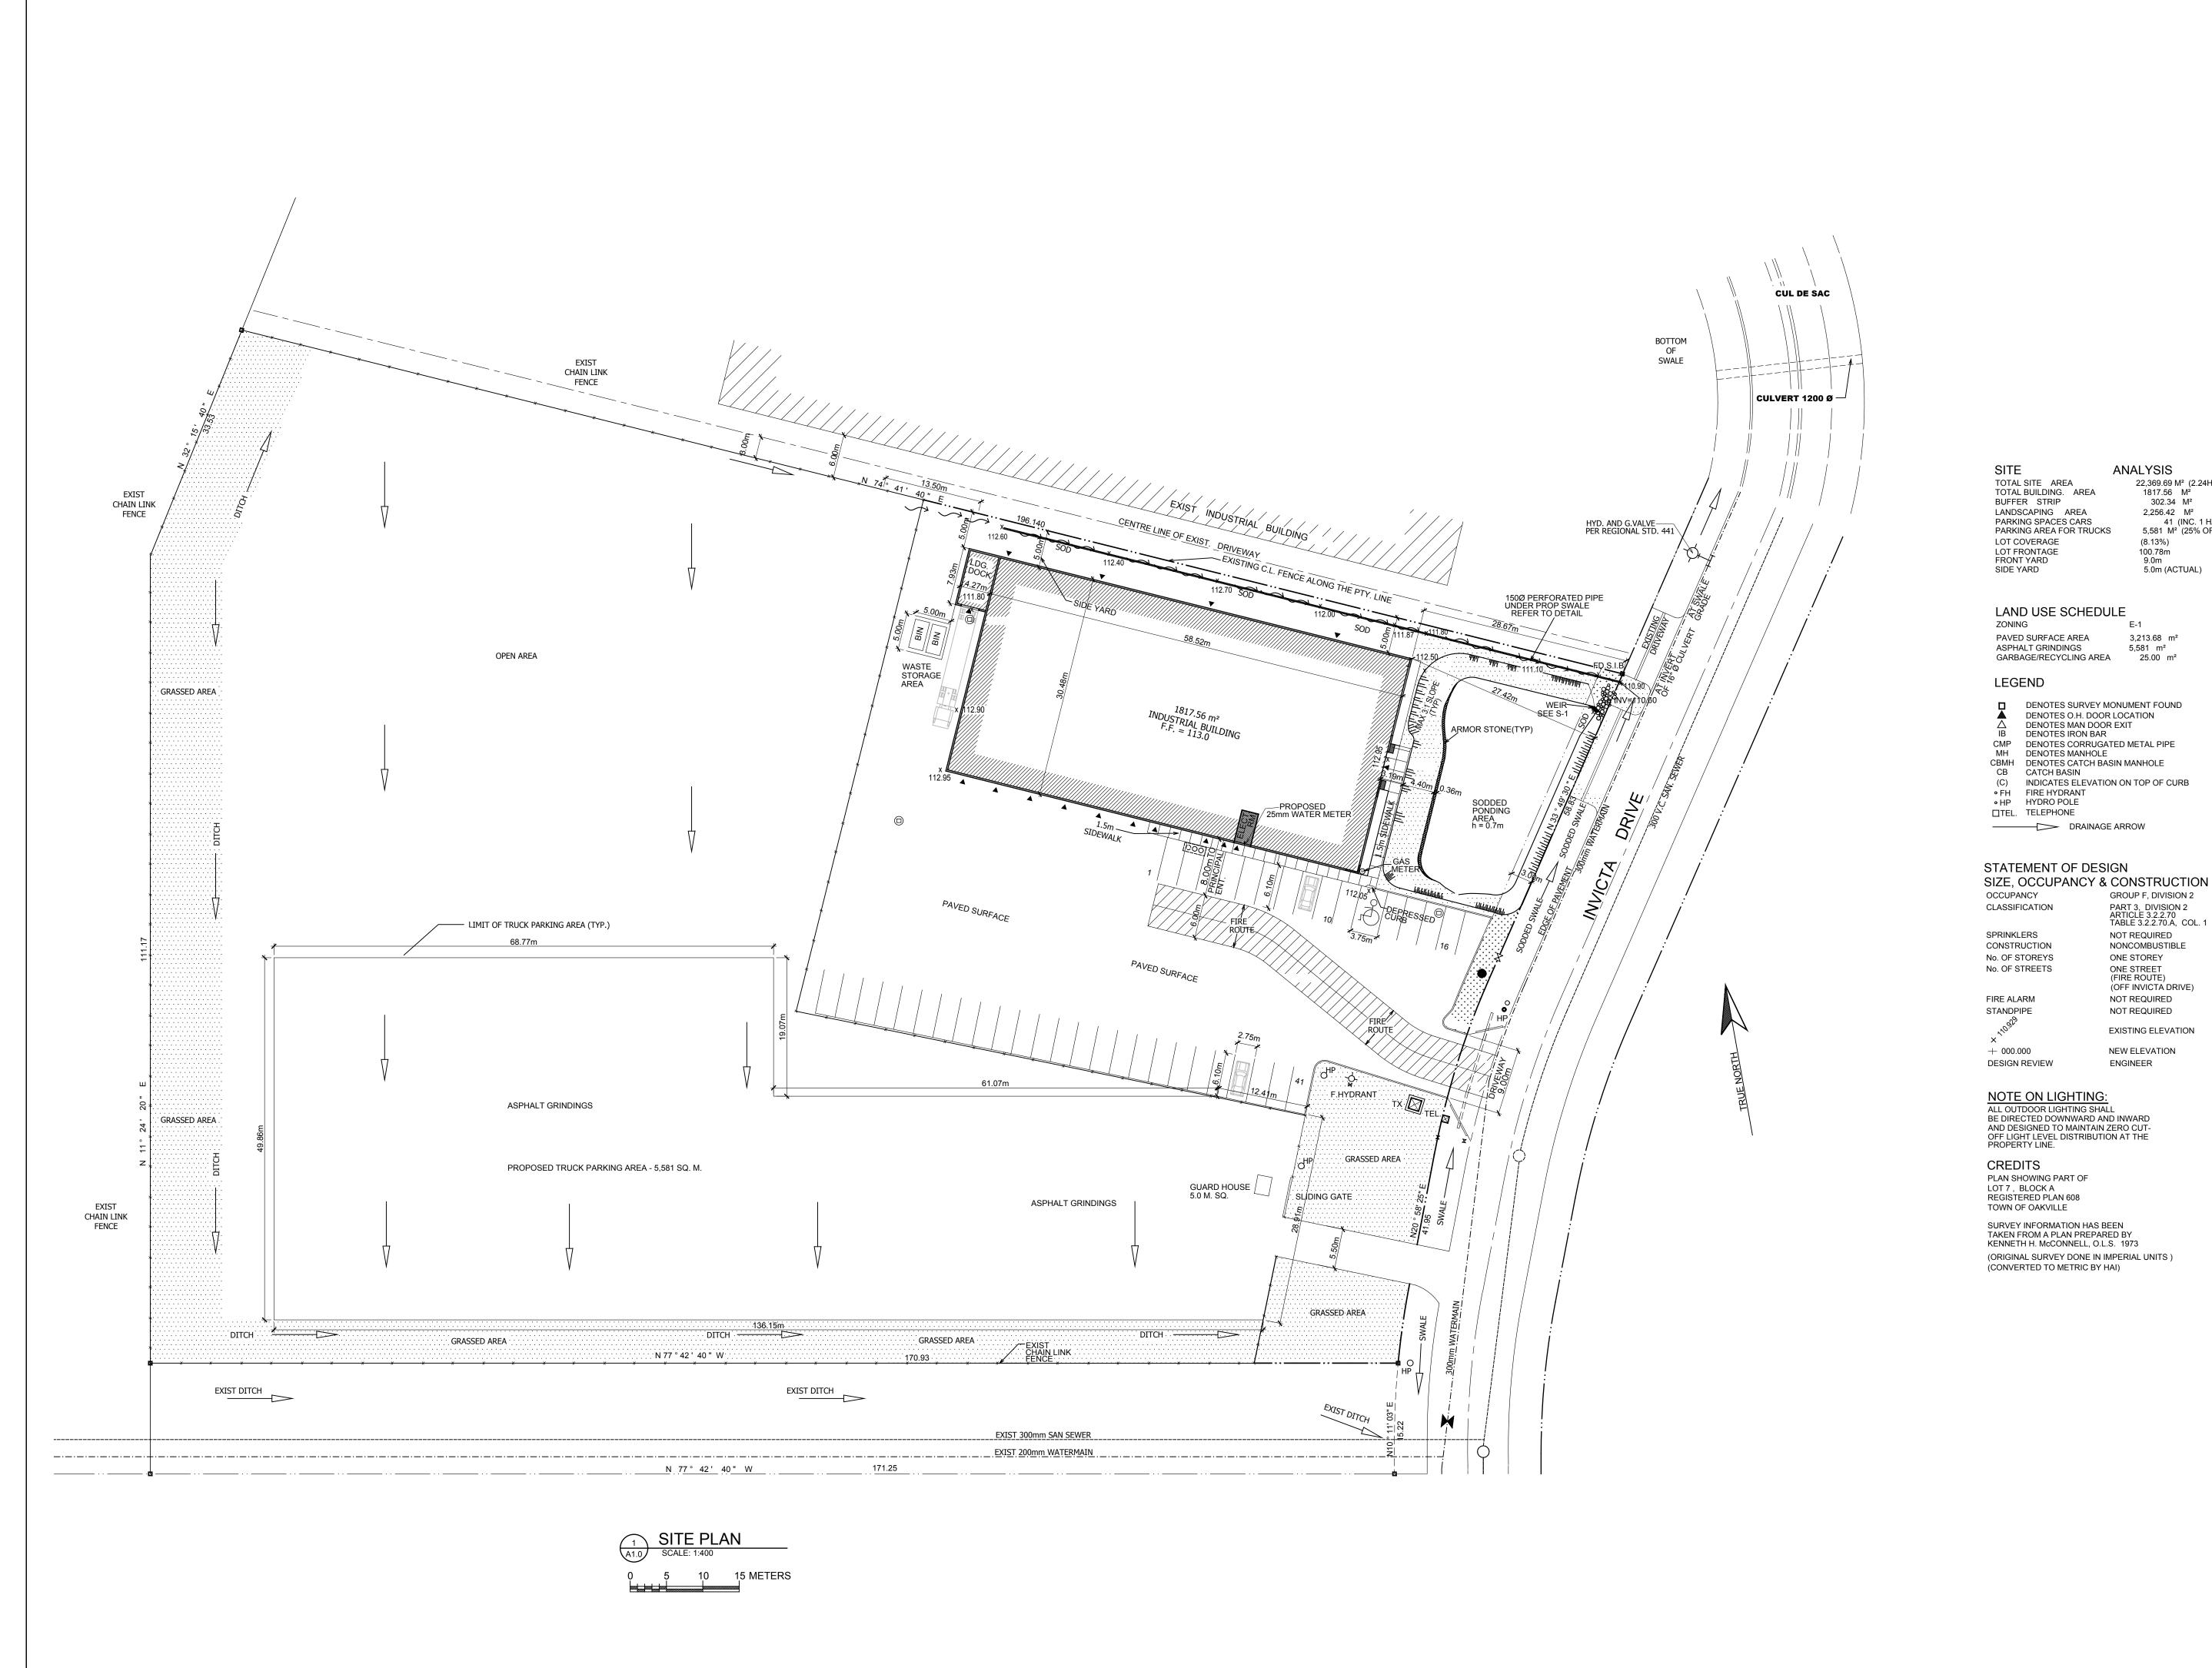

KEY PLAN

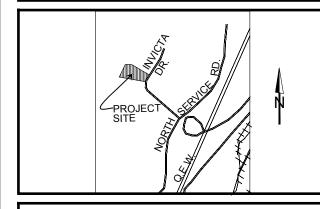

CONTRACTOR TO VERIFY ALL DIMENSIONS AND REPORT ANY DISCREPANCIES TO THE DESIGNER BEFORE COMMENCEMENT OF WORK. WORK NOT TO PROCEED UNTIL ALL APPROPRIATE PERMITS HAVE BEEN OBTAINED DO NOT SCALE DRAWINGS.

REVISIONS

	NO	DATE	DESCRIPTION	REV.BY
	1	15JULY24	MODIFY PROPOSED TRUCK PARK. AREA A/P TOWN	DH
VALYSIS 22,369.69 M² (2.24HA). 1817.56 M² 302.34 M² 2,256.42 M² 41 (INC. 1 HANDICAPPED PARKING 5,581 M² (25% OF TOTAL SITE AREA) (8.13%) 100.78m 9.0m 5.0m (ACTUAL) 3.0m (REQUIRED)				

ISSUED

NO	DATE	DESCRIPTION
1	15JULY24	FOR REVIEW

hawley and associates inc



NEW ELEVATION ENGINEER

ANALYSIS

3,213.68 m² 5,581 m²

GROUP F, DIVISION 2

NOT REQUIRED

NOT REQUIRED NOT REQUIRED

ONE STOREY ONE STREET (FIRE ROUTE)

NONCOMBUSTIBLE

(OFF INVICTA DRIVE)

EXISTING ELEVATION

PART 3, DIVISION 2 ARTICLE 3.2.2.70 TABLE 3.2.2.70.A, COL. 1

PROJECT - PROPOSAL PARKING

SITE PLAN

INDUSTRY DIESEL & TURBO SERVICE LTD

DRAWING NO. AS NOTED 3JULY2023 DRAWN BY PLOT DATE 3JULY2023 CHECKED BY PROJECT NO. 23007

1015 INDUSTRY ST. OAKVILLE, ONTARIO



October 7, 2024 24P02

Kelly Lanaus, CPT
Senior Zoning Plans Examiner
Building Department
Town of Oakville
1225 Trafalgar Road
Oakville, ON L6H 0H3

Dear Kelly,

RE: PLANNING RATIONALE – REVISED APPLICATION FOR MINOR VARIANCE

Town Application/File No. CAV A/074/2024

1140 Invicta Drive
Town Of Oakville

We are planning consultants to 1600767 Ontario Limited (the "Applicants") who own 1140 Invicta Drive (the "Subject Lands"). We submitted the original application April 8, 2024, and at its May 15th hearing the Committee of Adjustment granted a deferral to allow further discussions with Staff. We now submit a revised minor variance application for the Committee's consideration which, in our opinion, reflects these discussions and works to address the concerns expressed by staff.

Specifically, the Applicant has significantly reduced the size of the parking area, and we hereby amend the application to request this existing parking be allowed to persist as a "Parking Area, Heavy Vehicle" despite it not being accessory to the primary use on the property. The revisions are explained in further detail below.

In our opinion, the revised requested variance meets all the tests under Section 45(1) of the Planning Act and represents good land use planning.

THE REVISED MINOR VARIANCE

In the original submission, the Applicant sought permission to allow the continued use of the parking area as a "Motor Vehicle Storage Compound", whereas such a use was not permitted in the E2 zone.



However, further to our discussions with Staff, and further to several physical changes to the parking area (including a substantial reduction in its size), we are revising the application to seek the continued use of the parking area as a "Parking Area, Heavy Vehicle" despite it not being accessory to the primary use.

THE SUBJECT LANDS & PURPOSE OF THE APPLICATION

Purpose Of The Application

As mentioned, the purpose of the application is to permit the continued use of a portion of the Subject Lands as a storage/parking area for truck-tractors by Musket Transport Ltd. ("Musket") who are leasing the lands from the Applicant.

As described in our initial submission, the Applicant and Musket erroneously constructed and started using the truck parking area without first securing the appropriate zoning relief from the Town. The purpose of this application, and of the revisions now being submitted, are to rectify this and seek the appropriate zoning relief.

Surrounding Context

Please refer to our April 8, 2024, letter for a description of the surrounding context.


Staff Concerns & The Changes Made To Address Them

The revised parking area has been reduced to comply with all standards applicable to a "Parking Area, Heavy Vehicle", except for the fact that it is not accessory to the primary use. Specifically:

- The parking area has been reduced so that it occupies no more that 25% of the lot area;
- The parking area is located in the rear yard and interior side yard;
- The parking area is setback more than 3.5m from all lot lines;

A copy of the revised site plan is enclosed with this submission.



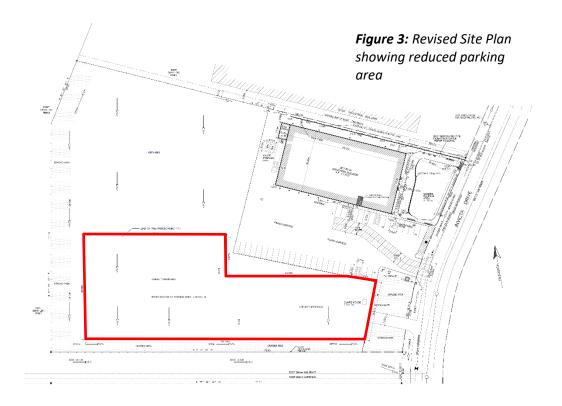

A key concern of Town Staff with the original submission was the size of the parking area and potential impacts arising from its size. The size of the parking area has been significantly reduced. Likewise, we note that an opinion letter from HGC Engineering was submitted with the original application which assessed potential noise impact from the original, larger, parking area. That report concluded that, given background sound levels from traffic noise from the surrounding roadways, noise impacts upon residences along Falgarwood Road from the parking area will be minimal. Any potential noise from the much smaller parking area will be even less.

Staff also expressed concern that they had not previously been given the opportunity to review the site changes in more detail before the parking area was built. A key purpose of this application is to rectify that. The Applicant has expressed in their discussions with Staff an openness to review such things as appropriate screening and a review of site grading, either via conditions of approval of the requested variance, and/or during the review of any subsequent permits that may be required.



We Disagree With Staff's Assertion This Is A "Transportation Terminal"

The Applicant's original submission characterized the parking area as a "Motor Vehicle Storage Compound" and sought a minor variance to permit this use on the Subject Lands. In our opinion, this use description appropriately reflected the nature of the use proposed at the time — i.e., the parking/storage of vehicles within a fenced-in and secured compound — and the size of the facility and the fact that it was not accessory to the primary use — i.e., the parking area was leased from the Applicant and used by Musket.

However, Town Staff believed the use should be characterized as a "Transportation Terminal". We disagree.

By-law 2014-14 defines a "Transportation Terminal" as:

"...a premises or area of land used for storing, parking or dispatching of buses, trucks, tractors, or trailers, including servicing or repair within an enclosed building."

This is an exceptionally broad definition which, if not interpreted judiciously, might encapsulate nearly any area used to park commercial vehicles. Musket operates three different transportation terminals within the GTA, the two closest of which are at 2215 Royal Windsor Drive and 556 Southdown Road in Mississauga. These terminals are different than the parking area on the Subject Lands. Firstly, in our opinion, a key word in the definition is "dispatching" – particularly as this word would apply to the distribution of goods or materials from a Transportation Terminal. "Dispatching" in this context typically refers to the orderly organizing and sending off of assembled tractor/trailers on their established delivery routes. Secondly, a key point is to note the various elements that work together to define a Transportation Terminal – i.e. the fact that vehicles and trailers are parked, stored, assembled and dispatched all on the same property, and there are typically concurrent office and service/repair/inspection facilities. The combination of these elements functioning together on the same property work to differentiate a Transportation Terminal from a simple parking area or storage compound.



However, a "Parking Area, Heavy Vehicle" is defined as:

"...an area on a lot for the accessory parking for trucks, tractors and commercial vehicles exceeding a gross weight of 4,500.0 kilograms, as licensed by the Ministry of Transportation, in association with the primary use of the lot."

A Parking Area, Heavy Vehicle is permitted as-of-right on the Subject Lands, so long as it is accessory to the primary use. We acknowledge that the parking area on the Subject Lands is not accessory to the primary use. It is leased and operated by Musket. Permission to allow a non-accessory Parking Area, Heavy Vehicle is the relief the Applicant is seeking.

Musket is a full-service intermodal transportation company offering numerous transportation, warehousing, and distribution services to a wide variety of industry sectors across North America. They maintain a fleet of 200+ truck tractors, 300+ trailers, and 500+ chassis used to transport shipping containers. All equipment is corporately owned, and all drivers are employees of the company. They operate three different transportation terminals within the GTA and have recently opened a fourth in Burlington. But the parking area on the Subject Lands is not one of them. Rather, the closest terminals are located at 2215 Royal Windsor Drive and 556 Southdown Road in Mississauga, as well as the new terminal at 1151 Heritage Road in Burlington. Musket is a bonded carrier and security is paramount to their operations. We understand that to maintain their security and bonded status, Musket must park all truck-tractors separately from all trailers within a secured compound when not in use. The parking area on the Subject Lands is used by Musket to park their truck-tractors. Trailers and goods for distribution are not parked or stored there. Rather, these are stored at Musket's transportation terminals. Musket's drivers must first collect a truck tractor from the parking area on the Subject Lands, then drive it to one of the Transportation Terminals where they are mated to a trailer then dispatched on their respective delivery route. Each truck tractor is returned to the parking area after the delivery is compete and its trailer has been returned to the Transportation Terminal to be made ready for the next delivery. The parking area on the Subject Lands is simply where the truck tractors are parked/stored in between deliveries. The parking area is kept clean, fenced, and guarded at all times.



The parking area on the Subject Lands, as revised with this submission, now functions the same as one permitted as-of-right – the only difference being the fact it is leased and operated by a different user than the Applicant. The Applicant commits to ensuring that the parking area meets all other applicable zoning standards (i.e. size/lot coverage, setbacks, landscaping, etc.).


OFFICIAL PLAN AND ZONING

The Subject Lands are designated **Business Employment** in Town's Official Plan. There are no applicable Secondary Plans or Site-Specific Policies. The Business Employment area is buffered from the adjoining residential lands in Falgarwood by a Natural Area designation relating to Morrison Creek.

The Subject Lands are zoned **Employment – E2 sp:3** by Zoning By-law 2014-014. The E2 zone permits a wide variety of employment, commercial, manufacturing, and warehousing uses. Heavy vehicle parking and outdoor storage is permitted as an accessory use. Special provision 3 also allows an extended list of motor vehicle related uses, including motor vehicle body shops, repair facilities and dealerships.





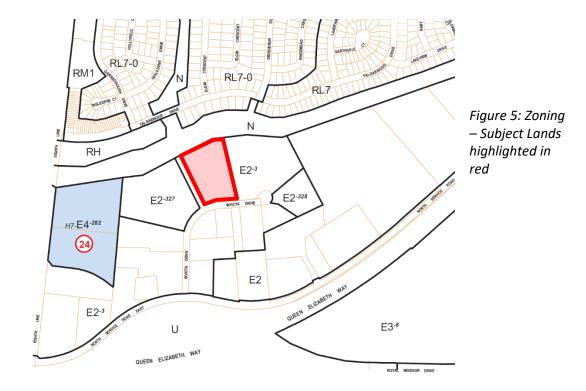

THE REQUESTED VARIANCE

The Applicant is seeking only one minor variance:

 To permit a non-accessory Parking Area, Heavy Vehicle, whereas Sections 10.2(18) and Part 3 of Bylaw 2014-014 state a Parking Area, Heavy Vehicle is permitted only as an accessory use to another permitted use.

THE PROPOSED VARIANCE SATISFIES THE FOUR (4) TESTS UNDER THE PLANNING ACT

In our opinion, the requested variance meets the four (4) tests under Section 45(1) of the *Planning Act*:

The Proposed Variance Meets The General Intent & Purpose Of The Official Plan:

The Official Plan's Business Employment designation allows employment uses predominantly within enclosed buildings and provides for office uses and light and service industrial operations with minimal impacts on surrounding



areas.¹ Permitted uses include light industrial uses such as manufacturing, assembling, processing, fabricating, repairing, warehousing and wholesaling². Motor vehicle related uses are also permitted between Iroquois Shore Road (including the proposed extension) and the North Service Road, west of Invicta Drive.³ Outdoor storage uses are anticipated and are to be adequately screened and may be implemented through zoning⁴ but are not to be allowed on lands that abut residential areas.⁵

We note the Applicant's existing industrial use is permitted in a Business Employment designation, and that the Subject Lands are separated and buffered from the low-density Falgarwood neighbourhood by the Natural Area designation relating to Morrison Creek.

A Parking Area, Heavy Vehicle is already permitted as an accessory use, and the Town has determined that such parking areas comply with the Business Employment designation. Although the proposed parking area will not be accessory to the Applicant's existing industrial operation, they have committed to ensuring that it will comply with all other performance standards, in terms of size, setbacks, landscaping, screening, etc. The parking area will function just as an as-of-right one, except that Musket will operate it. The leasehold tenancy of the parking area is a minor difference and will not result in a functionally different parking area.

The general intent and purpose of the Official Plan will be maintained.

<u>The Proposed Variance Meets The General Intent And Purpose Of The Zoning By-</u> Law:

We note again that the Applicant seeks relief only from the fact that the parking area will not be accessory to the primary use - i.e. the Applicant has leased the area to Musket. Functionally and physically, it will operate no differently than an as-of-right parking area.

The general intent and purpose of allowing a Parking Area, Heavy Vehicle is to recognize such outdoor/storage functions are not uncommon in industrial areas like that within which the Subject Lands are located, and that such operations should be

¹ Livable Oakville – Policy 14.4

² Ibid. – Policy 14.4.1(a)

³ Ibid. – Policy 14.4.1(e)(iii)

⁴ Ibid. – Policy 14.4.4

⁵ Ibid. – Policy 14.4.5



limited in scope. This is reinforced by the various performance standards the parking area must comply with:

- The parking area can occupy no more than 25% of the Subject Land's lot area⁶
- The parking area can only be in an interior side yard or rear yard and shall be setback no less than 3.5m from any lot line⁷
- Despite the 3.5m setback provision, there must be a minimum 7.5m wide landscaping strip between the parking area and any interior side lot line and any rear lot line⁸
- Any Gatehouse must be no more than 3.0m in height and not exceed 5.0m² in floor area⁹
- The parking area cannot be in a yard that abuts a Residential, Institutional or Community Use zone¹⁰

The Applicant seeks relief only from the accessory nature of the Parking Area, Heavy Vehicle permission. All other zoning requirements will be complied with.

The general intent and purpose of the zoning by-law will be maintained.

<u>The Proposed Variance Is Appropriate For The Development Or Use Of The Lands:</u>

Allowing the existing parking area to continue represents a modest zoning change which would allow a significant employer and important part of the Province's industrial base to continue. The existing industrial area is very well established having served the Town's and broader provincial economy for decades. The requested use is in keeping with the existing and planned context and reflective of other similar uses in the area. The existing parking area results in no additional impacts over and above what an as-of-right Parking Area, Heavy use would offer.

As such, the requested variance is appropriate for the development or use of the lands.

⁶ By-law 2014-014 - Provision 10.6(b)(iii)

⁷ Ibid. – Provision 10.6(a)

⁸ Ibid. - Provision 4.11.2, Table 4.11.2 Row 7

⁹ Ibid. – Provision 10.4

¹⁰ Ibid. – Provision 10.6(e)



The Proposed Variance Is Minor:

The test of whether a variance is minor consists of three parts – Impact, size, and importance.

In terms of impact, the parking area will function no differently and have no greater impact than an otherwise permitted as-of-right accessory parking area. Noise levels are in keeping with currently permitted uses. We note a noise assessment from HGC Engineering was submitted as part of the original (and larger) proposal, which concluded that there was minimal impact from the larger parking area. The reduced parking area will have even less of an impact.

Size refers to the scale of the variance itself. In this case the Applicant is only requesting relief from the accessory nature of the as-of-right permission. All other zoning standards will be complied with. This is a modest change that would result in no difference on the ground from what could already happen as-of-right.

Importance refers to whether it is appropriate to seek the required relief via minor variance or whether a full zoning amendment is necessary. In our opinion, given the nature of the requested zoning relief, a full zoning amendment is not required.

The requested variance is minor.

In summary, the requested variance satisfies all four (4) tests of Section 45(1) of the *Planning Act* and represents good land use planning.

Yours very truly,

Adrian Litavski, MCIP RPP

Johnston Litavski

905-845-7325 ext. 223 litavski@planners.to

Notice of Public Hearing Committee of Adjustment Application



File # CAV A/074/2024 - Deferred from May 15, 2024

Electronic hearing:

By videoconference and live-streaming video on the Town of Oakville's Live Stream webpage at <u>oakville.ca</u> on November 13, 2024 at 7 p.m.

Why am I receiving this notice?

You are receiving this notice because the applicant noted below has submitted a minor variance application to the Town of Oakville. As stipulated by the *Planning Act*, notice must be provided to property owners within 60 metres (200 ft.) of the area to which the application applies. Further details of this application, including drawings, can be viewed online at Agendas & Meetings (oakville.ca).

Applicant and property information:

Applicant / Owner	Authorized Agent	Subject Property
1600767 Ontario Limited	JOHNSTON LITAVSKI LTD. (ADRIAN LITAVSKI) 235 Lakeshore Road East, Suite 202 Oakville, ON L6J 1H7	1140 Invicta Dr PLAN 608 PT LOT 7 RP 20R5425 PART 1

Zoning of property: E2 sp: 3, Business Employment

Variance request:

Under Section 45(1) of the *Planning Act*, the applicant is requesting the Committee of Adjustment to authorize a minor variance to permit heavy vehicle parking area on the subject property proposing the following variance(s) to Zoning By-law 2014-014:

No.	Current	Proposed
1	Part 3	
	Parking Area, Heavy Vehicle means an area on a lot for the accessory parking for trucks, tractors and commercial vehicles exceeding a gross weight of 4,500.0 kilograms, as licensed by the Ministry of Transportation, in association with the primary use of the lot.	To modify the definition of parking area, heavy vehicle to mean an area on a lot for the parking for trucks, tractors and commercial vehicles exceeding a gross weight of 4,500.0 kilograms, as licensed by the Ministry of Transportation.
2	Table 10.2, footnote 18	To permit heavy vehicle parking area as a primary
	Heavy vehicle parking area is permitted only	use.
	accessory to another permitted use.	

How do I participate if I have comments or concerns?

Submit written correspondence

Although there are no third-party appeal rights, you are entitled to notice and may make written submissions before the application is considered by the Committee of Adjustment. You can send your written comments regarding the application by email (preferred) or regular mail to the Secretary-Treasurer noted below. Include your name, address and application number or address of the property in which you are providing comments. To allow all Committee of Adjustment members the opportunity to review and consider your comments, please provide your written submissions to be received no later than noon the day before the hearing date.

Please be advised that any written correspondence submitted to the Town of Oakville regarding this application will be made public pursuant to the *Planning Act* and *Municipal Freedom of Information and Protection Act*.

Participate in the electronic hearing by videoconference.

Pre-register as a delegation by contacting the Secretary-Treasurer noted below by email or telephone no later than noon the day before the hearing date. You are encouraged to pre-register as a delegation as soon as possible in order to facilitate an orderly registration process. Pre-registered delegates will be provided with access codes and instructions to enter the electronic hearing.

Watch the hearing:

If you do not wish to participate, but would like to follow along, the hearing will be publicly live-streamed on the Town of Oakville's Live Stream webpage at oakville.ca. The live-stream will begin just before 7 p.m.

More information:

Town departments and agency comments regarding this application will be available online at <u>Agendas & Meetings (oakville.ca)</u> by noon on the Friday before the hearing date.

Notice of decision:

If you wish to be notified of the decision for this application, you must make a written request by email or regular mail to the Secretary-Treasurer noted below. The written request must be received before noon the day before the hearing date. This will entitle you to be notified of any future Ontario Land Tribunal proceedings.


Contact information:

Jen Ulcar Secretary-Treasurer of Committee of Adjustment 1225 Trafalgar Road Oakville, ON L6H 0H3 Phone: 905-845-6601 ext. 1829

Email: coarequests@oakville.ca


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SOUTH ELEVATION SCALE : | = 1'-0"

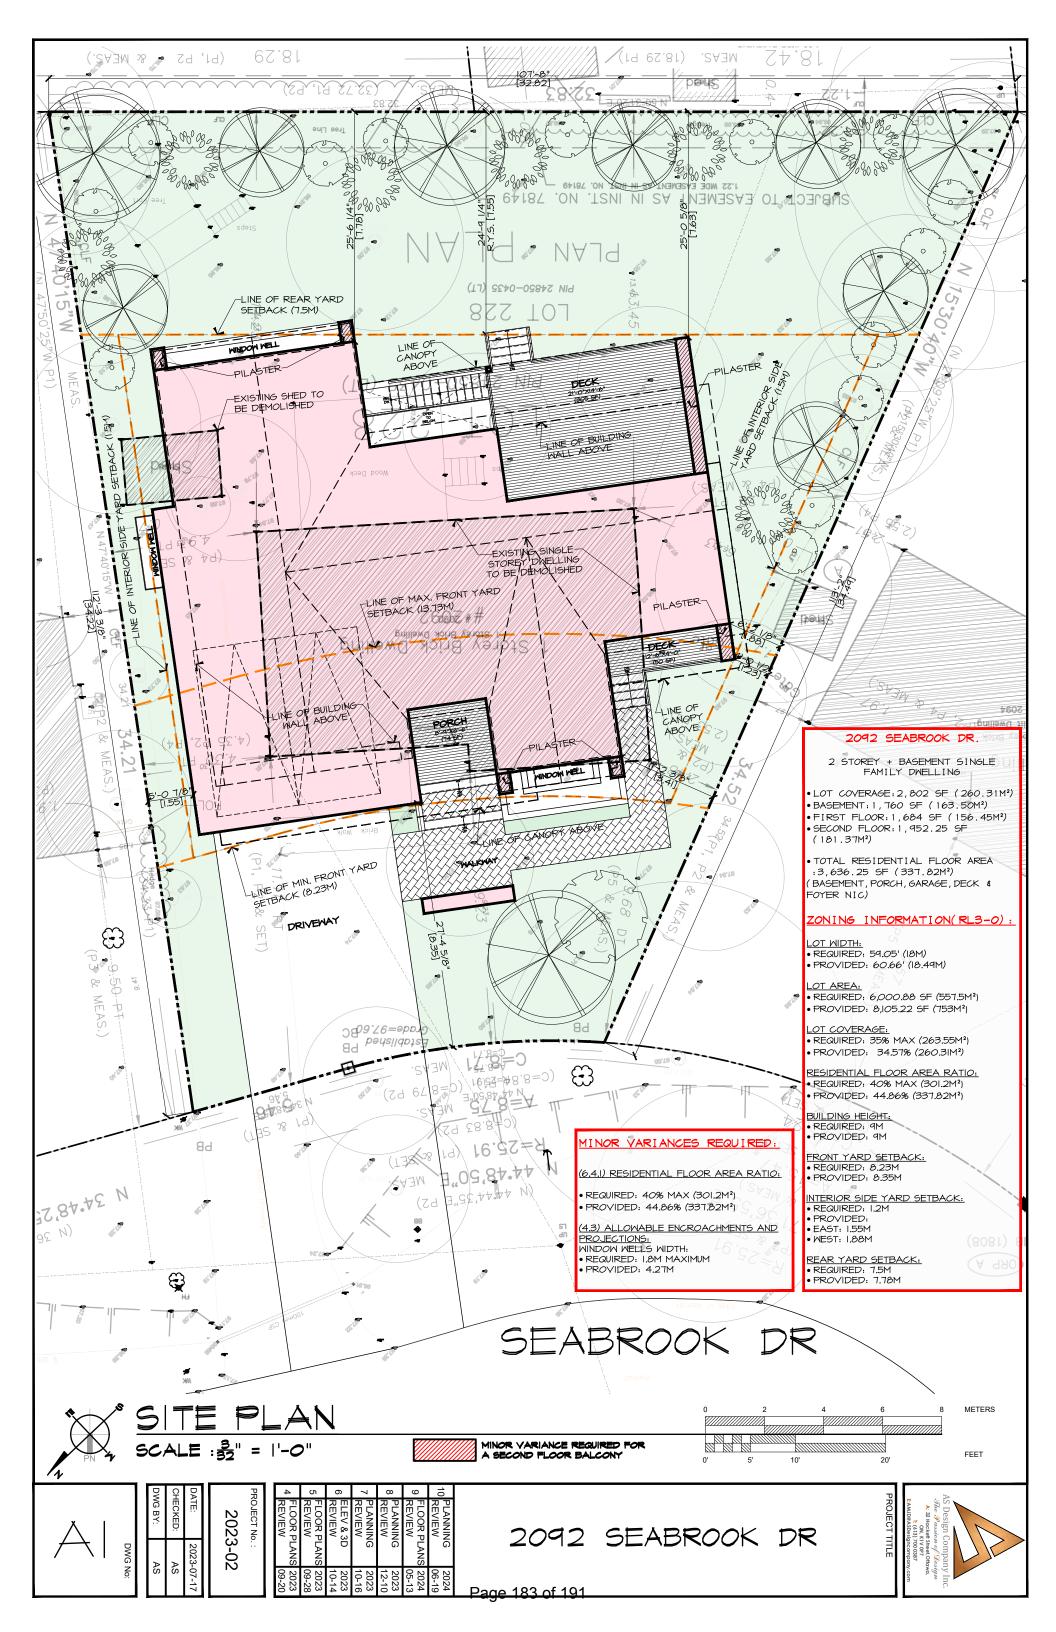


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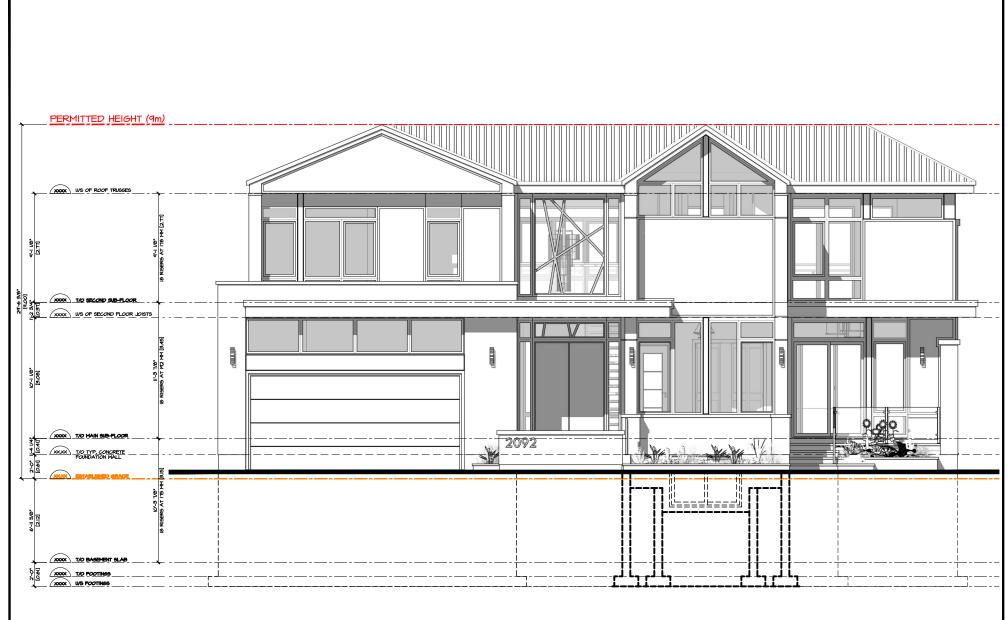


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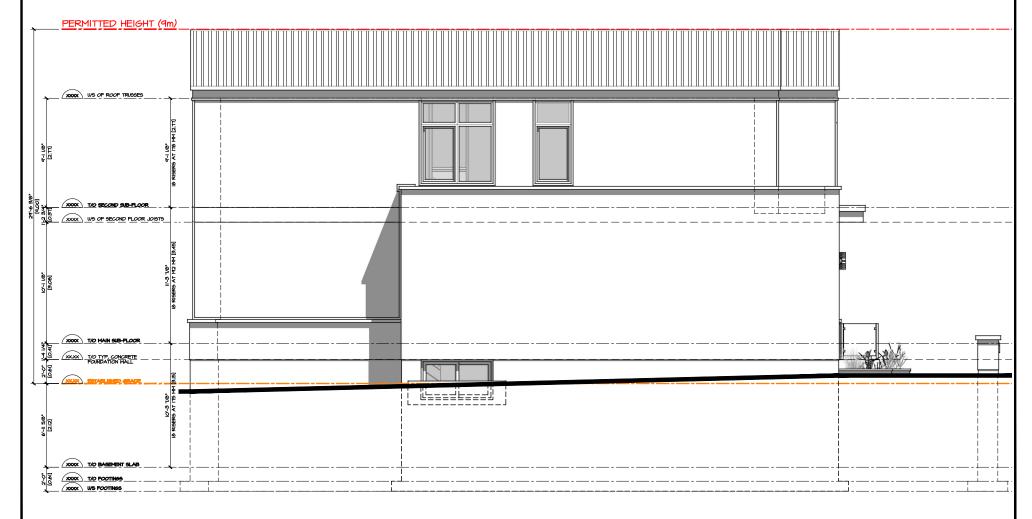
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NORTH ELEVATION SCALE: | = 1'-0"

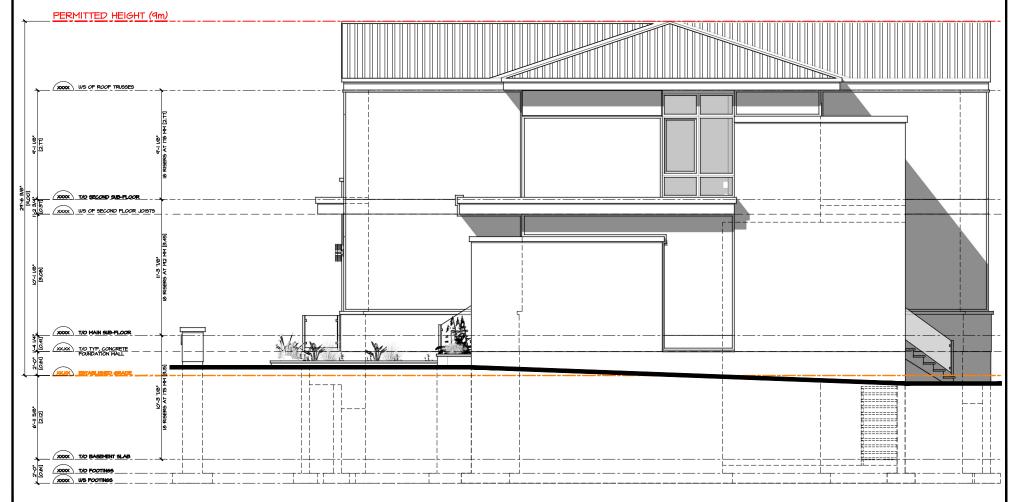

EAST ELEVATION SCALE : | = 1'-0"

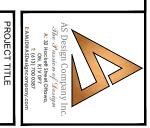

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NORTH PERSPECTIVE




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NORTH EAST PERSPECTIVE



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2092 SEABROOK DR SINGLE FAMILY DWELLING



AS DESIGN 32 HACKETT STREET, OTTAWA, ON, KIV 0P7 (613) - 7000387 www.ASDesignCompany.com

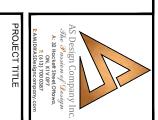10 2023-02

2024-06-19

2092 SEABROOK DR

RL3-0- RESIDENTIAL LOW

REV. NO.

PR. NO.

DATE

LOCATION

ZONING

Notice of Public Hearing Committee of Adjustment Application



File # CAV A/079/2024 - Deferred from October 2, 2024

Electronic hearing:

By videoconference and live-streaming video on the Town of Oakville's Live Stream webpage at <u>oakville.ca</u> on November 13, 2024 at 7 p.m.

Why am I receiving this notice?

You are receiving this notice because the applicant noted below has submitted a minor variance application to the Town of Oakville. As stipulated by the *Planning Act*, notice must be provided to property owners within 60 metres (200 ft.) of the area to which the application applies. Further details of this application, including drawings, can be viewed online at <u>Agendas & Meetings (oakville.ca)</u>.

Applicant and property information:

Applicant / Owner	Authorized Agent	Subject Property
M. Amin	Michael Barton	2092 Seabrook Dr
A. Amin	MB1 Development Consulting Inc 1489 Abbeywood Dr Oakville ON, CANADA L6M 2M6	PLAN 852 LOT 228

Zoning of Property: RL3-0, Residential

Variance Request:

Under Section 45(1) of the *Planning Act*, the applicant is requesting the Committee of Adjustment to authorize a minor variance to permit the construction of a two-storey detached dwelling on the subject property proposing the following variance(s) to Zoning By-law 2014-014:

No.	Current	Proposed				
1	Table 4.3 (Row 7) The maximum encroachment into a minimum	To increase the maximum encroachment into the minimum rear yard for the window well to 0.6 m with				
	yard for window wells with a maximum width of 1.8 metres shall be 0.6m.	a maximum width of 4.27 metres.				
2	Section 6.4.1 The maximum residential floor area ratio for a detached dwelling on a lot with a lot area between 743.00 m² and 835.99 m² shall be 40%.	To increase the maximum residential floor area ratio to 45.04%.				

How do I participate if I have comments or concerns?

Submit written correspondence

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regarding the application by email (preferred) or regular mail to the Secretary-Treasurer noted below. Include your name, address and application number or address of the property in which you are providing comments. To allow all Committee of Adjustment members the opportunity to review and consider your comments, please provide your written submissions to be received no later than noon the day before the hearing date.

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Contact information:

Jen Ulcar Secretary-Treasurer of Committee of Adjustment 1225 Trafalgar Road Oakville, ON L6H 0H3 Phone: 905-845-6601 ext. 1829

Phone: 905-845-6601 ext. 1829 Email: coarequests@oakville.ca

Date mailed:

October 29, 2024

